
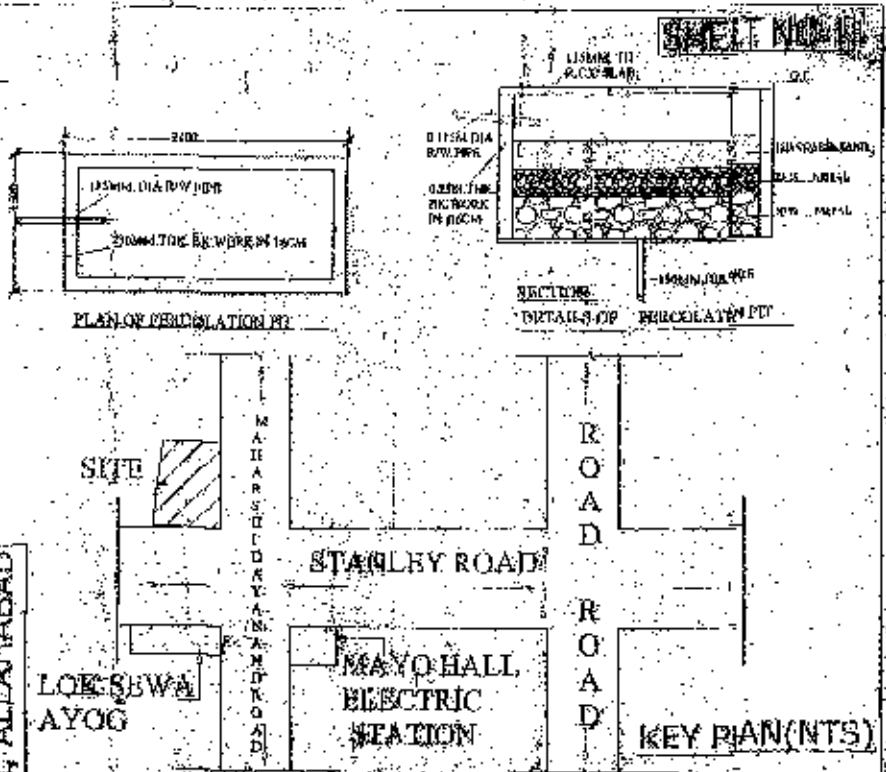


SITE NO. 126, CIVIL STATION, ALLAHABAD.

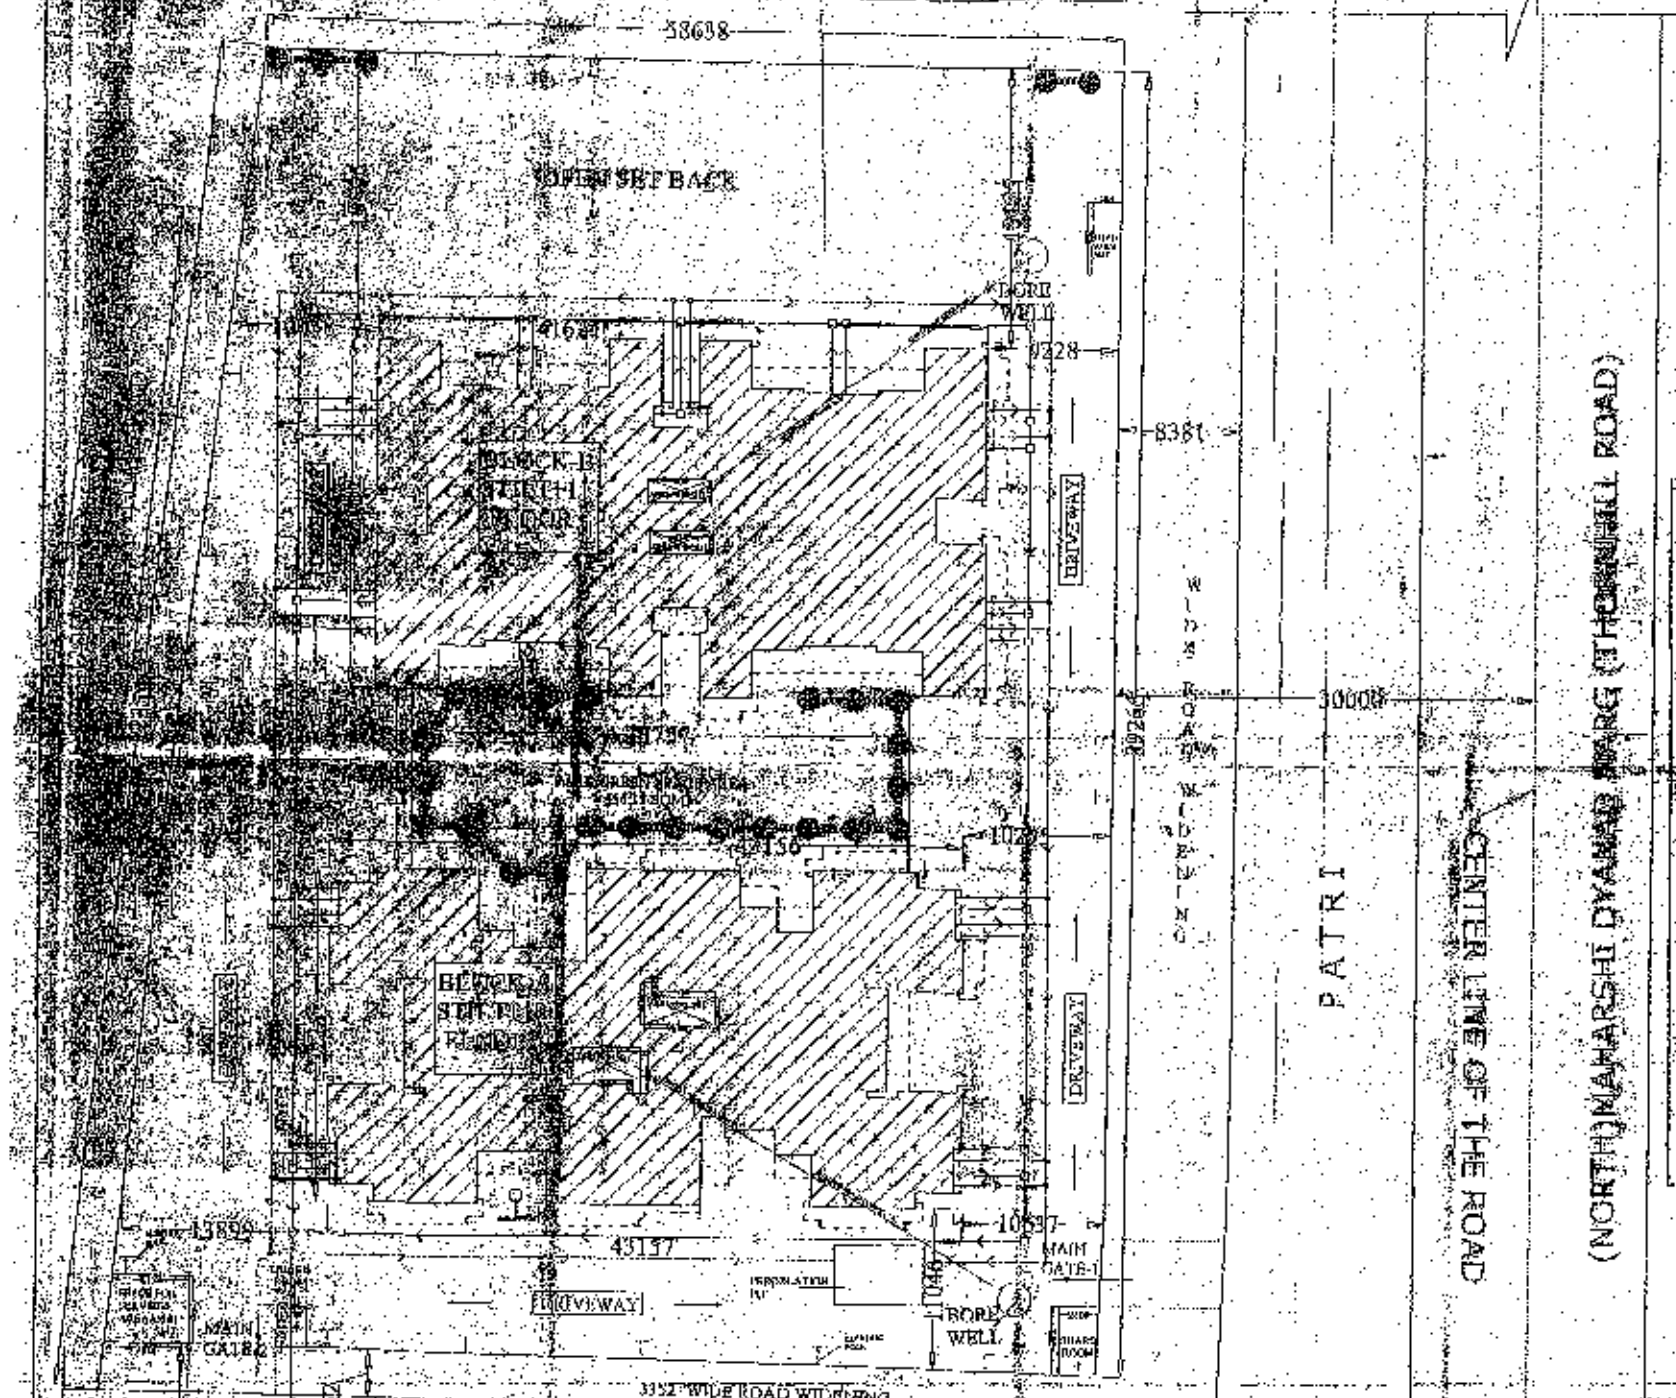

MAIN SEWER LINE
PATRI
ELECTRIC LINE
(EAST) KASTURBA GANDHI MARG (STANLEY ROAD)
CENTER LINE OF THE ROAD ± 0

PROPOSED SITE PLAN
SEWER, R/W HARVESTING LAYOUT
SCALE: 1:200

NOTE:-
SOIL PIPE =
RAIN W/H =
ELECTRIC POLE =

PROPOSED NOS. OF TREES = 29 NOS

NOTE:-
ALL DIMENSIONS ARE IN MM.

NO.	DESCRIPTION	QTY	UNIT	AMOUNT
1
2
3
4
5
6
7
8
9
10
11
12
13
14
15
16
17
18
19
20
21
22
23
24
25
26
27
28
29

PROPOSED APPROVED FOR HOUSING AT BUNGALOW.
ROAD OVER NAZUL NOW
STATION AT THE CORNER
AND MAHARSHI DAYANAND

PROPOSED SITE PLAN
SHEET TITLE


SHEET NO. - 1
SCALE: 1:200
M/S SANGAM STRUCTURALS LTD.
SHR. SHASHANI AGARWAL
S/O. LATE RAJEEV AGARWAL

OWNER
THIS IS CERTIFIED THAT BUILDING PLAN IS AS PER BY LAWS OF P.W.D. DEPT. ALLAHABAD
ARCHITECT

WEST SIDE NO. 125 CIVIL STATION, ALLAHABAD

SHEET NO. 2

SOUTH SITE NO. 125 A, 125 B, CIVIL STATION, ALLAHABAD

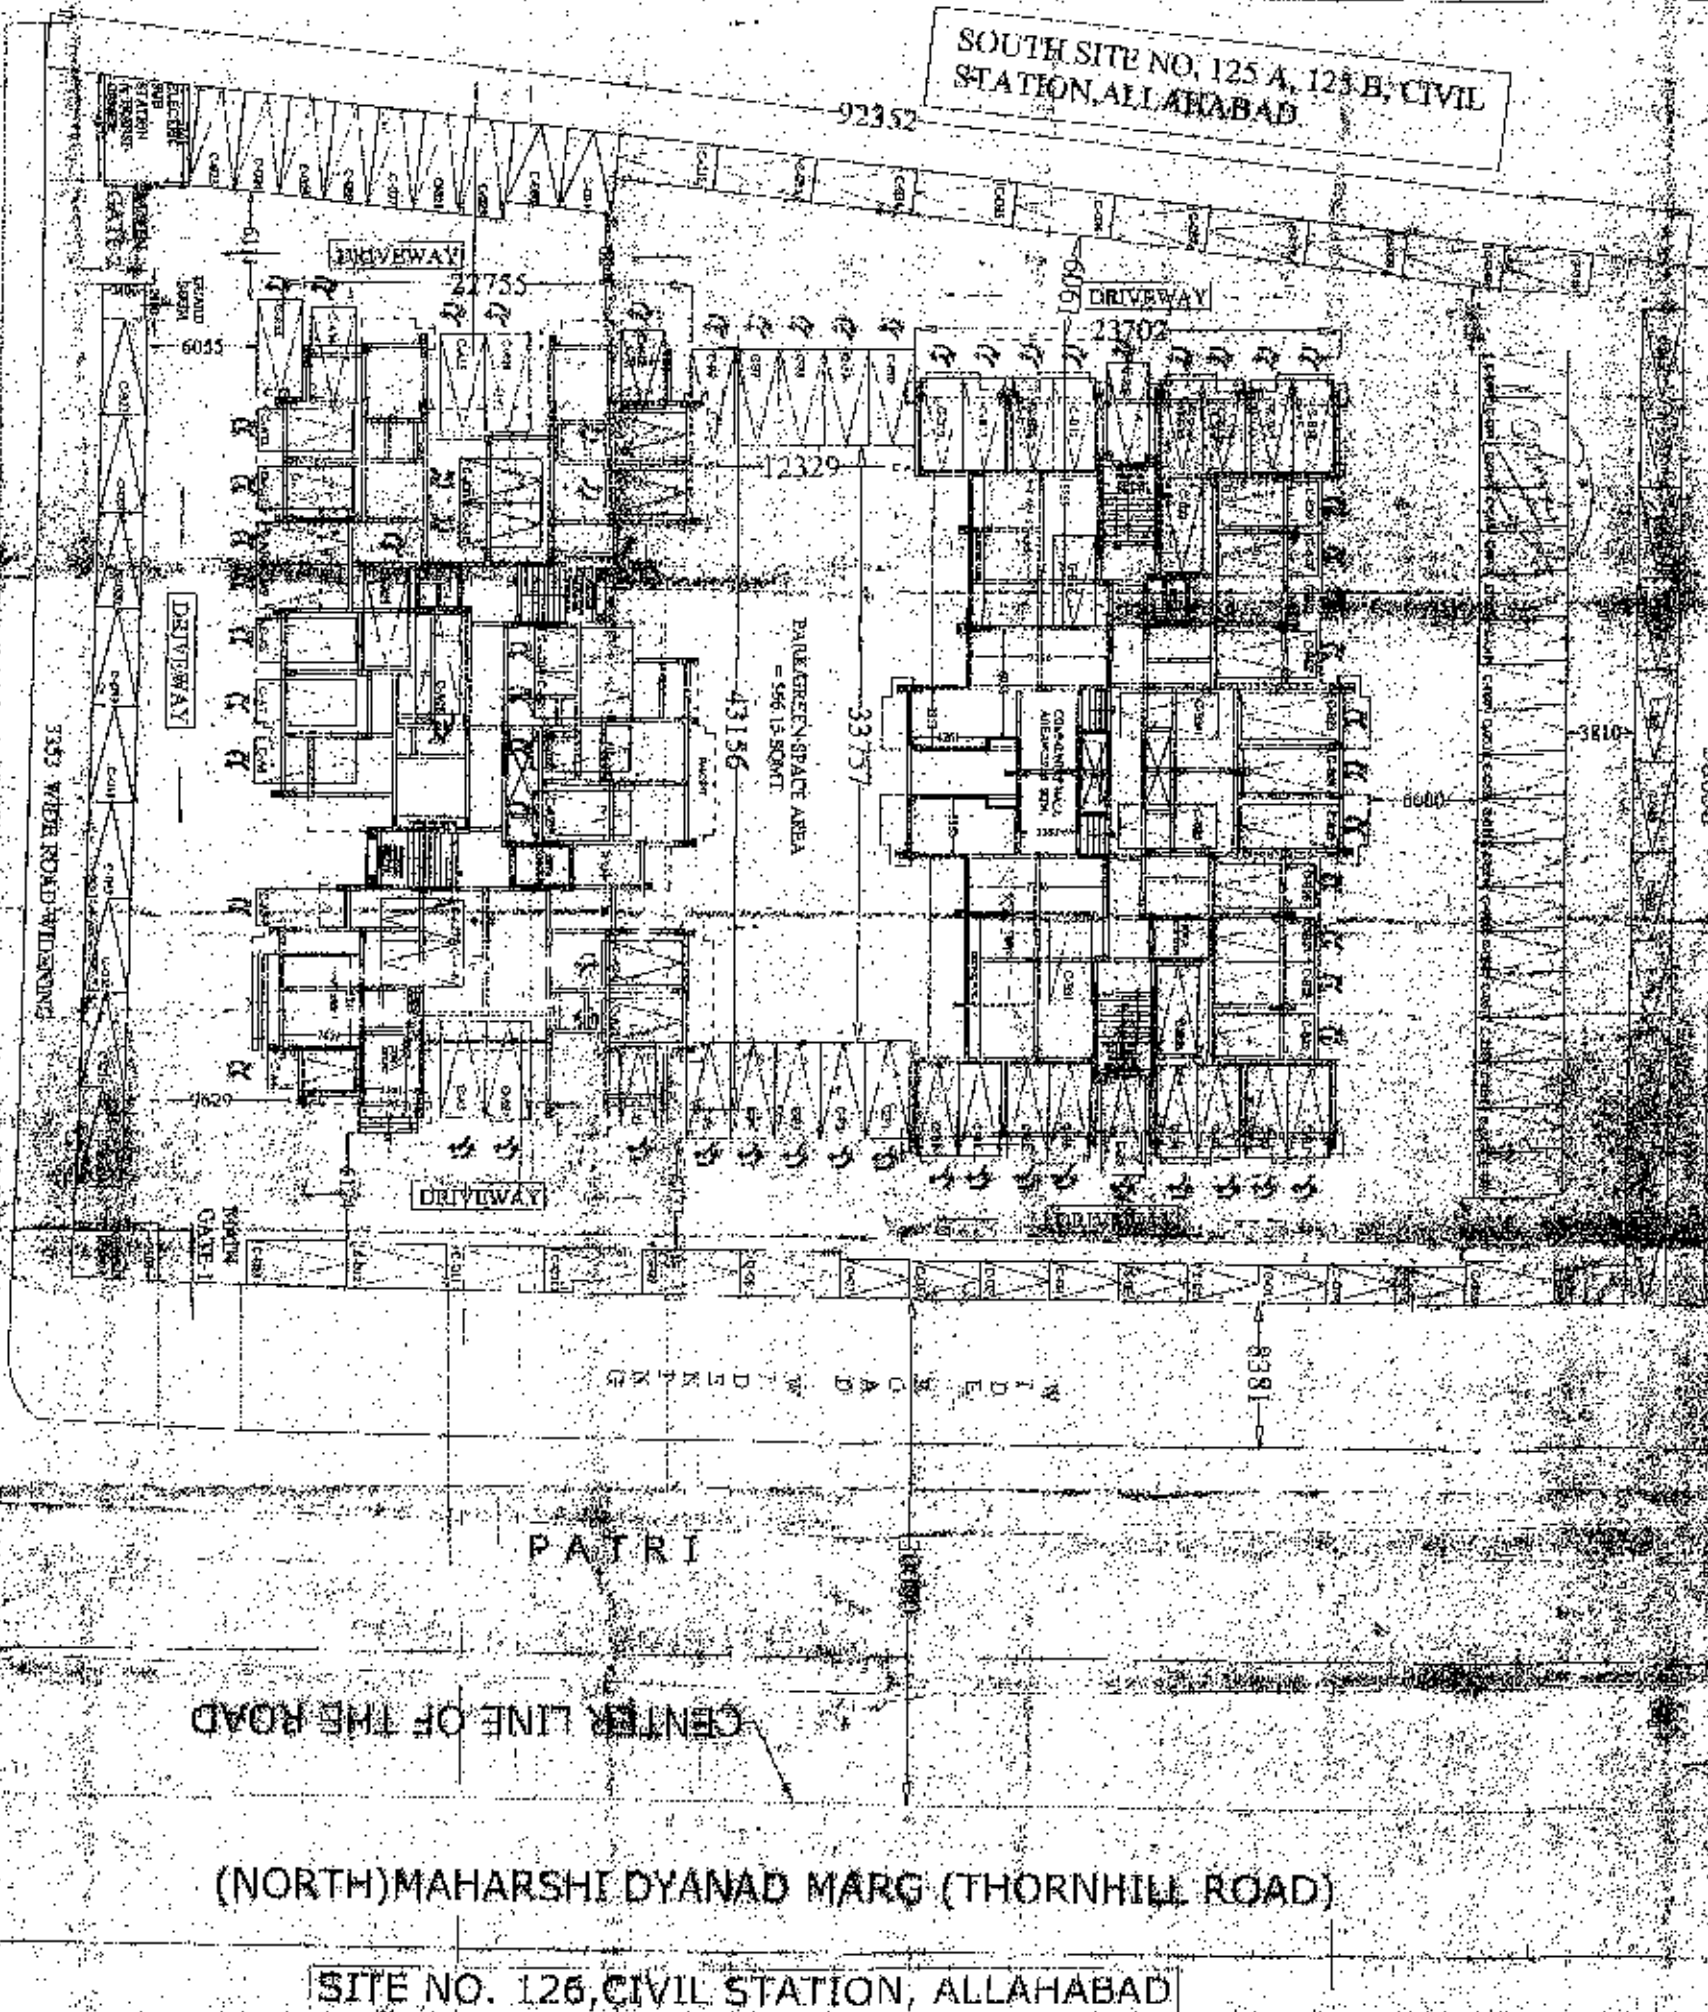

SITE NO. 126, CIVIL STATION, ALLAHABAD

CENTER LINE OF THE ROAD

(NORTH) MAHARSHI DYANAD MARG (THORNHILL ROAD)

(EAST) KASTURBA GANDHI MARG (STANLEY ROAD)
CENTER LINE OF THE ROAD

- 1) TOTAL NOS. OF PARKING AT COVERED BLOCK-A GROUND SITE (C-A) = 31 NOS.
- 2) TOTAL NOS. OF PARKING AT COVERED BLOCK-B GROUND SITE (C-B) = 35 NOS.
- 3) TOTAL NOS. OF PARKING AT GROUND NEAR PARK (C-P) = 10 NOS.
- 4) TOTAL NOS. OF PARKING AT GROUND OPEN (C-O) = 74 NOS.
- 5) GRAND TOTAL NOS. OF PARKING = 150 NOS.

**PROPOSED GROUND FLOOR
STILT PARKING LAYOUT PLAN
SCALE-1:200**

PROJECT - PROPOSED APPROXIMATE GROUND FLOORING AT BEHIND LOT NO. 125 CIVIL STATION, ALLAHABAD. THE SITE NO. 125 CIVIL STATION, ALLAHABAD. THE SITE NO. 125 CIVIL STATION, ALLAHABAD. THE SITE NO. 125 CIVIL STATION, ALLAHABAD.

GROUND FLOOR STILT PARKING LAYOUT PLAN


SCALE-1:200

DR. SANGHVI ARCHITECTS LTD.
101, SECTOR-14, GATEWAY INDIA, NEW DELHI-110028

DATE: 15/05/2018

PROJECT NO. 125/2018

DATE: 15/05/2018

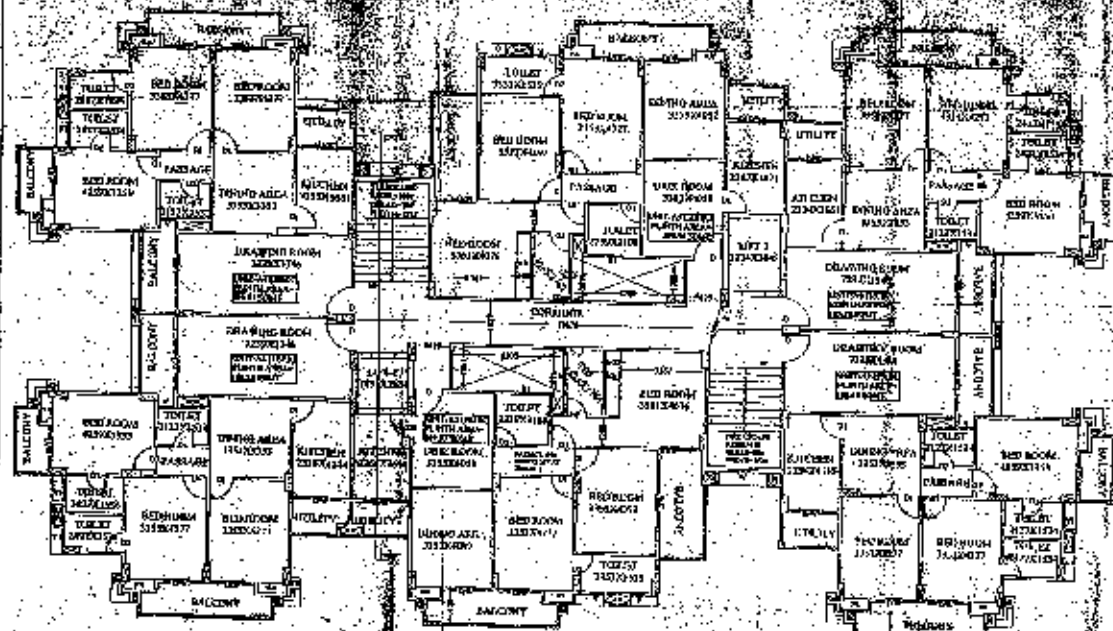

TYPICAL (1ST. TO 7TH.) FLOOR PLAN (BLOCK-A) SANCTIONED
SCALE-1:100

UNITS AREA PARTITION STATEMENT (1ST TO 7TH FLOOR)

S.NO	UNIT NO.	PRINC. U.I.A.R.	PLUMB AREA	NO. OF UNIT	TOTAL NOS. OF FLOOR	TOTAL NOS. OF UNIT	PARTITIONED AREA (SQ. FT.)
1	UNIT-01	30X40	1200	1	7	7	7000
2	UNIT-02	30X40	1200	1	7	7	7000
3	UNIT-03	30X40	1200	1	7	7	7000
4	UNIT-04	30X40	1200	1	7	7	7000
5	UNIT-05	30X40	1200	1	7	7	7000
6	UNIT-06	30X40	1200	1	7	7	7000
7	UNIT-07	30X40	1200	1	7	7	7000
TOTAL NOS. OF UNITS PROPOSED					7	7	49000

AREA STATEMENT (1ST TO 7TH FLOOR) (BLOCK-A)

S.NO	PARTICULAR	SCFT	SQM
1	PRO. BUILTUP AREA AT EACH FLOOR (BLOCK-A)	7774.30	722.25
2	PRO. TOTAL NOS. OF FLOORS	7.00	NOS.
3	PRO. GRAND TOTAL BUILTUP AREA (BLOCK-A) (MAX WITHIN FAR)	54420.09	5055.75
4	NOS. OF UNIT AT EACH FLOOR	3.00	NOS.
5	GRAND TOTAL NOS. OF UNITS (24)	42.00	NOS.

SCHEDULE OF OPENING (REF. FFL AS LVL. 0.0)


DOOR	SIZE	CILL	LINTEL	REMARKS
DW-1	1200 x 2100	100	100	
DW-2	1200 x 2100	100	100	
DW-3	1200 x 2100	100	100	
DW-100	1200 x 2100	100	100	

AREA UNITS STATEMENT (10TH FLOOR) (BLOCK-A)

S.NO	PARTICULAR	SCFT	SQM
1	PROPOSED BUILTUP AREA AT TENTH FLOOR (BLOCK-A)	6947.38	646.58
2	TOTAL NOS. OF UNIT AT TENTH FLOOR	8.00	NOS.

UNITS AREA PARTITION STATEMENT (10TH FLOOR)


S.NO	UNIT NO.	PRINC. U.I.A.R.	PLUMB AREA	NO. OF UNIT	TOTAL NOS. OF FLOOR	TOTAL NOS. OF UNIT	PARTITIONED AREA (SQ. FT.)
1	UNIT-10	30X40	1200	1	1	1	1200
2	UNIT-11	30X40	1200	1	1	1	1200
3	UNIT-12	30X40	1200	1	1	1	1200
4	UNIT-13	30X40	1200	1	1	1	1200
5	UNIT-14	30X40	1200	1	1	1	1200
6	UNIT-15	30X40	1200	1	1	1	1200
7	UNIT-16	30X40	1200	1	1	1	1200
8	UNIT-17	30X40	1200	1	1	1	1200
TOTAL NOS. OF UNITS PROPOSED					8	8	9600

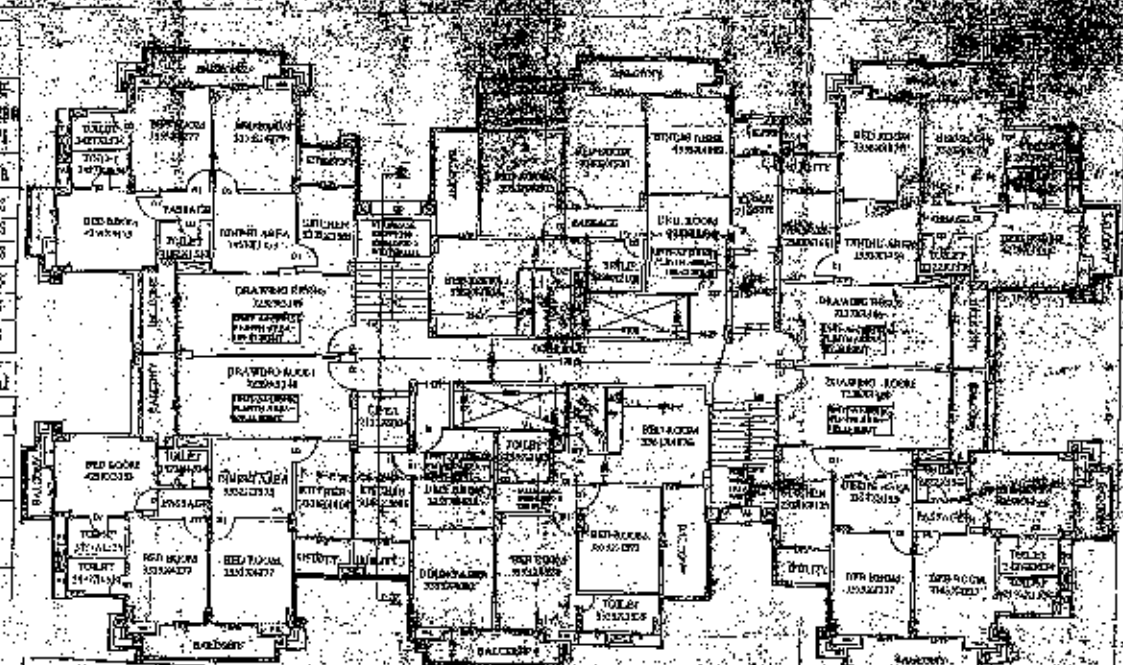


PRO. TYPICAL (8TH TO 9TH.) FLOOR PLAN (BLOCK-A)
SCALE-1:100

UNITS AREA PARTITION STATEMENT (8TH TO 9TH FLOOR)

S.NO	UNIT NO.	PRINC. U.I.A.R.	PLUMB AREA	NO. OF UNIT	TOTAL NOS. OF FLOOR	TOTAL NOS. OF UNIT	PARTITIONED AREA (SQ. FT.)
1	UNIT-08	30X40	1200	1	2	2	2400
2	UNIT-09	30X40	1200	1	2	2	2400
3	UNIT-10	30X40	1200	1	2	2	2400
4	UNIT-11	30X40	1200	1	2	2	2400
5	UNIT-12	30X40	1200	1	2	2	2400
6	UNIT-13	30X40	1200	1	2	2	2400
7	UNIT-14	30X40	1200	1	2	2	2400
8	UNIT-15	30X40	1200	1	2	2	2400
9	UNIT-16	30X40	1200	1	2	2	2400
10	UNIT-17	30X40	1200	1	2	2	2400
TOTAL NOS. OF UNITS PROPOSED					20	20	24000

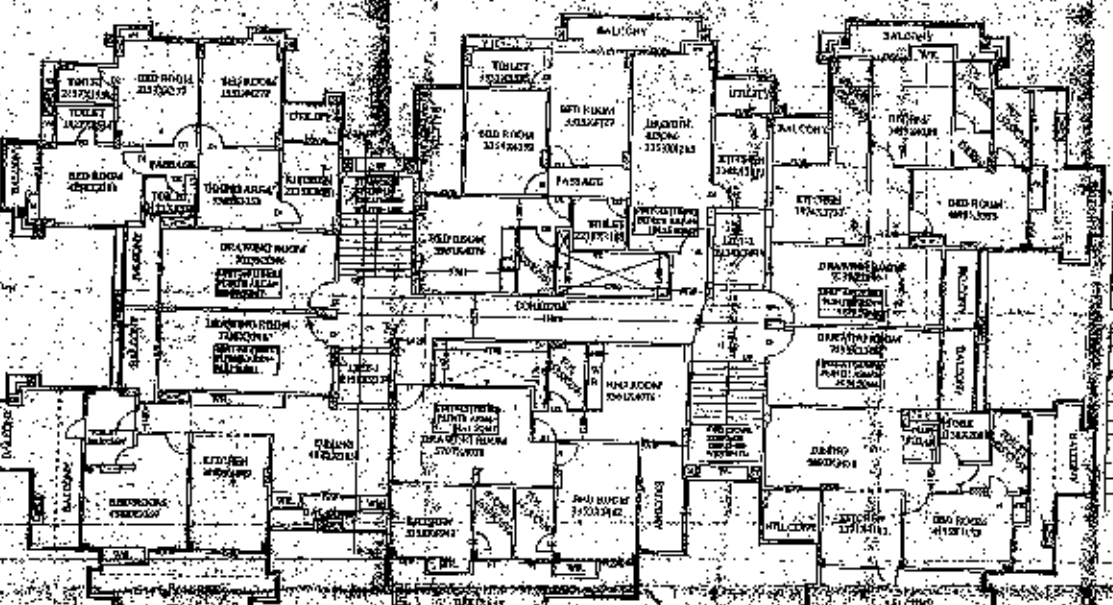

PROPOSED TENTH FLOOR PLAN (BLOCK-A)
SCALE-1:100

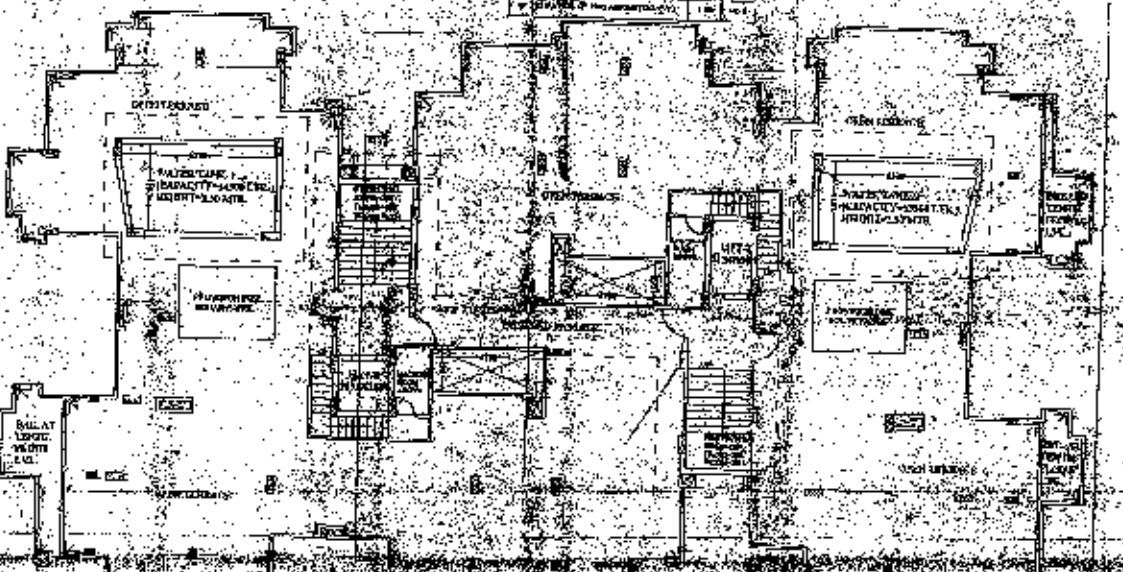

PROPOSED TERRACE FLOOR PLAN (BLOCK-A)
SCALE-1:100

PROJECT - PROPOSED AFFORDABLE GROUP HOUSING AT BUNGALOW NO.15 (OLD) TO 18 (NEW) STANLEY ROAD OVER NAZUL NOW FREEHOLD SITE NO. 135 CIVIL STATION AT THE CORNER OF MOHALLAH STANLEY ROAD AND MAHARSHI DAYANAND MARG, CIVIL LINE'S ALLAHABAD.

FLOOR PLAN (BLOCK-A)

M/S SANGAM STRUCTURAL LTD.
SHRI SHASHANK AGARWAL
S/O LATE RAJEEV AGARWAL

OWNER: THIS IS CERTIFIED THAT BUILDING PLAN IS AS ARCHITECT PER BY LAWS OF 2008 AND MASTER PLAN 2021

1. ALL DIMENSIONS ARE IN METERS UNLESS OTHERWISE SPECIFIED.
2. THE ARCHITECT SHALL BE RESPONSIBLE FOR THE ACCURACY OF THE DIMENSIONS AND THE COMPLIANCE WITH THE APPLICABLE CODES AND REGULATIONS.
3. THE CONTRACTOR SHALL BE RESPONSIBLE FOR THE ACCURACY OF THE CONSTRUCTION AND THE COMPLIANCE WITH THE APPLICABLE CODES AND REGULATIONS.

4. THE ARCHITECT SHALL BE RESPONSIBLE FOR THE DESIGN AND THE COMPLIANCE WITH THE APPLICABLE CODES AND REGULATIONS.
5. THE CONTRACTOR SHALL BE RESPONSIBLE FOR THE CONSTRUCTION AND THE COMPLIANCE WITH THE APPLICABLE CODES AND REGULATIONS.

6. THE ARCHITECT SHALL BE RESPONSIBLE FOR THE DESIGN AND THE COMPLIANCE WITH THE APPLICABLE CODES AND REGULATIONS.
7. THE CONTRACTOR SHALL BE RESPONSIBLE FOR THE CONSTRUCTION AND THE COMPLIANCE WITH THE APPLICABLE CODES AND REGULATIONS.

8. THE ARCHITECT SHALL BE RESPONSIBLE FOR THE DESIGN AND THE COMPLIANCE WITH THE APPLICABLE CODES AND REGULATIONS.
9. THE CONTRACTOR SHALL BE RESPONSIBLE FOR THE CONSTRUCTION AND THE COMPLIANCE WITH THE APPLICABLE CODES AND REGULATIONS.

10. THE ARCHITECT SHALL BE RESPONSIBLE FOR THE DESIGN AND THE COMPLIANCE WITH THE APPLICABLE CODES AND REGULATIONS.
11. THE CONTRACTOR SHALL BE RESPONSIBLE FOR THE CONSTRUCTION AND THE COMPLIANCE WITH THE APPLICABLE CODES AND REGULATIONS.

12. THE ARCHITECT SHALL BE RESPONSIBLE FOR THE DESIGN AND THE COMPLIANCE WITH THE APPLICABLE CODES AND REGULATIONS.
13. THE CONTRACTOR SHALL BE RESPONSIBLE FOR THE CONSTRUCTION AND THE COMPLIANCE WITH THE APPLICABLE CODES AND REGULATIONS.

14. THE ARCHITECT SHALL BE RESPONSIBLE FOR THE DESIGN AND THE COMPLIANCE WITH THE APPLICABLE CODES AND REGULATIONS.
15. THE CONTRACTOR SHALL BE RESPONSIBLE FOR THE CONSTRUCTION AND THE COMPLIANCE WITH THE APPLICABLE CODES AND REGULATIONS.

16. THE ARCHITECT SHALL BE RESPONSIBLE FOR THE DESIGN AND THE COMPLIANCE WITH THE APPLICABLE CODES AND REGULATIONS.
17. THE CONTRACTOR SHALL BE RESPONSIBLE FOR THE CONSTRUCTION AND THE COMPLIANCE WITH THE APPLICABLE CODES AND REGULATIONS.

18. THE ARCHITECT SHALL BE RESPONSIBLE FOR THE DESIGN AND THE COMPLIANCE WITH THE APPLICABLE CODES AND REGULATIONS.
19. THE CONTRACTOR SHALL BE RESPONSIBLE FOR THE CONSTRUCTION AND THE COMPLIANCE WITH THE APPLICABLE CODES AND REGULATIONS.

20. THE ARCHITECT SHALL BE RESPONSIBLE FOR THE DESIGN AND THE COMPLIANCE WITH THE APPLICABLE CODES AND REGULATIONS.
21. THE CONTRACTOR SHALL BE RESPONSIBLE FOR THE CONSTRUCTION AND THE COMPLIANCE WITH THE APPLICABLE CODES AND REGULATIONS.



22. THE ARCHITECT SHALL BE RESPONSIBLE FOR THE DESIGN AND THE COMPLIANCE WITH THE APPLICABLE CODES AND REGULATIONS.
23. THE CONTRACTOR SHALL BE RESPONSIBLE FOR THE CONSTRUCTION AND THE COMPLIANCE WITH THE APPLICABLE CODES AND REGULATIONS.

24. THE ARCHITECT SHALL BE RESPONSIBLE FOR THE DESIGN AND THE COMPLIANCE WITH THE APPLICABLE CODES AND REGULATIONS.
25. THE CONTRACTOR SHALL BE RESPONSIBLE FOR THE CONSTRUCTION AND THE COMPLIANCE WITH THE APPLICABLE CODES AND REGULATIONS.


26. THE ARCHITECT SHALL BE RESPONSIBLE FOR THE DESIGN AND THE COMPLIANCE WITH THE APPLICABLE CODES AND REGULATIONS.
27. THE CONTRACTOR SHALL BE RESPONSIBLE FOR THE CONSTRUCTION AND THE COMPLIANCE WITH THE APPLICABLE CODES AND REGULATIONS.

28. THE ARCHITECT SHALL BE RESPONSIBLE FOR THE DESIGN AND THE COMPLIANCE WITH THE APPLICABLE CODES AND REGULATIONS.
29. THE CONTRACTOR SHALL BE RESPONSIBLE FOR THE CONSTRUCTION AND THE COMPLIANCE WITH THE APPLICABLE CODES AND REGULATIONS.

30. THE ARCHITECT SHALL BE RESPONSIBLE FOR THE DESIGN AND THE COMPLIANCE WITH THE APPLICABLE CODES AND REGULATIONS.
31. THE CONTRACTOR SHALL BE RESPONSIBLE FOR THE CONSTRUCTION AND THE COMPLIANCE WITH THE APPLICABLE CODES AND REGULATIONS.

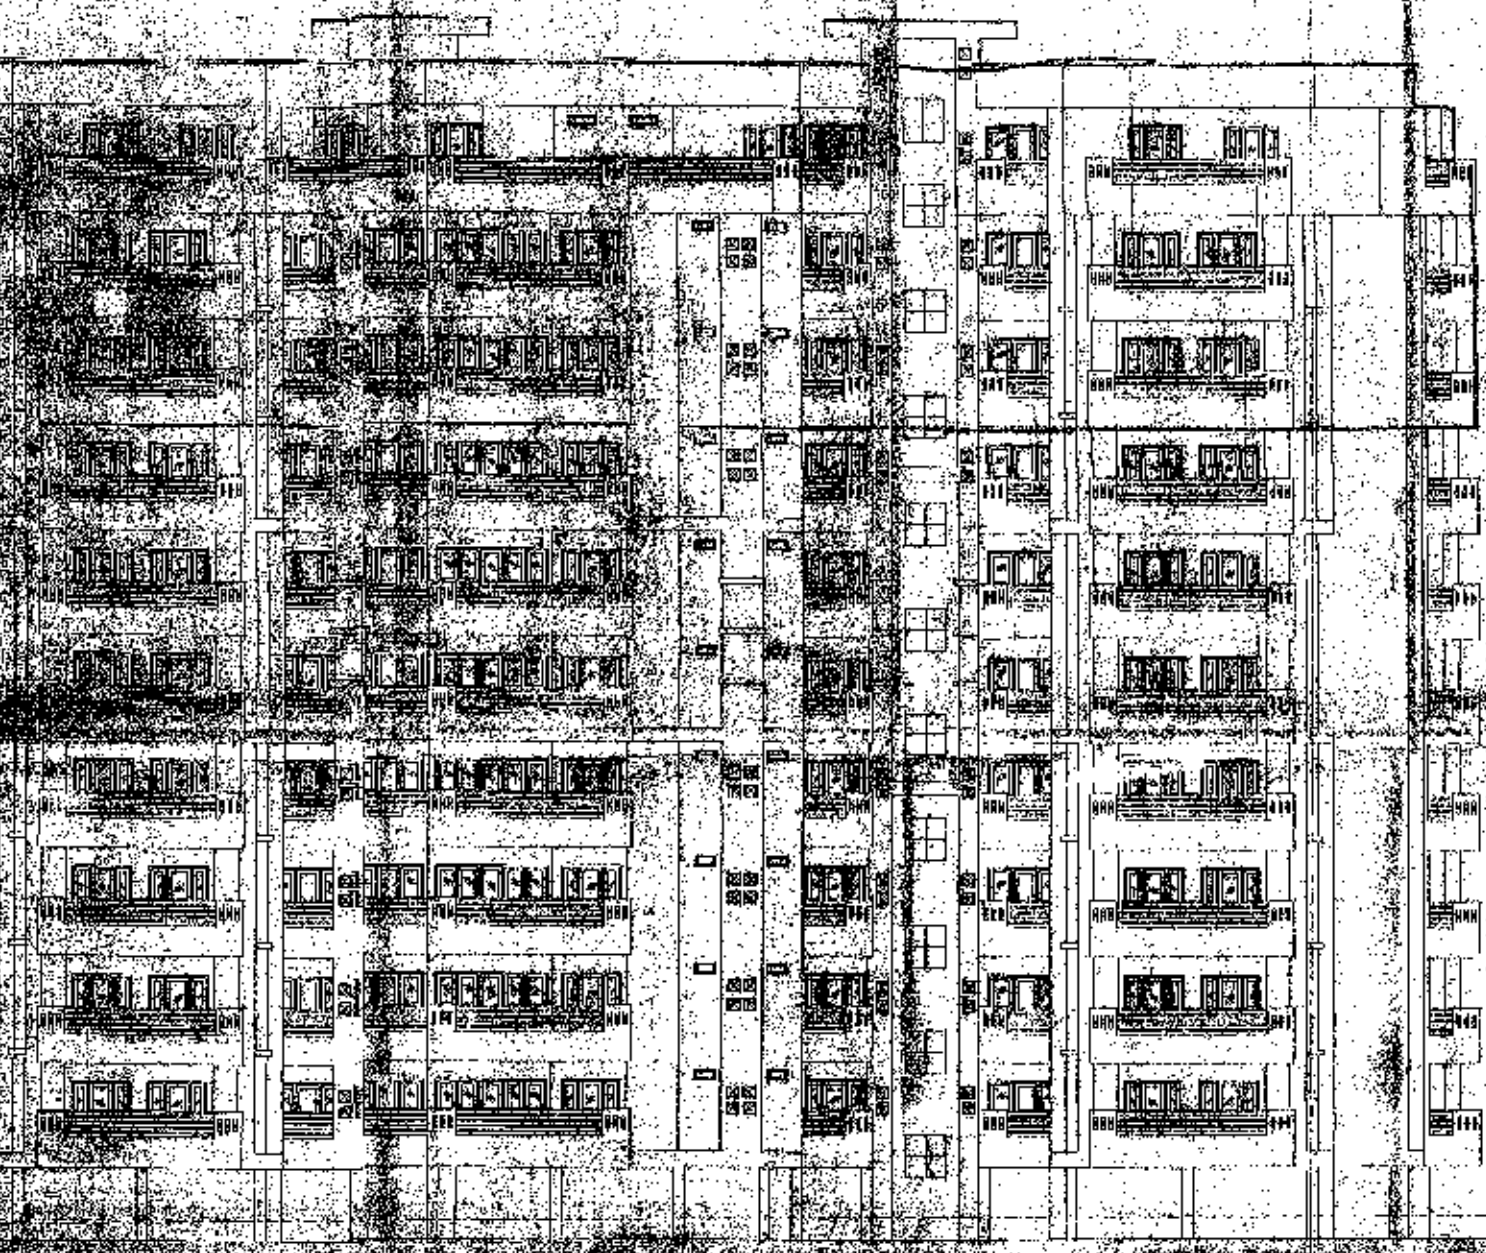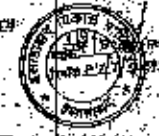

EAST SIDE ELEVATION (BLOCK-A)

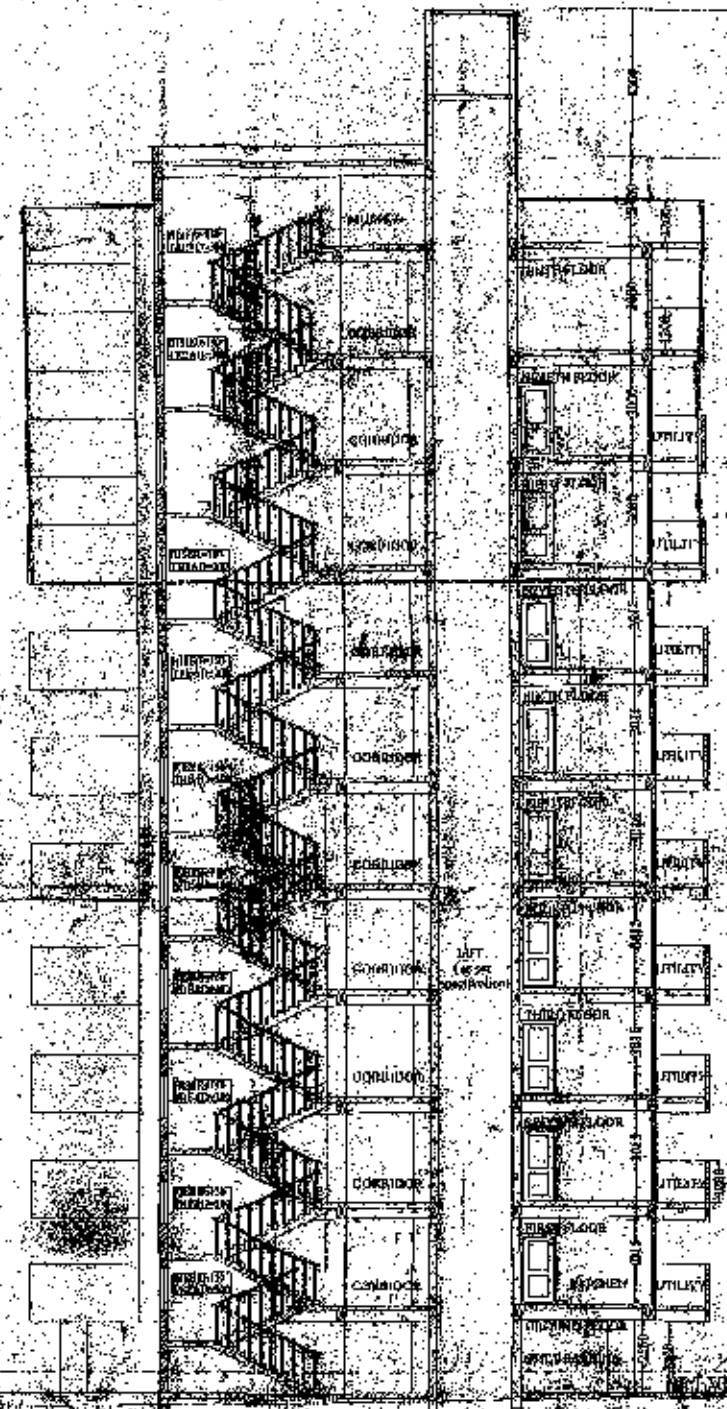

SECTION XX


PROPOSED AFFORDABLE GROUP HOUSING AT BUNGALOW
NO. (OLD) (NEW) STANLEY ROAD OVER NAZUL NOW
REGHOLD SITE NO. 125 CIVIL STATION AT THE CORNER
OF MOHALLAH STANLEY ROAD AND MAHARSHI DAYANAND
MARG, CIVIL LINE'S ALLAHABAD.

ELEVATION/
SECTION
(BLOCK-A)


FOR STRUCTURAL A/C
M/S SANGAM STRUCTURALS LTD.
SHRI SHASHANK AGARWAL
S/O LATE RAJEEV AGARWAL
OWNER

ARCHITECT
ARGHUN SINGH
ARCHITECT
B. Arch. M.E., C.O.A.
REG. NO. CAP/16740

THIS IS CERTIFIED THAT BUILDING PLAN IS AS ARCHITECT
PER BY LAWS OF 2006 AND MASTER PLAN 2021

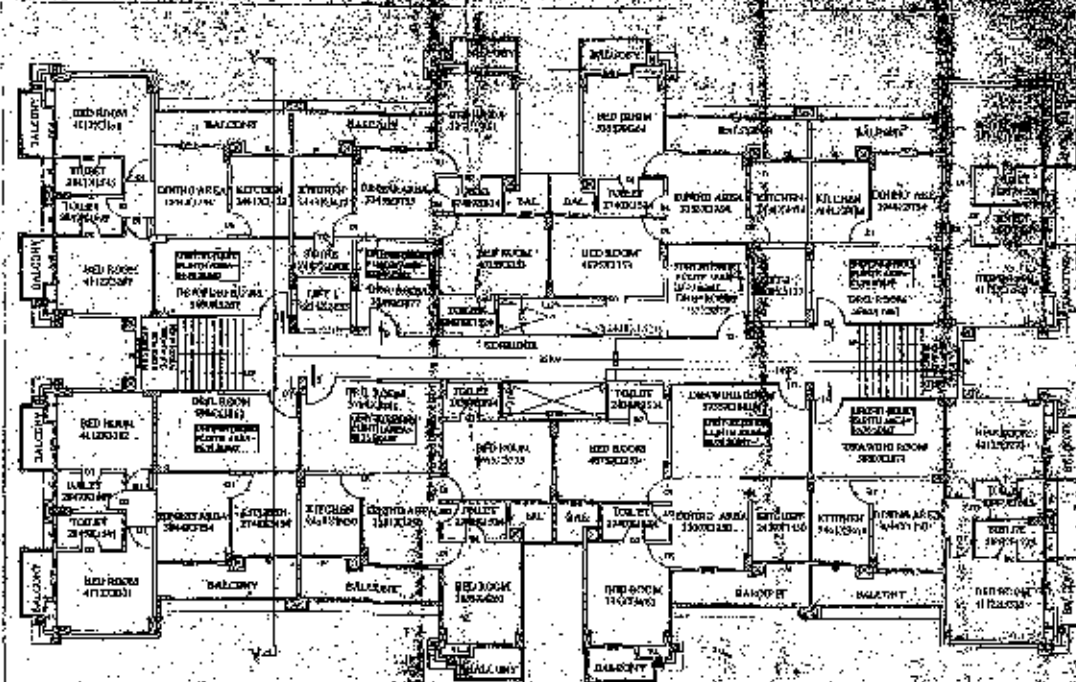

TYPICAL (1ST. TO 7TH.) FLOOR PLAN
(BLOCK-B) SANCTIONED
SCALE-1:100

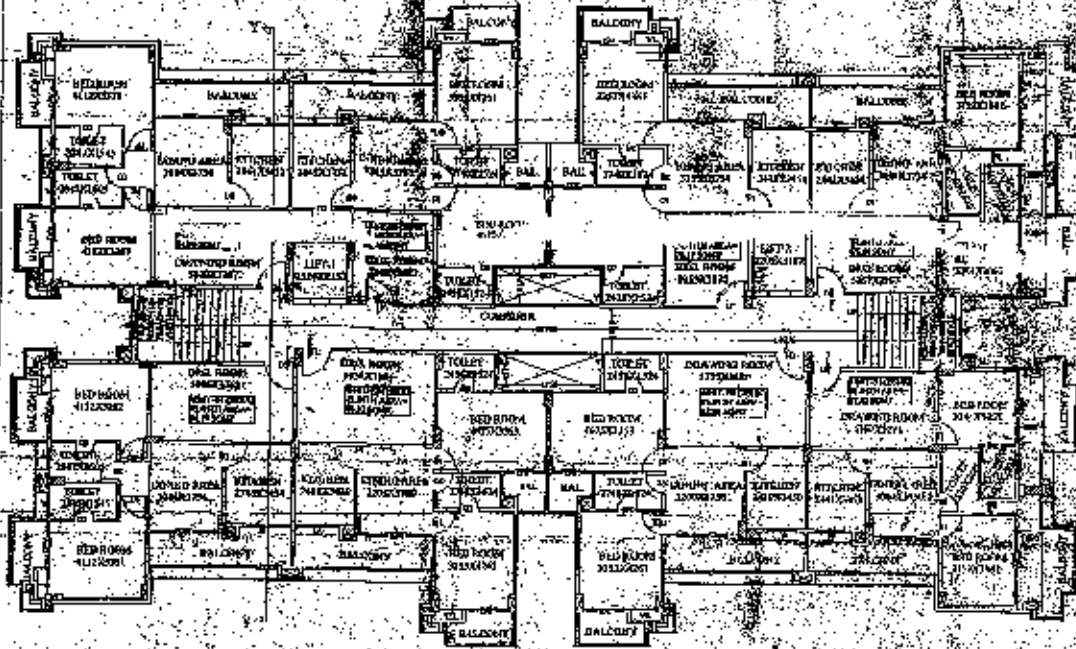

PRO. NINTH FLOOR PLAN (BLOCK-B)
SCALE-1:100

NOTE: AREA UNDER 9TH FLOOR HAS BEEN TAKEN AGAINST AREA AGAINST LIGGS UNITS.

UNIT AREA STATEMENT (1ST TO 7TH) FLOOR (BLOCK-B)

UNIT NO.	FLOOR	AREA (SQM)	NO. OF ROOMS	NO. OF BATHS	NO. OF BALCONIES	NO. OF TERRACES	NO. OF STAIRS	NO. OF LIFTS
UNIT-01	100K	84.00	2	1	1	1	1	1
UNIT-02	200K	84.00	2	1	1	1	1	1
UNIT-03	300K	84.00	2	1	1	1	1	1
UNIT-04	400K	84.00	2	1	1	1	1	1
UNIT-05	500K	84.00	2	1	1	1	1	1
UNIT-06	600K	84.00	2	1	1	1	1	1
UNIT-07	700K	84.00	2	1	1	1	1	1
UNIT-08	800K	84.00	2	1	1	1	1	1
UNIT-09	900K	84.00	2	1	1	1	1	1
UNIT-10	1000K	84.00	2	1	1	1	1	1
TOTAL NOS. OF UNITS PROPOSED			14	7	7	7	7	7

AREA/UNITS STATEMENT (15 TO 7TH) FLOOR (BLOCK-B)

S.NO.	PARTICULARS	AREA (SQM)	NO. OF UNITS
1	PRO. BUILTUP AREA AT FIFTH FLOOR (BLOCK-B)	480.00	7
2	PRO. TOTAL NOS. OF FLOORS WITHIN FAR	7.00	NOS.
3	PRO. GRAND TOTAL BUILTUP AREA (BLOCK-B) (22) WITHIN FAR	5602.24	5204.50
4	NOS. OF UNIT AT EACH FLOOR	8.00	NOS.
5	TOTAL NOS. OF PROPOSED FLOORS	7.00	NOS.
6	GRAND TOTAL NOS. OF UNITS	56.00	NOS.

SCHEDULE OF OPENINGS (REF. ILL. AS PER PLAN)


DOOR	SIZE	COLL.	UNIT	REMARKS
DW1	2100 x 1000	REF.	1	2100
DW2	2100 x 1000	REF.	2	2100
DW3	2100 x 1000	REF.	3	2100
DW4	2100 x 1000	REF.	4	2100
DW5	2100 x 1000	REF.	5	2100
DW6	2100 x 1000	REF.	6	2100
DW7	2100 x 1000	REF.	7	2100
DW8	2100 x 1000	REF.	8	2100
DW9	2100 x 1000	REF.	9	2100
DW10	2100 x 1000	REF.	10	2100
WINDOW W1	1700 x 1300	REF.	1	42100
WINDOW W2	914 x 1350	REF.	2	42100
VENTILATOR V1	300 x 300	REF.	1	42100

AREA/UNITS STATEMENT (9TH FLOOR) (BLOCK-B)


S.NO.	PARTICULARS	AREA (SQM)	NO. OF UNITS
1	PROPOSED BUILTUP AREA AT NINTH FLOOR (BLOCK-B)	720.00	7
2	PROPOSED TOTAL NOS. OF FLOORS WITHIN FAR	1.00	NOS.
3	PROPOSED GRAND TOTAL BUILTUP AREA (BLOCK-B) (22)	6322.24	5271.50
4	NOS. OF UNIT AT EACH FLOOR	8.00	NOS.

UNIT AREA STATEMENT (9TH FLOOR) (BLOCK-B)

S.NO.	UNIT NO.	FLOOR	AREA (SQM)	NO. OF ROOMS	NO. OF BATHS	NO. OF BALCONIES	NO. OF TERRACES	NO. OF STAIRS	NO. OF LIFTS
1	UNIT-11	900K	84.00	2	1	1	1	1	1
2	UNIT-12	1000K	84.00	2	1	1	1	1	1
3	UNIT-13	1100K	84.00	2	1	1	1	1	1
4	UNIT-14	1200K	84.00	2	1	1	1	1	1
5	UNIT-15	1300K	84.00	2	1	1	1	1	1
6	UNIT-16	1400K	84.00	2	1	1	1	1	1
7	UNIT-17	1500K	84.00	2	1	1	1	1	1
TOTAL NOS. OF UNITS PROPOSED				7	3	3	3	3	3

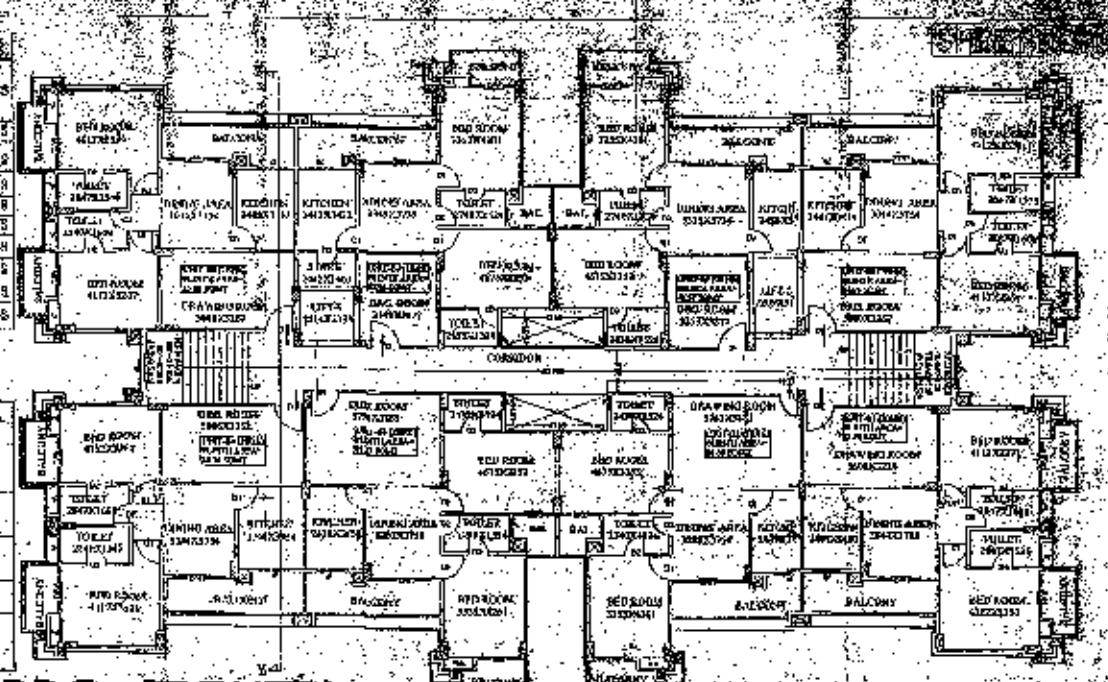

PRO. EIGHTH FLOOR PLAN (BLOCK-B)
SCALE-1:100

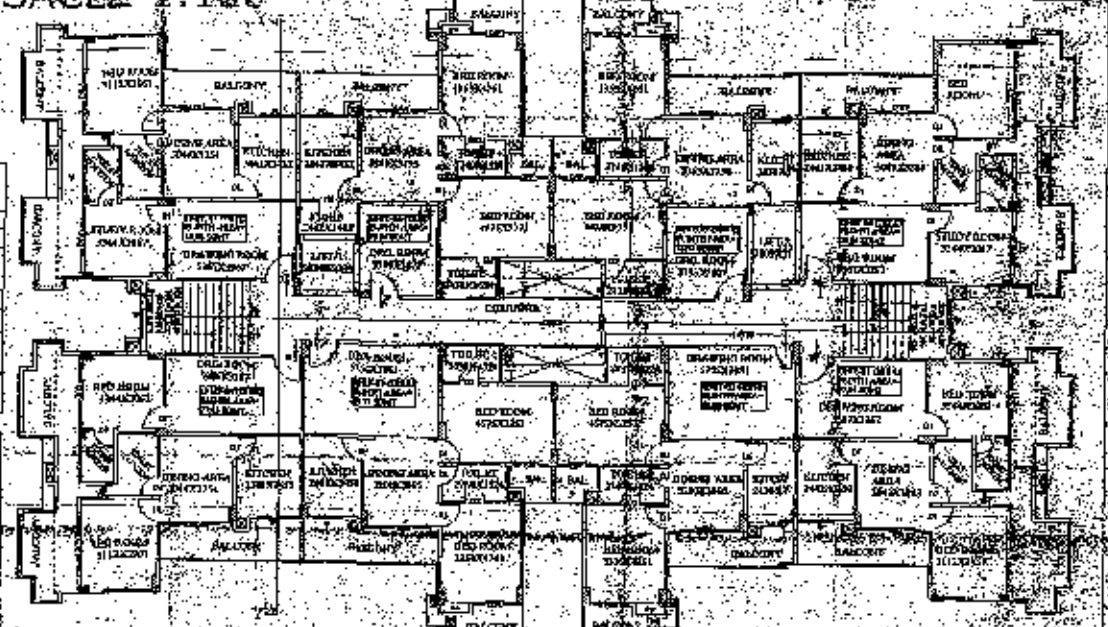

PRO. TYPICAL (10TH. TO 11TH) FLOOR PLAN (BLOCK-B)
SCALE-1:100

NOTE: ALL DIMENSIONS ARE IN MM.


PROJECT:-
PROPOSED AFFORDABLE GROUP HOUSING AT BUNGALOW NO. 15 (OLD) 19 (NEW) STANLEY ROAD OVER NAZUL NOW FREEHOLD SITE NO. 125 CIVIL STATION AT THE CORNER OF MOHALLAH STANLEY ROAD AND MAHARSHI DAYANAND MARG, CIVIL LINE 5 ALLAHABAD.

FLOOR PLAN/
(BLOCK-B)

M/S SANGAM STRUCTURALS LTD.
SHRI SHASHANK AGARWAL
S/O LATE RAJDEV AGARWAL

OWNER THIS IS CERTIFIED THAT BUILDING PLAN IS AS ARCHITECT PER BY LAWS OF 2008 AND MASTER PLAN 2021.



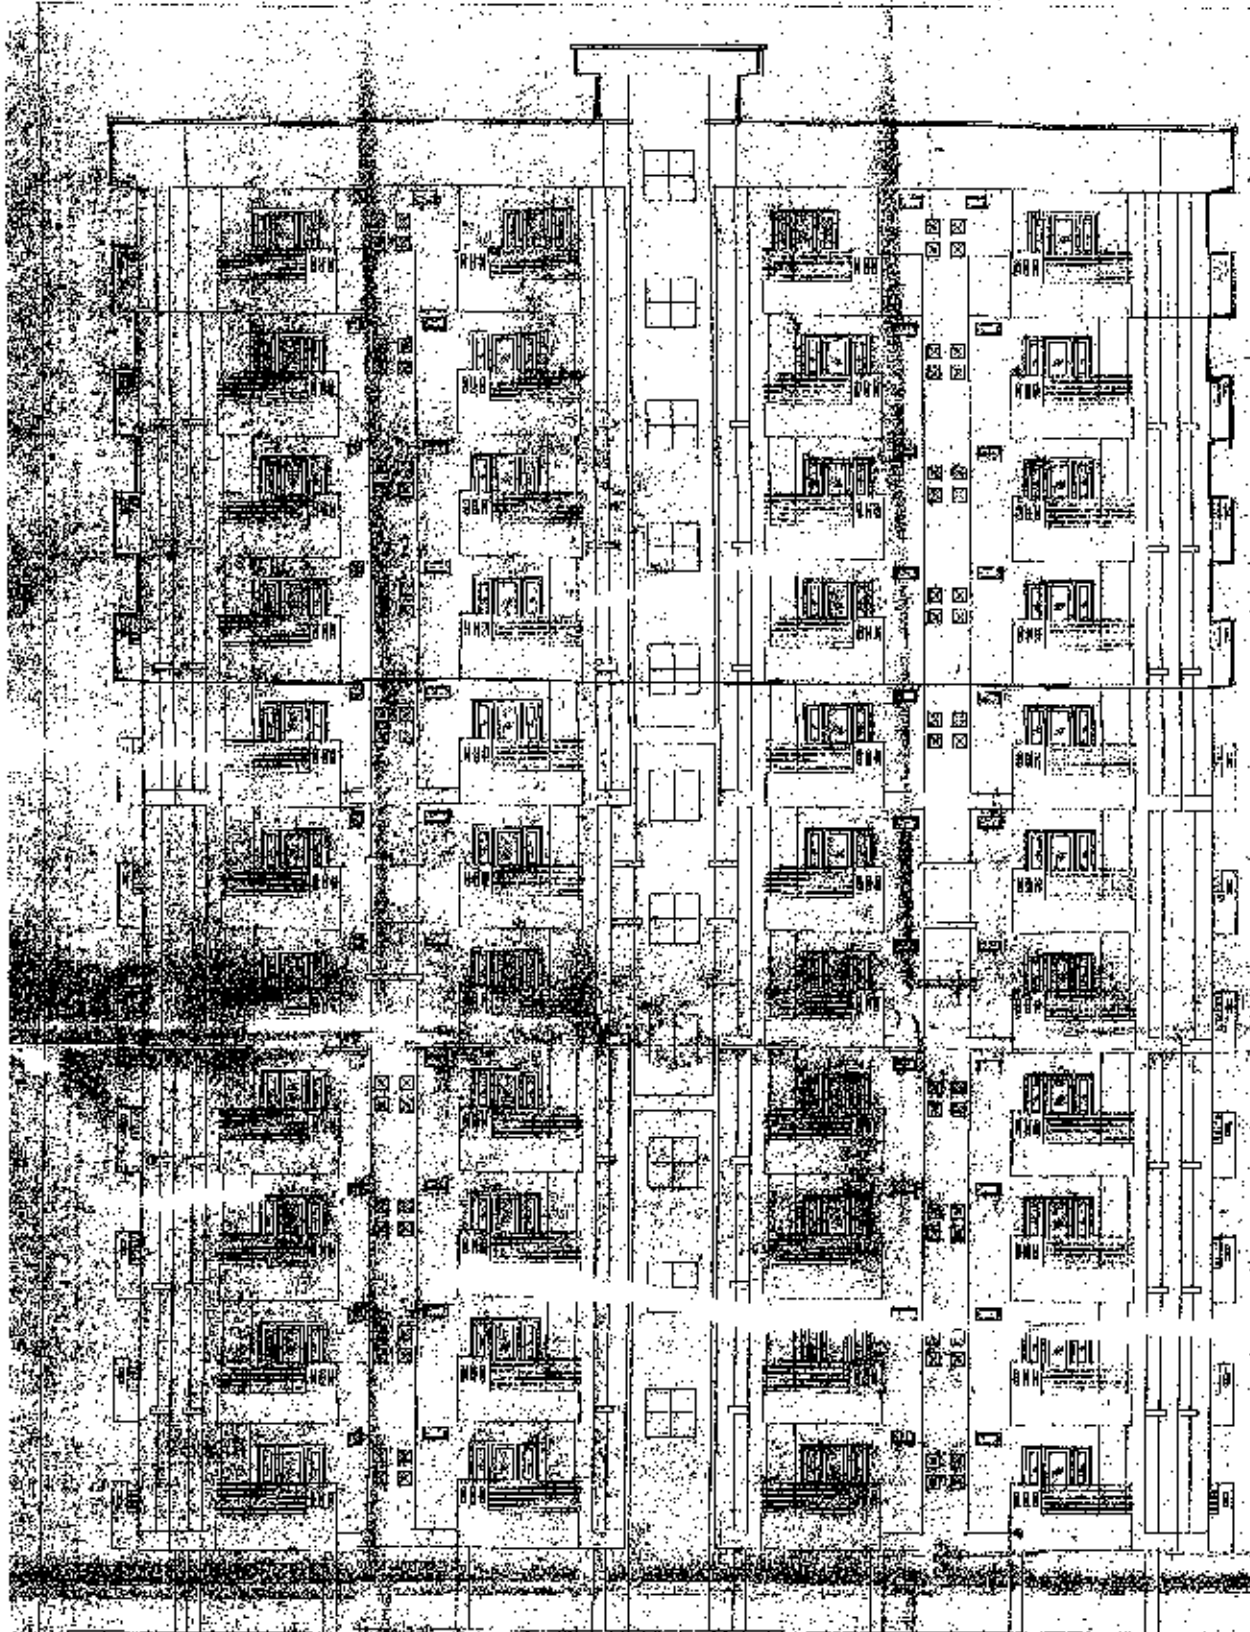

NORTH & SOUTH SIDE ELEVATION (BLOCK-B)

+3835MM MUMTY FLOOR SLAB TOP LVL.

+3995MM TERRACE FLOOR LVL.

+32995MM ELIVENTH FLOOR LVL.

+29995MM TENTH FLOOR LVL.

+27995MM NINTH FLOOR LVL.

+23995MM EIGHTH FLOOR LVL.

+20990MM SEVENTH FLOOR LVL.

+17995MM SIXTH FLOOR LVL.

+14995MM FIFTH FLOOR LVL.


+11995MM FOURTH FLOOR LVL.

+8995MM THIRD FLOOR LVL.

+5995MM SECOND FLOOR LVL.

+2995MM FIRST FLOOR LVL.

GROUND (FILT FLOOR) LVL. +0

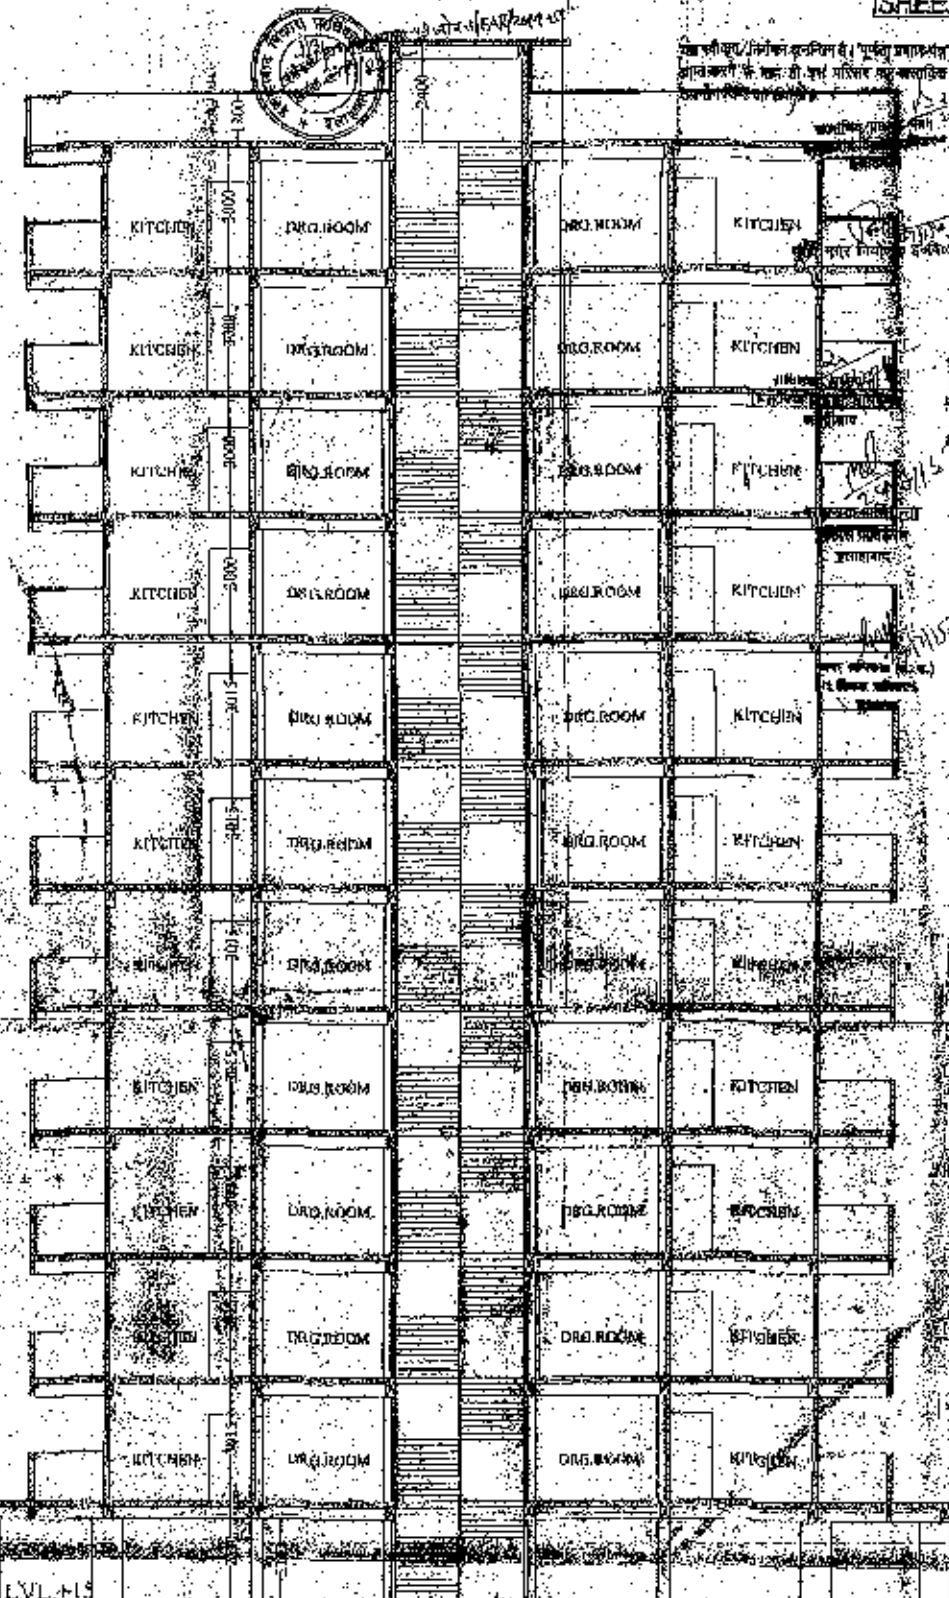

SECTION-YY

PROPOSED
Ramp at 100

RESIDENTIAL GROUP HOUSING AT BUNGALOW
100/101/102/103 STANLEY ROAD OVER NAZUL NOW
125 CIVIL STATION AT THE CORNER
STANLEY ROAD AND MAHARSHI DAYANAND
MARK CIVIL TOWN ALLAHABAD.


ELEVATION/
SECTION
(BLOCK-B)

For ORIGINAL STRUCTURALS LTD.
M/S SANGAM STRUCTURALS LTD.
SRI SHASHANK AGARWAL
S/O LATE RAJEEV AGARWAL
OWNER

AKHILSINGH SINGH
ARCHITECT.
B.Arch., M.S., C.O.A.
Reg. No. CA/24/19740

THIS IS A PRELIMINARY BUILDING PLAN AS ARCHITECT
PER BY LAWS OF 2008 AND MASTER PLAN 2021

SHEET NO. 5

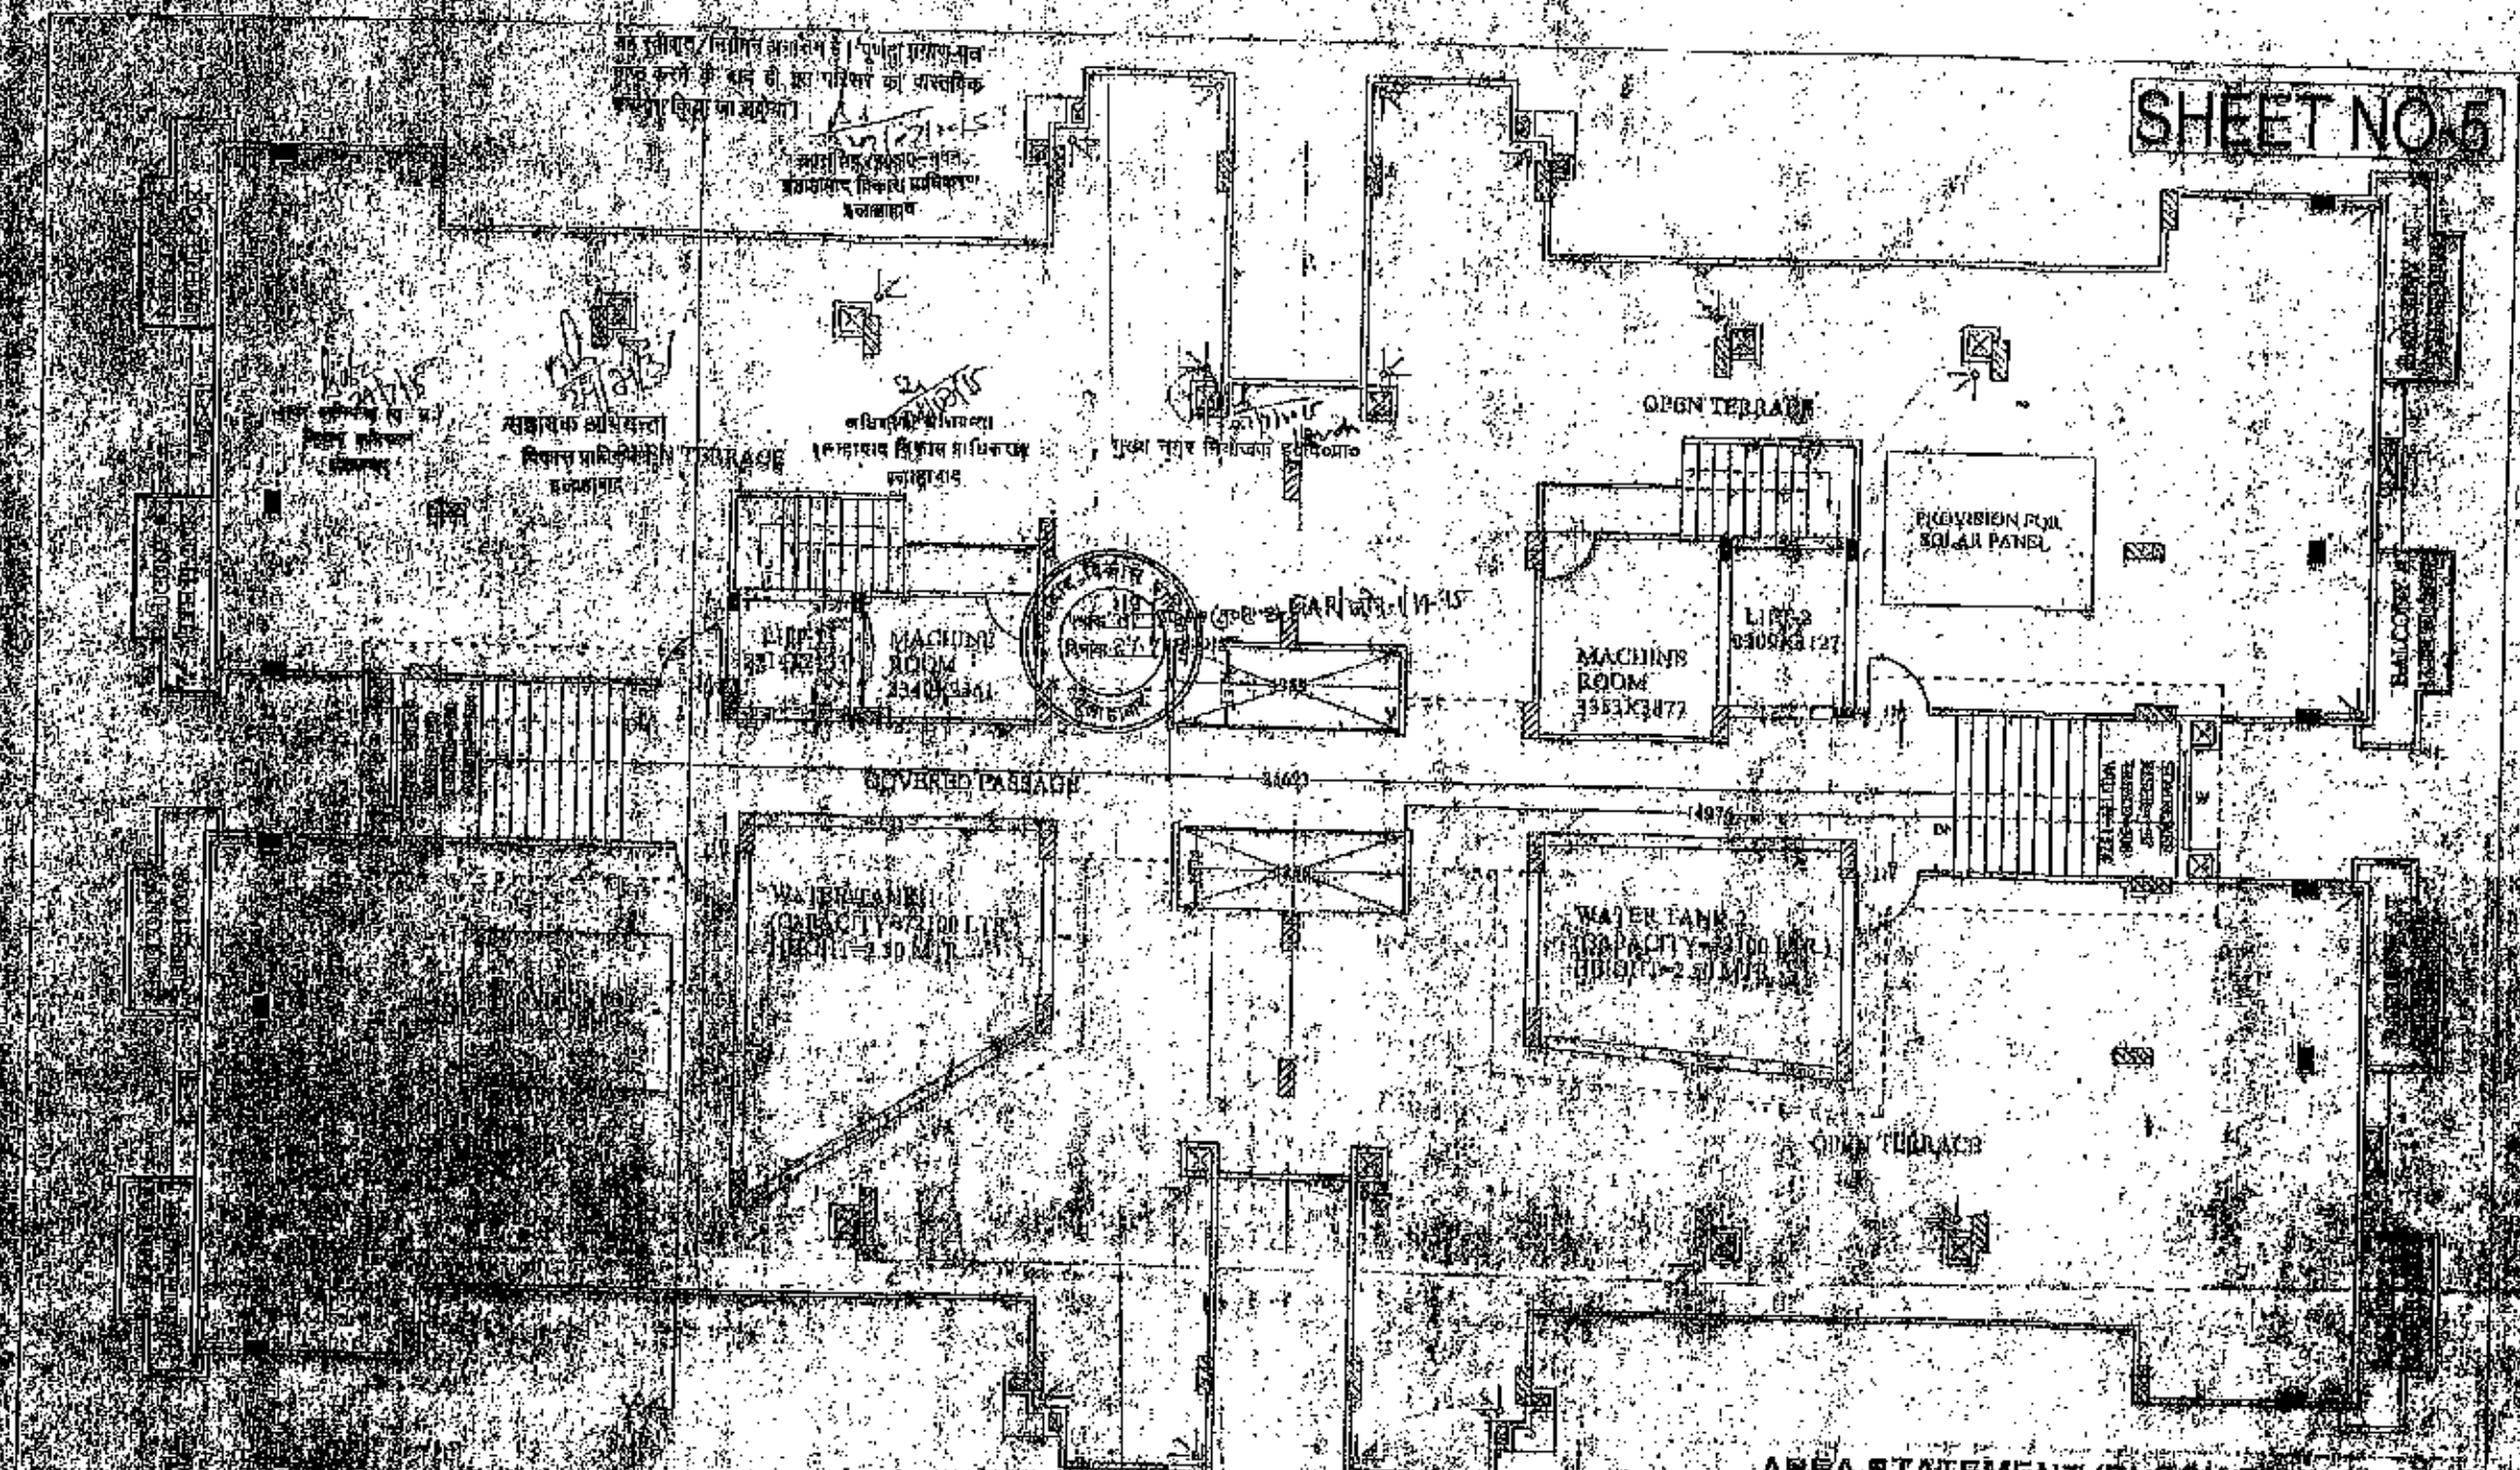

**PROPOSED TERRACE FLOOR PLAN
(BLOCK-B)
SCALE-1:100**

AREA STATEMENT (BLOCK-B)

S. NO.	PARTICULAR	AREA (SQ. M)	VOLUME (CU. M)
1	PRO. BUILT UP AREA AT MUMTY/FIRE ESCAPE (BLOCK-B)	11.11	11.11

NOTE:
ALL DIMENSIONS ARE IN MM.

PROJECT: PROPOSED APARTMENT BUILDING AT GURGAON
NO. 10/10, PLOT NO. 10/10, PHASE I, GURGAON, HARYANA



FLOOR PLAN/
SECTION
(BLOCK-B)

SHEET NO. 5
SCALE 1:100

M/S. SANDAN STRATEGICALS LTD.
SUBI SHASHANK AGARWAL
B-20, LATA RAJYVARDHAN
GURGAON STRATEGICALS LTD.

Architect's Signature:
AHILESHWAR SINGH
ARCHITECT