


NOTES:-

1. ALL DIMENSIONS & LEVELS ARE TO FACE UNLESS SPECIFIED OTHERWISE.
2. ALL THE AREAS INDICATED ARE IN SQUARE METERS (SQ.M).
3. COLUMNS ARE ONLY INDICATED AND WILL BE AS PER RECEIVING STRUCTURAL DRAWINGS.
4. ENTIRE BUILDING WILL BE MECHANICALLY AIR CONDITIONED AND ALL STORES & TOILETS, KITCHEN & PANTRY WILL BE MECHANICALLY MECHANICAL.
5. ALL EXIT DOORS SHALL HAVE 1 HOUR FIRE RESISTANT RATING.
6. ALL LIFT, ESCALATOR & MACHINE ROOM SHOULD BE AS PER SI STANDARD.
7. THE BUILDING SHALL BE FULLY SPRINKLED EQUIPPED WITH AUTOMATIC SPRINKLER SYSTEM.

KEY PLAN

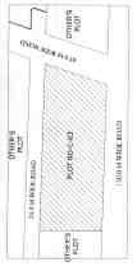

SCALE :- N.T.S

NOTE:- QUANTITY OF OPTIMIS FOR SINGLE FLOOR ONLY.

SERIAL NO.	QTY	UNIT	AREA
1.	1	01	1000
2.	1	01	700
3.	1	01	100
4.	1	01	100
5.	1	01	100
6.	1	01	100
7.	1	01	100
8.	1	01	100
9.	1	01	100
10.	1	01	100
11.	1	01	100
12.	1	01	100
13.	1	01	100
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41.	1	01	100
42.	1	01	100
43.	1	01	100
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89.	1	01	100
90.	1	01	100
91.	1	01	100
92.	1	01	100
93.	1	01	100
94.	1	01	100
95.	1	01	100
96.	1	01	100
97.	1	01	100
98.	1	01	100
99.	1	01	100
100.	1	01	100

BASEMENT-2 DEDUCTION AREA CHART

S.NO.	DESCRIPTION	AREA (SQ.M)
1.	LIFT SHAFT	1.400
2.	STAIR	2.800
3.	STAIR	2.800
4.	STAIR	2.800
5.	STAIR	2.800
6.	STAIR	2.800
7.	STAIR	2.800
8.	STAIR	2.800
9.	STAIR	2.800
10.	STAIR	2.800
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280.	STAIR	2.800
281.	STAIR	2.800
282.	STAIR	2.800
283.	STAIR	2.800
284.	STAIR	2

NOTES:-

1. ALL DIMENSIONS & LEVELS ARE IN MILLIMETERS.
2. ALL THE AREAS INDICATED ARE APPROXIMATE AS PER RELEVANT STRUCTURAL DRAWINGS.
3. COLUMNS ARE ONLY INDICATED AND SPACES AS PER RELEVANT STRUCTURAL DRAWINGS.
4. ENTIRE BUILDING WILL BE MECHANICALLY VENTILATED AND ALL STORES & TOILETS, KITCHENS & HALLWAYS WILL BE MECHANICALLY VENTILATED.
5. ALL EXIT DOORS SHALL HAVE 1 HOUR FIRE RESISTANT RATING.
6. ALL LIFT, ESCALATOR & MACHINE ROOM SHOULD BE AS PER IS STANDARD.
7. THE BUILDING SHALL BE FULLY SPRINKLED EQUIPPED WITH AUTOMATIC SPRINKLER SYSTEM.

KEY PLAN



SCALE : - N.T.S

NOTE - QUANTITY OF DIMENSIONS FOR SINGLE FLOOR ONLY

NO.	TYPE	WIDE	DEPT.	NO.	AREA
1	STP	1000	1000	1	1000
2	STP	1000	1000	1	1000
3	STP	1000	1000	1	1000
4	STP	1000	1000	1	1000
5	STP	1000	1000	1	1000
6	STP	1000	1000	1	1000
7	STP	1000	1000	1	1000
8	STP	1000	1000	1	1000
9	STP	1000	1000	1	1000
10	STP	1000	1000	1	1000
11	STP	1000	1000	1	1000
12	STP	1000	1000	1	1000
13	STP	1000	1000	1	1000
14	STP	1000	1000	1	1000
15	STP	1000	1000	1	1000
16	STP	1000	1000	1	1000
17	STP	1000	1000	1	1000
18	STP	1000	1000	1	1000
19	STP	1000	1000	1	1000
20	STP	1000	1000	1	1000
21	STP	1000	1000	1	1000
22	STP	1000	1000	1	1000
23	STP	1000	1000	1	1000
24	STP	1000	1000	1	1000
25	STP	1000	1000	1	1000
26	STP	1000	1000	1	1000
27	STP	1000	1000	1	1000
28	STP	1000	1000	1	1000
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45	STP	1000	1000	1	1000
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62	STP	1000	1000	1	1000
63	STP	1000	1000	1	1000
64	STP	1000	1000	1	1000
65	STP	1000	1000	1	1000
66	STP	1000	1000	1	1000
67	STP	1000	1000	1	1000
68	STP	1000	1000	1	1000
69	STP	1000	1000	1	1000
70	STP	1000	1000	1	1000
71	STP	1000	1000	1	1000
72	STP	1000	1000	1	1000
73	STP	1000	1000	1	1000
74	STP	1000	1000	1	1000
75	STP	1000	1000	1	1000
76	STP	1000	1000	1	1000
77	STP	1000	1000	1	1000
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80	STP	1000	1000	1	1000
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94	STP	1000	1000	1	1000
95	STP	1000	1000	1	1000
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97	STP	1000	1000	1	1000
98	STP	1000	1000	1	1000
99	STP	1000	1000	1	1000
100	STP	1000	1000	1	1000

PROJECT
 PROPOSED SUBMISSION DRAWING FOR
 GALAXY BLUE SAPPHIRE PLAZA AT
 PLOT NO. C-03, SECTOR - 04, GREATER NOIDA (U.P.)

OWNER
 M/S GLD INFRAPROJECTS PVT. LTD.
 UNIT NO.-105, 1ST FLOOR VARDHMAN SIDHANT
 SHOPPING PLAZA, LHC, SAVITA VIHAR, DELHI-92

ARCHITECT'S SEAL
 ARCHITECT

OWNER'S SEAL
 For GLD InfraProjects Private Limited
 Authorised Signatory

ARCHITECT
 modarchindia
 Architects, Engineers & Planners
 10/105, 1st Floor Vardhman Sidhant Shopping Plaza,
 LHC, Savita Vihar, Delhi-92
 Phone: 011-26122023, Email: info@modarchindia.com
 Website: www.modarchindia.in


Drawing Title
 BASEMENT-3 FLOOR PLAN
 & AREA CALCULATION
 (L.V.L.-12000)

North

Created by MANJEE TIWARI
Date
Drawn by LOJAN KUMAR
Scale 1:300
Drawing No. MA - GA - SANCTION



BASEMENT -3 FLOOR PLAN

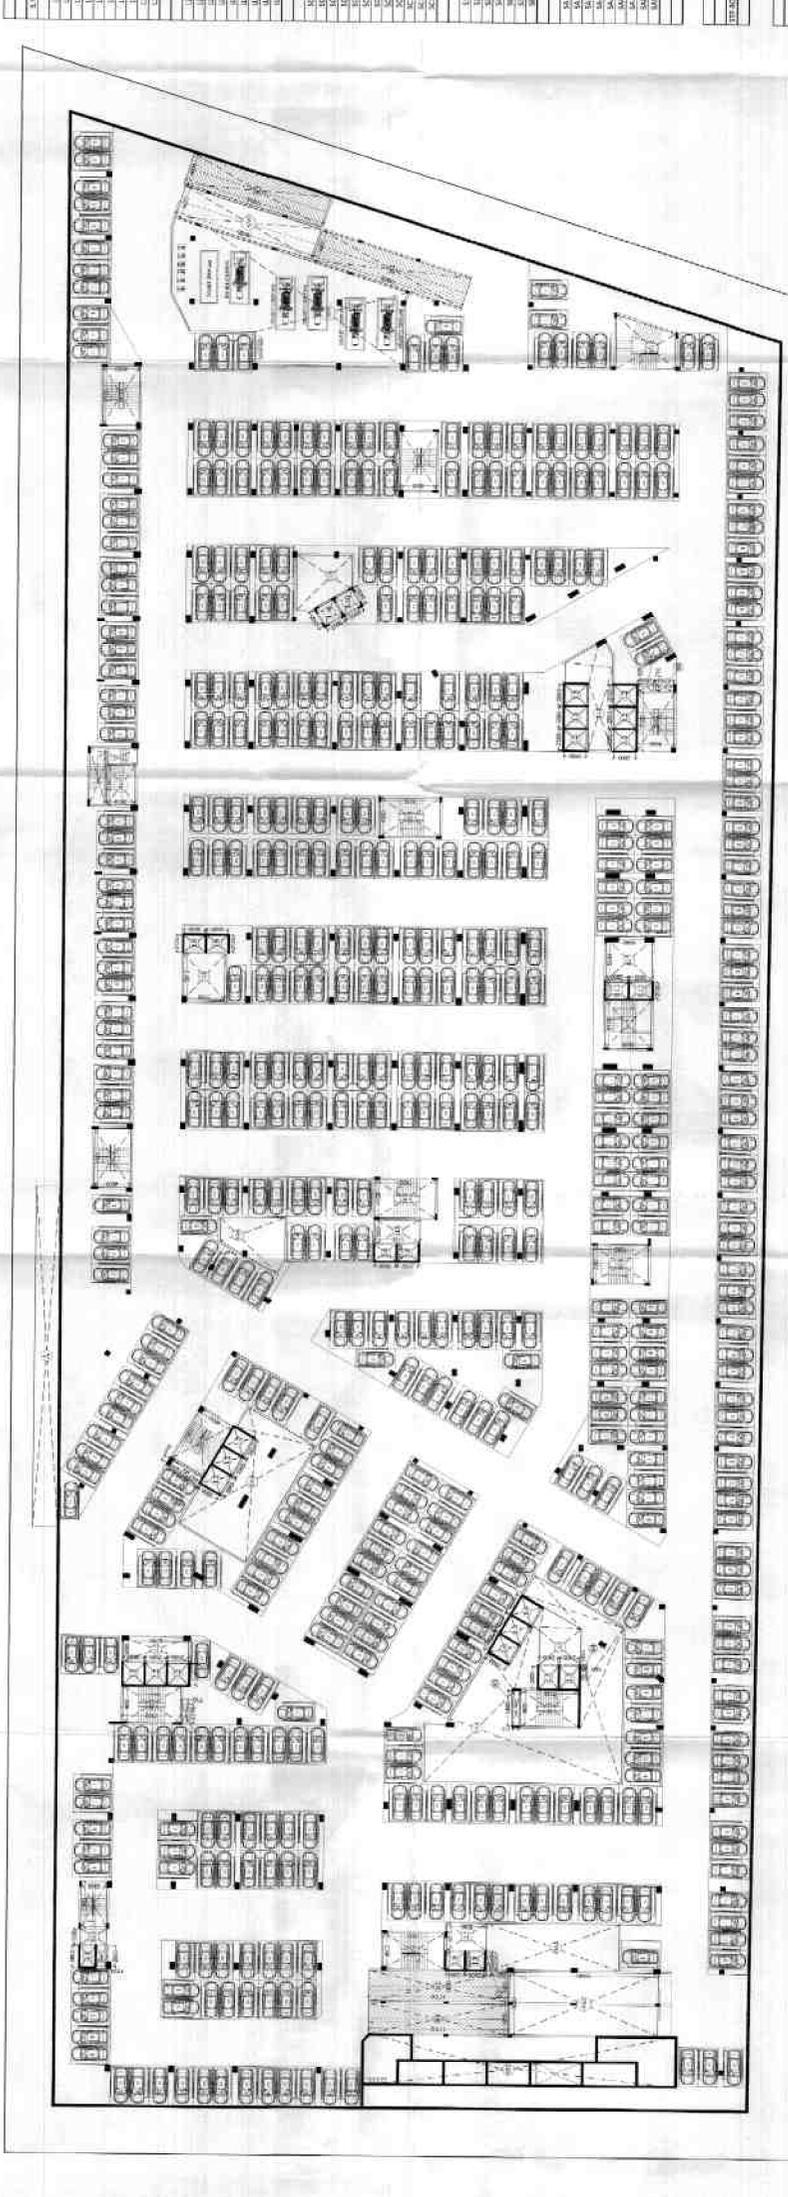

BASEMENT -3 DEDUCTION AREA ENVELOPES

BASEMENT-3 NON F.A.R. & PARKING AREA CALCULATION :-

BASEMENT-3 TOTAL ENVELOPE AREA =	BASEMENT 1 ENVELOPE AREA - A
	= 21681.426 - 133.461 = 21527.965 Sqm
TOTAL DEDUCTION AREA =	2282.390 Sqm
PARKING AREA =	TOTAL ENVELOPE AREA - TOTAL DEDUCTION + STP AREA + RAMP AREA
	= 21627.965 - 2282.390 + 284.538 + 288.070 = 21627.965 - 2755.866 = 18772.076 Sqm
NON F.A.R. AREA =	TOTAL ENVELOPE AREA - (STP AREA + LIFT SHAFT + SHAFT)
	= 21527.965 - (264.528 + 162.883 + 13.282) = 21527.965 - 460.771 = 21087.194 Sqm

MEASUREMENT 1

NO.	TYPE	WIDE	DEPT.	NO.	AREA
1	STP	1000	1000	1	1000
2	STP	1000	1000	1	1000
3	STP	1000	1000	1	1000
4	STP	1000	1000	1	1000
5	STP	1000	1000	1	1000
6	STP	1000	1000	1	1000
7	STP	1000	1000	1	1000
8	STP	1000	1000	1	1000
9	STP	1000	1000	1	1000
10	STP	1000	1000	1	1000
11	STP	1000	1000	1	1000
12	STP	1000	1000	1	1000
13	STP	1000	1000	1	1000
14	STP	1000	1000	1	1000
15	STP	1000	1000	1	1000
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18	STP	1000	1000	1	1000
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20	STP	1000	1000	1	1000
21	STP	1000	1000	1	1000
22	STP	1000	1000	1	1000
23	STP	1000	1000	1	1000
24	STP	1000	1000	1	1000
25	STP	1000	1000	1	1000
26	STP	1000	1000	1	1000
27	STP	1000	1000	1	1000
28	STP	1000	1000	1	1000
29	STP	1000	1000	1	1000
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74	STP	1000	1000	1	1000
75	STP	1000	1000	1	1000
76	STP	1000	1000	1	1000
77	STP	1000	1000	1	1000
78	STP	1000	1000	1	1000
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80	STP	1000	1000	1	1000
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84	STP	1000	1000	1	1000
85	STP	1000	1000	1	1000
86	STP	1000	1000	1	1000
87	STP	1000	1000	1	1000
88	STP	1000	1000	1	1000
89	STP	1000	1000	1	1000
90	STP	1000	1000	1	1000
91	STP	1000	1000	1	1000
92	STP	1000	1000	1	1000
93	STP	1000	1000	1	1000
94	STP	1000	1000	1	1000
95	STP	1000	1000	1	1000
96	STP	1000	1000	1	1000
97	STP	1000	1000	1	1000
98	STP	1000	1000	1	1000
99	STP	1000	1000	1	1000
100	STP	1000	1000	1	1000

MEASUREMENT

NOTES:-

1. ALL DIMENSIONS & LINES ARE TO BE MAINTAINED.
2. ALL THE AREAS INDICATED ARE TO BE MAINTAINED AS PER THE DRAWING.
3. COLUMNS ARE ONLY INDICATIVE AND WILL BE AS PER RELEVANT STRUCTURAL DRAWINGS.
4. ENTIRE BUILDING WILL BE CENTRALLY AIR-CONDITIONED.
5. ALL STORES & TOILETS, KITCHENS & PANTRIES WILL BE MECHANICALLY VENTILATED.
6. ALL EXISTING DOORS SHALL HAVE 1 HOUR FIRE RESISTANT RATING.
7. ALL LIFT, ESCALATOR & MACHINE ROOM SHOULD BE AS PER IS STANDARDS.
8. THE BUILDING SHALL BE FULLY SPRINKLED EQUIPPED WITH AUTOMATIC SPRINKLER SYSTEM.

KEY PLAN



SCALE :- N.T.S

PROJECT

PROPOSED SUBMISSION DRAWING FOR GALAXY BLUE SAPPHIRE PLAZA AT PLOT NO. C-03, SECTOR - 04, GREATER NOIDA (U.P.)

OWNER

M/S GLD INFRAPROJECTS PVT. LTD. UNIT NO.-105, 1ST FLOOR VARDHMAN SIDHANT SHOPPING PLAZA - I, LHC, SAVITA VIHAR, DELHI-92

ARCHITECT'S SEAL

OWNERS SEAL

Fire GLD Infra Projects Private Limited

Architectural Seal

ARCHITECT



Drawing Title

LANDSCAPE PLAN & AREA CALCULATION

Created by

MAXIMILIAN

Drawn by

ECCHIBABBARA

Drawing No

MA - GA - SANCTION

Scale

1:100

Date


13/09

Project

MA - GA - SANCTION

Sheet

02

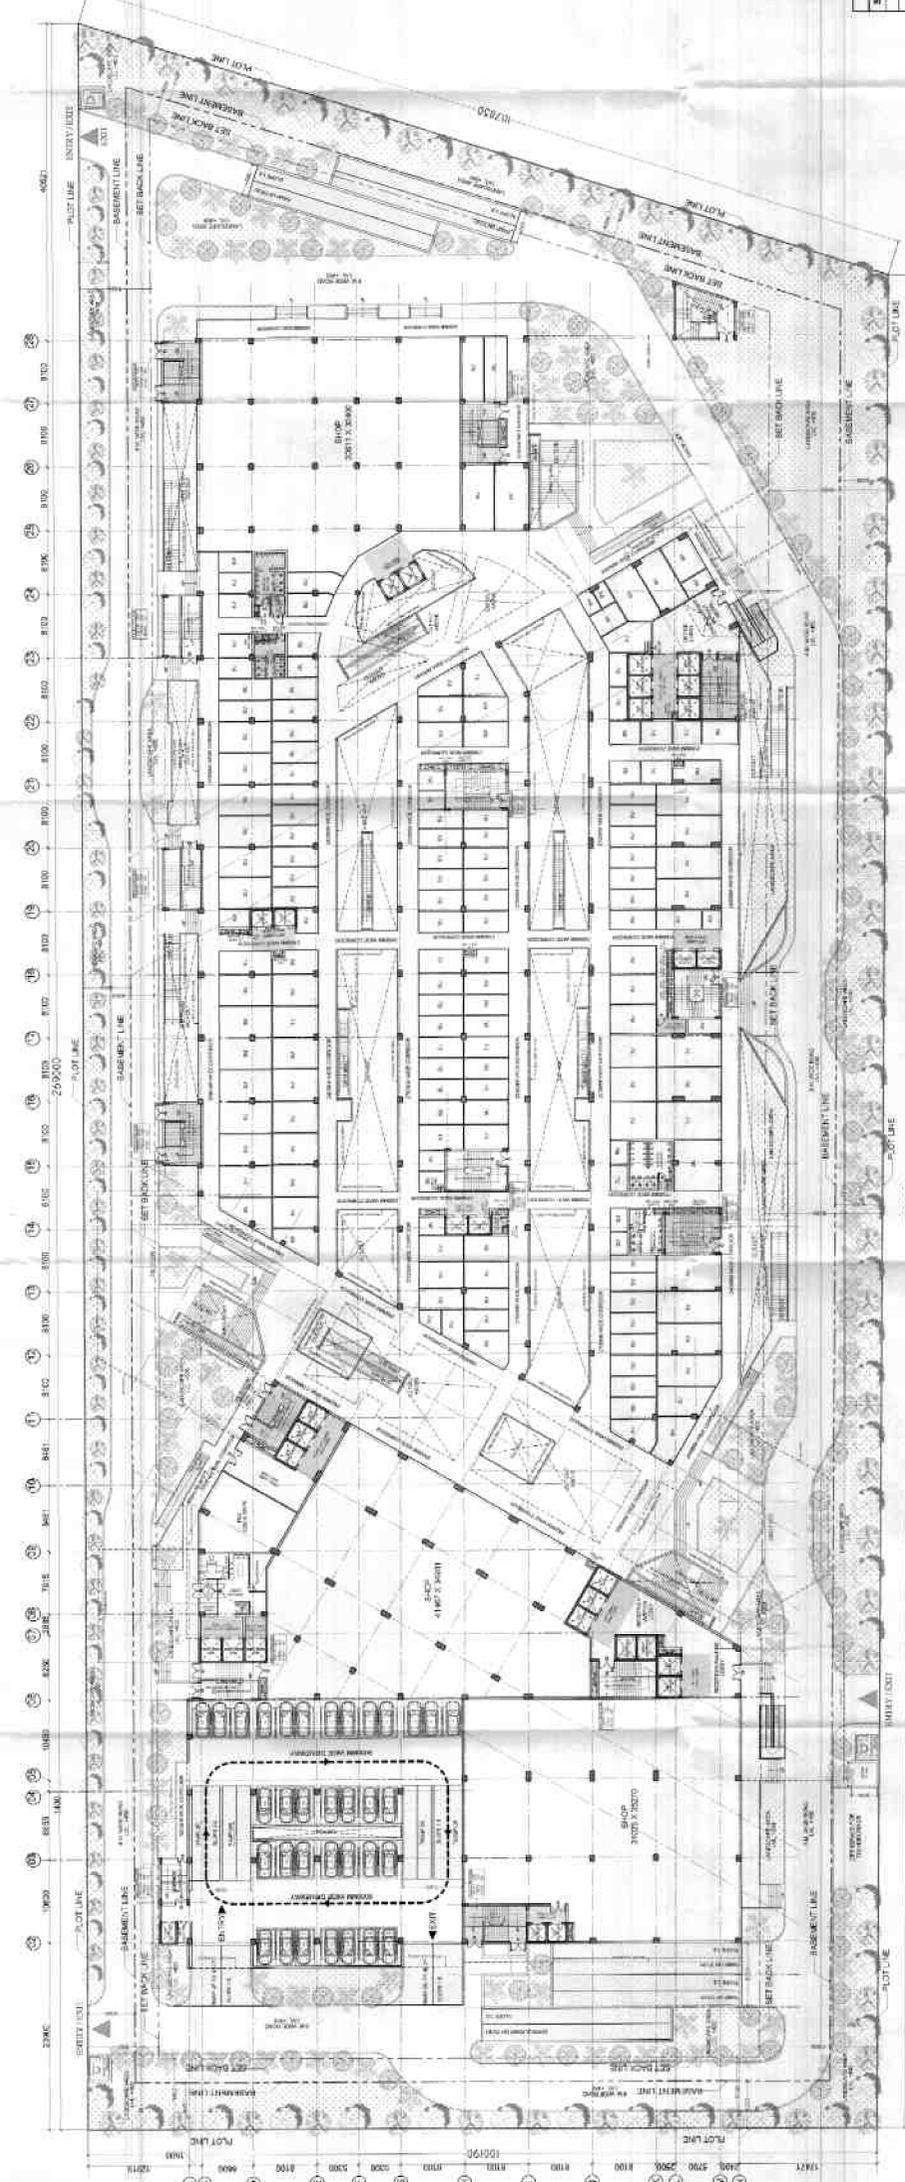

LANDSCAPE PLAN

S NO	X	Y	NOSE	AREA
L1	0.849	3.000	1	11.222
L2	0.849	3.000	1	11.222
L3	0.849	3.000	1	11.222
L4	2.422	5.000	1	11.222
L5	3.000	5.000	1	11.222
L6	12.546	3.000	1	58.455
L7	8.572	4.500	1	26.584
L8	7.683	8.000	1	45.115
L9	3.174	3.879	1	11.877
L10	3.255	3.735	0.5	6.039
L11	3.255	3.735	0.5	6.039
L12	3.255	3.735	0.5	6.039
L13	3.255	3.735	0.5	6.039
L14	3.255	3.735	0.5	6.039
L15	3.255	3.735	0.5	6.039
L16	3.255	3.735	0.5	6.039
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