


Scale: 1/4" = 1'-0"

Upper Area Detail
 (Dimensions are in feet and inches)

Area of Upper Basement
 86,270 sq. ft. (8,000 sq. ft. x 10.78)
 341,724 sq. ft. (31,000 sq. ft. x 11.02)
 341,724 sq. ft. (31,000 sq. ft. x 11.02)

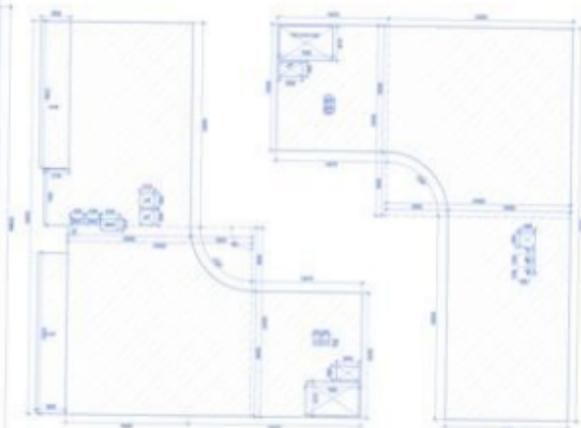

BASEMENT AREA DETAIL (UPPER)

86,270 x 40.000 = 3451,084 Sq.M

TOTAL AREA OF UPPER BASEMENT AFTER DEDUCTION
 3451,084 - 45,360 = 3405,724 Sq.M

BASEMENT AREA DETAIL (LOWER)

86,270 x 40.000 = 3451,084 Sq.M

TOTAL AREA OF LOWER BASEMENT AFTER DEDUCTION
 3451,084 - 45,360 = 3405,724 Sq.M

DEDUCTION AREA DETAIL

3,800 x 10.884 = 41,359 Sq.M
 Total = 45,360 Sq.M

DEDUCTION AREA DETAIL

3,800 x 10.884 = 41,359 Sq.M
 Total = 45,360 Sq.M

GROUND FLOOR AREA DETAIL

16,000 x 14.670 = 236,720 Sq.M
 24,000 x 24,000 = 576,000 Sq.M
 3.14 x 3.14 x 8.00 x 8.00 = 63,168 Sq.M
 176,000 - 63,168 = 112,832 Sq.M
 16,000 x 26.600 = 425,600 Sq.M
 3,100 x 7,000 = 21,700 Sq.M
 3,800 x 18.600 = 70,680 Sq.M
 3,800 x 20.500 = 77,900 Sq.M

16,000 x 14.670 = 236,720 Sq.M
 24,000 x 24,000 = 576,000 Sq.M
 3.14 x 3.14 x 8.00 x 8.00 = 63,168 Sq.M
 176,000 - 63,168 = 112,832 Sq.M
 16,000 x 26.600 = 425,600 Sq.M
 3,100 x 7,000 = 21,700 Sq.M
 3,800 x 18.600 = 70,680 Sq.M
 3,800 x 20.500 = 77,900 Sq.M

TOTAL AREA OF GROUND FLOOR
 231,520 + 525,760 + 112,288 + 22,256 + 70,680 + 77,900
 = 1,039,304 Sq.M

PROFESSIONAL ENGINEER'S CERTIFICATE
 No. 12345
 State of Florida
 License Expires 12/31/2012

REVISIONS

No.	Description	Date
1	Issue for Review	12/31/2012
2	Approved for Construction	12/31/2012

PROJECT INFORMATION

PROJECT NO. 12345
 PROJECT NAME: [REDACTED]
 CLIENT: [REDACTED]
 ADDRESS: [REDACTED]

DATE: 12/31/2012

SCALE: 1/4" = 1'-0"

DESIGNED BY: [REDACTED]
 CHECKED BY: [REDACTED]
 DRAWN BY: [REDACTED]

PROFESSIONAL ENGINEER'S SEAL


STATE OF FLORIDA

PROFESSIONAL ENGINEER

NO. 12345

EXPIRES 12/31/2012


LOWER BASEMENT FLOOR PLAN
SCALE 1/8" = 1'-0"

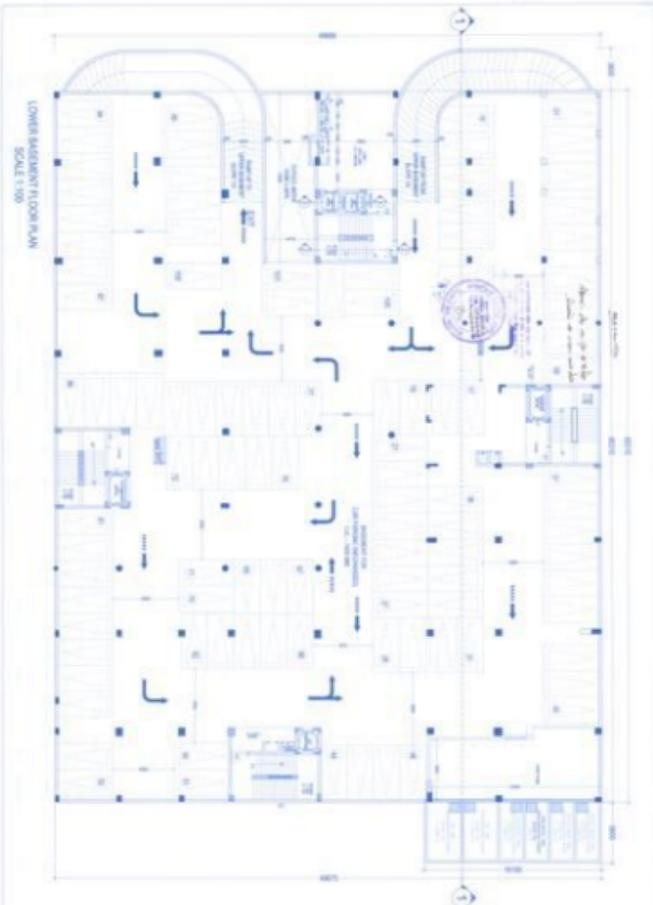

1	PROJECT	LOWER BASEMENT FLOOR PLAN
2	DATE	10/10/2010
3	SCALE	1/8" = 1'-0"
4	DRAWN BY	...
5	CHECKED BY	...
6	APPROVED BY	...
7	DATE	...
8	PROJECT NO.	...
9	CLIENT	...
10	LOCATION	...
11	DESCRIPTION	...
12	REVISIONS	...

ARCHITECT
1234 MAIN STREET
CITY, STATE, ZIP
PHONE: (555) 123-4567
FAX: (555) 987-6543
WWW.ABCARCHITECTS.COM

SCHEDULE	
FOUNDATION	1000000
CONCRETE WORK	1000000
STEEL WORK	1000000
MECHANICAL WORK	1000000
ELECTRICAL WORK	1000000
PAINT WORK	1000000
LANDSCAPING	1000000
ROAD WORK	1000000
UTILITIES	1000000
CONTINGENCY	1000000
TOTAL	10000000

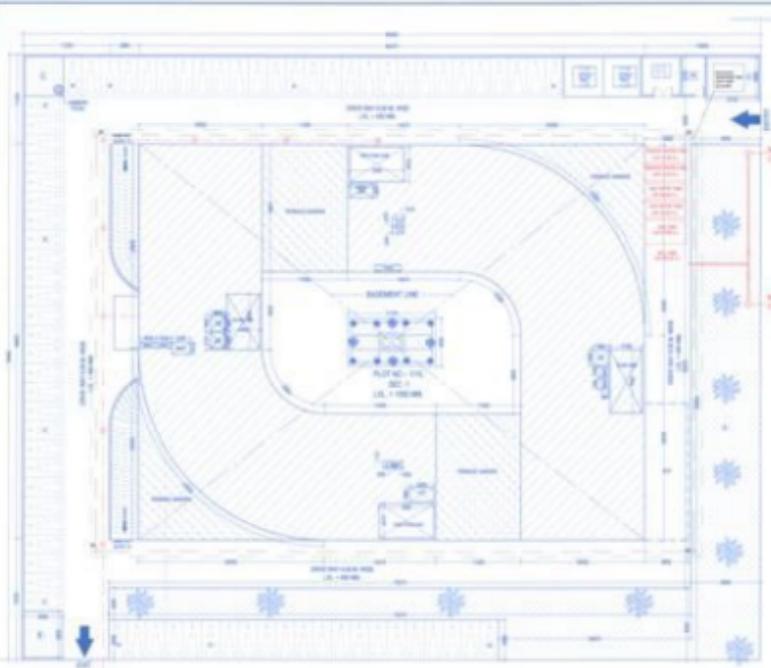

SITE PLAN


SPECIAL NOTE
 PROPOSED COMMERCIAL COMPLEX
 AT PLOT NO. 102, SECT. V
 GUNTUR ROAD EXTENSION,
 LICENCE - UTTAR PRADESH
 THIS DRAWING HAS BEEN PREPARED UNDER MASTER PLAN 2002

- Notes**
1. All dimensions are given in meters unless otherwise specified.
 2. All walls are to be constructed with 230 mm thick brickwork.
 3. All floors are to be finished with 125 mm concrete over 100 mm sand.
 4. All roofs are to be finished with 125 mm concrete over 100 mm sand.
 5. All roofs are to be finished with 125 mm concrete over 100 mm sand.
 6. All roofs are to be finished with 125 mm concrete over 100 mm sand.
 7. All roofs are to be finished with 125 mm concrete over 100 mm sand.
 8. All roofs are to be finished with 125 mm concrete over 100 mm sand.
 9. All roofs are to be finished with 125 mm concrete over 100 mm sand.
 10. All roofs are to be finished with 125 mm concrete over 100 mm sand.

DATE: 10/10/2010
 SCALE: 1:1000
 DRAWN BY: [Signature]




Project Name	PROPOSED COMMERCIAL COMPLEX
Plot No.	102
Section	V
Location	GUNTUR ROAD EXTENSION, LICENCE - UTTAR PRADESH
Scale	1:1000
Date	10/10/2010
Drawn By	[Signature]
Checked By	[Signature]
Approved By	[Signature]
Professional Engineer	[Signature]
Registration No.	[Number]
State	Uttar Pradesh
City	Guntur
Address	[Address]
Phone	[Phone Number]
Mobile	[Mobile Number]
E-mail	[Email Address]

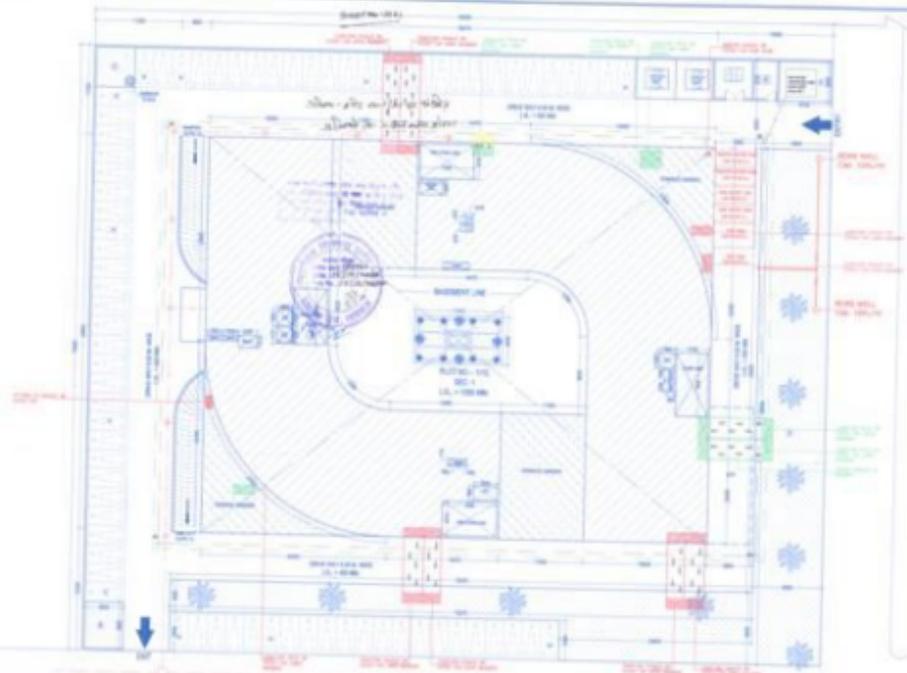

MECHANICAL VENTILATION SITE PLAN

MECHANICAL VENTILATION SYSTEM
 AT PLANT AND BLDG. 1
 SCHEMATIC EXTENSION
 (LAYOUT PLAN)
 THE DRAWING HAS BEEN PREPARED UNDER
 MATTER NO. 200

NO.	DATE
1	2000/01/01
2	2000/01/01
3	2000/01/01
4	2000/01/01
5	2000/01/01
6	2000/01/01
7	2000/01/01
8	2000/01/01
9	2000/01/01
10	2000/01/01
11	2000/01/01
12	2000/01/01
13	2000/01/01
14	2000/01/01
15	2000/01/01
16	2000/01/01
17	2000/01/01
18	2000/01/01
19	2000/01/01
20	2000/01/01
21	2000/01/01
22	2000/01/01
23	2000/01/01
24	2000/01/01
25	2000/01/01
26	2000/01/01
27	2000/01/01
28	2000/01/01
29	2000/01/01
30	2000/01/01
31	2000/01/01
32	2000/01/01
33	2000/01/01
34	2000/01/01
35	2000/01/01
36	2000/01/01
37	2000/01/01
38	2000/01/01
39	2000/01/01
40	2000/01/01
41	2000/01/01
42	2000/01/01
43	2000/01/01
44	2000/01/01
45	2000/01/01
46	2000/01/01
47	2000/01/01
48	2000/01/01
49	2000/01/01
50	2000/01/01

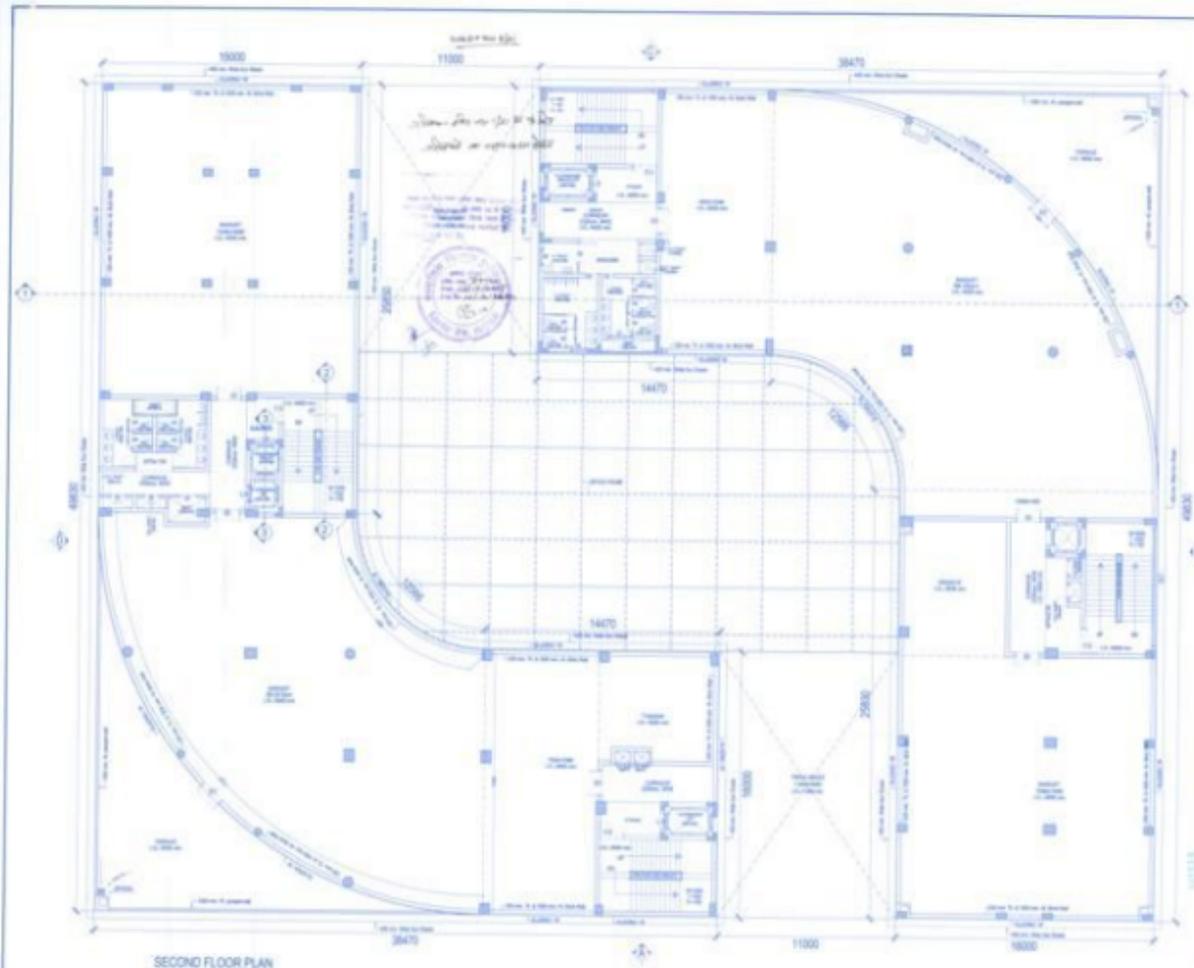

SECOND FLOOR PLAN

GENERAL INFORMATION			
PROJECT NO.	10000		
DATE OF ISSUE	11/11/2011		
PROJECT NAME	...		
DESIGNER	...		
SCALE	1:100		
LIST OF ROOMS			
Room No.	Room Name	Area (sq.m)	Volume (cu.m)
01
02
03
100

