


TENTH FLOOR PLAN
SCALE - 1:100

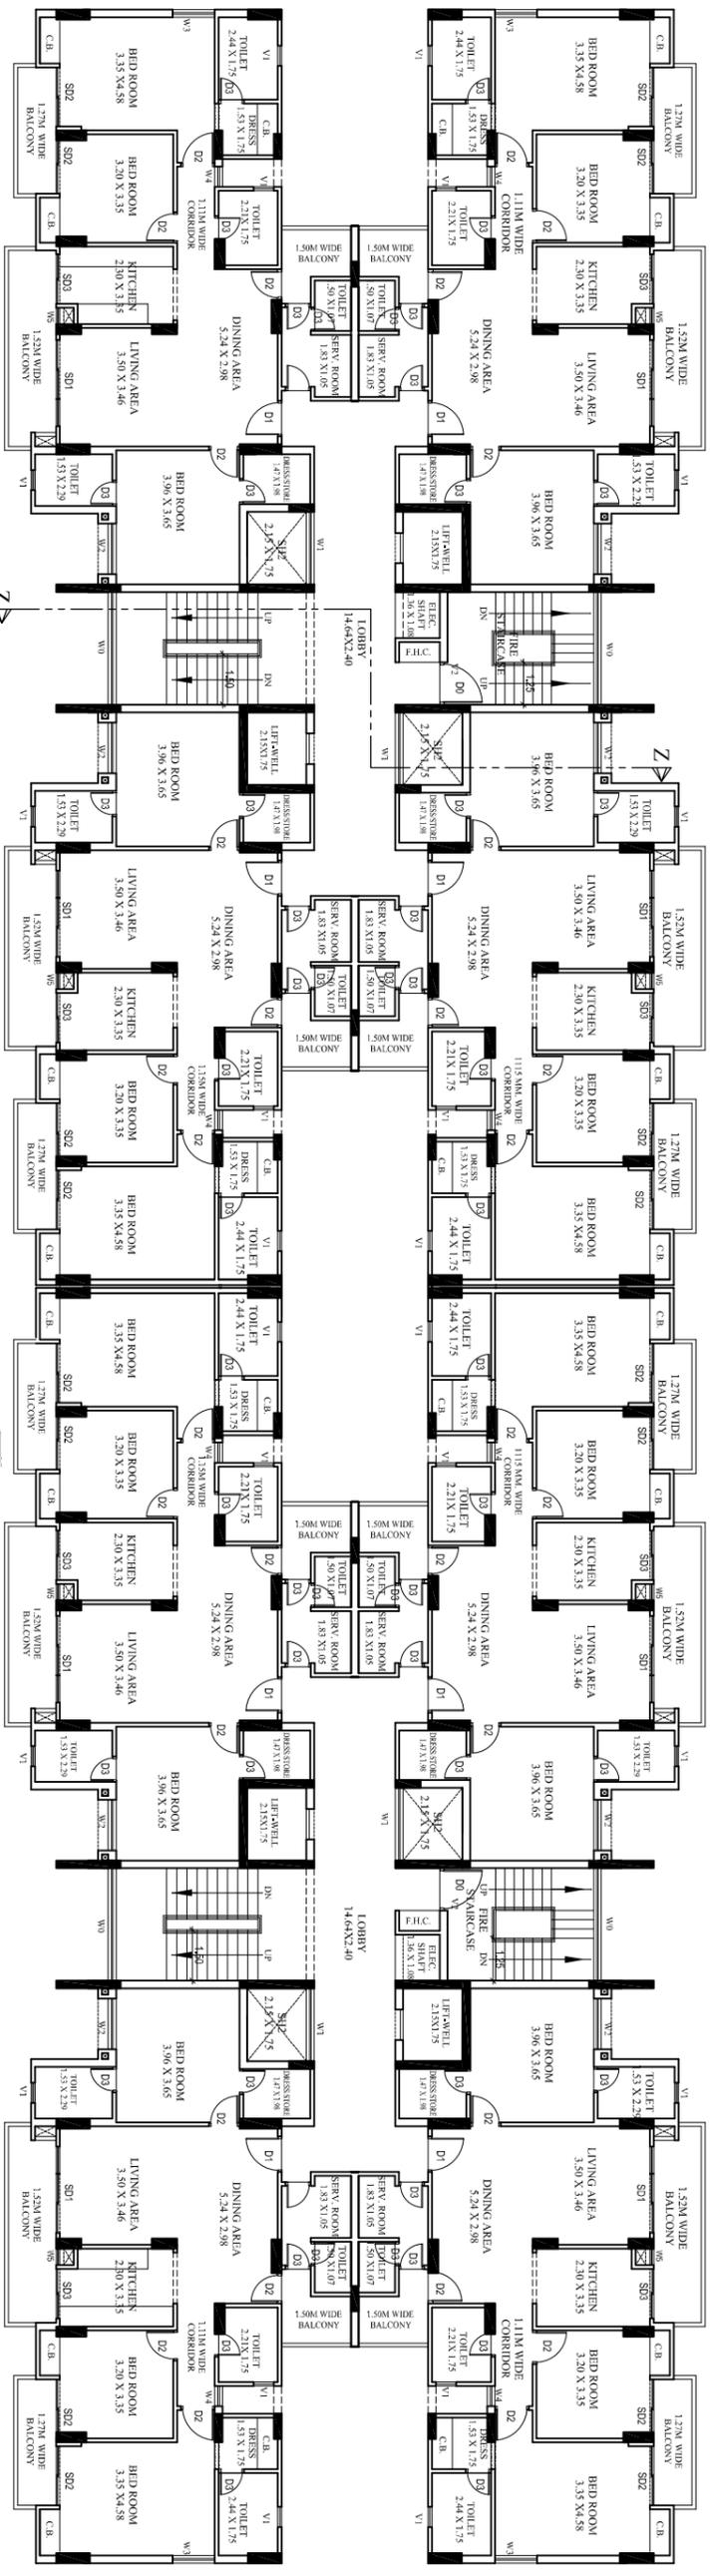

BLOCK - A
TYPICAL FLOOR PLAN (FIRST TO NINTH FLOOR)
SCALE - 1:100

SCHEDULE DOOR & WINDOW

TYPE	WIDTH	HEIGHT	REMARKS
S01	2.28	2.10	SLIDING DOOR WINDOW
S02	1.75	2.10	SLIDING DOOR WINDOW
S03	1.47	2.10	SLIDING DOOR WINDOW
D0	1.25	2.10	DOOR
D1	1.25	2.10	DOOR
D2	1.20	2.10	DOOR
D3	0.75	2.10	DOOR
W0	3.32	1.20	WINDOW
W1	2.15	1.20	WINDOW
W2	1.50	1.20	WINDOW
W3	1.25	1.20	WINDOW
W4	0.60	1.20	WINDOW
W5	0.60	1.20	WINDOW
VI	0.60	1.20	VENTILATOR

EXIST. & PROP. GROUP HOUSING PLAN OF
ROYAL GREENS M/S OMEGA DEVCON (P)
LTD.
SITE AT - KHASRA NO.-71,72,73, 74
GRAM MANOHARPUR, DELHI ROAD,
MORADABAD.

DRG. TITLE
CORPORATION DRG.
BLOCK - A


SCALE
1:100
NORTH

OWNERSIGN.


ARCHITECT SIGN.
R.K. MALIK & ASSOCIATES
ARCHITECT - ENGINEER
INTERIOR - EXTERIOR
ENVIRONMENTAL CONSULTANT

DATE
AUGUST 2016


शुद्धता के बिना किसी भी प्रकार का
गारंटी नहीं है।
यदि कोई भी त्रुटि या त्रुटि पाई जाएगी
तो इसे ठीक कर दिया जाएगा।
आपका धन्यवाद।

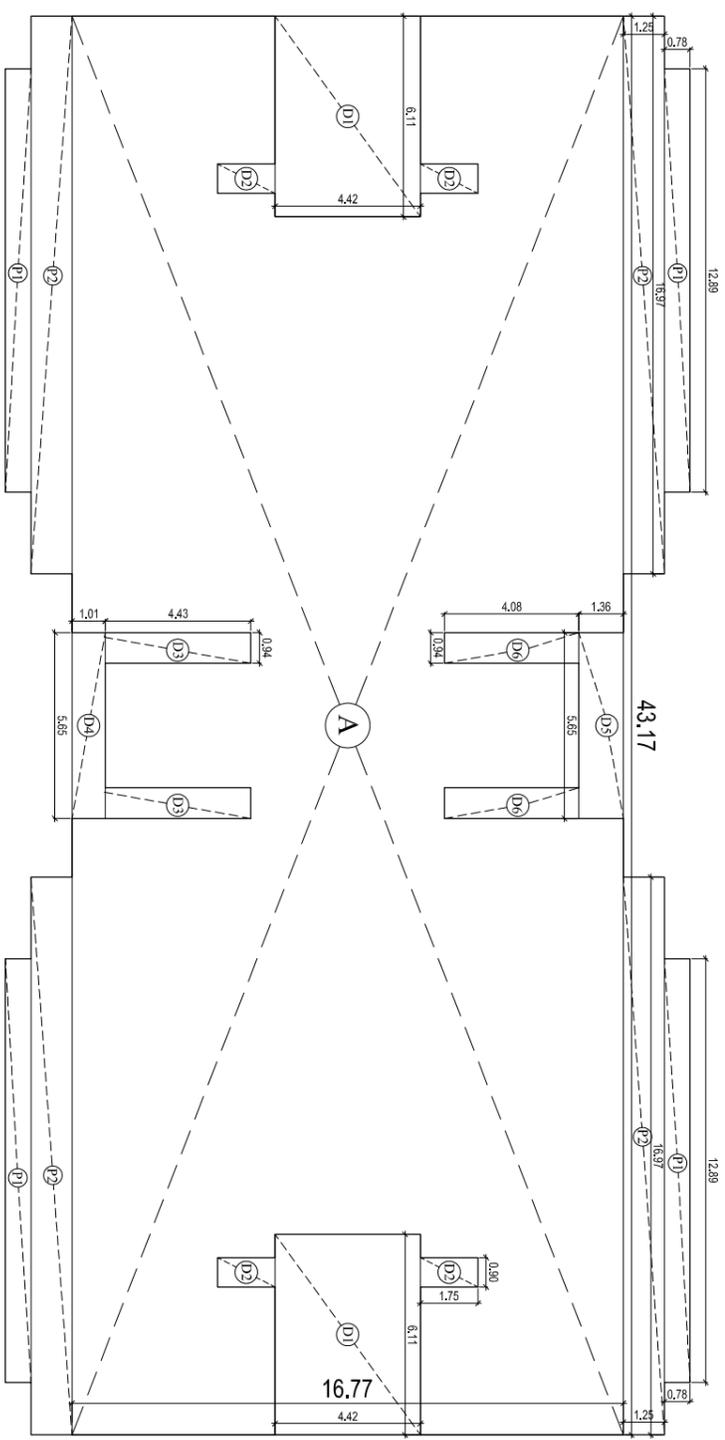

BLOCK - B(TOWER-3)
COVERAGE AREA CALCULATION
SCALE - 1:100

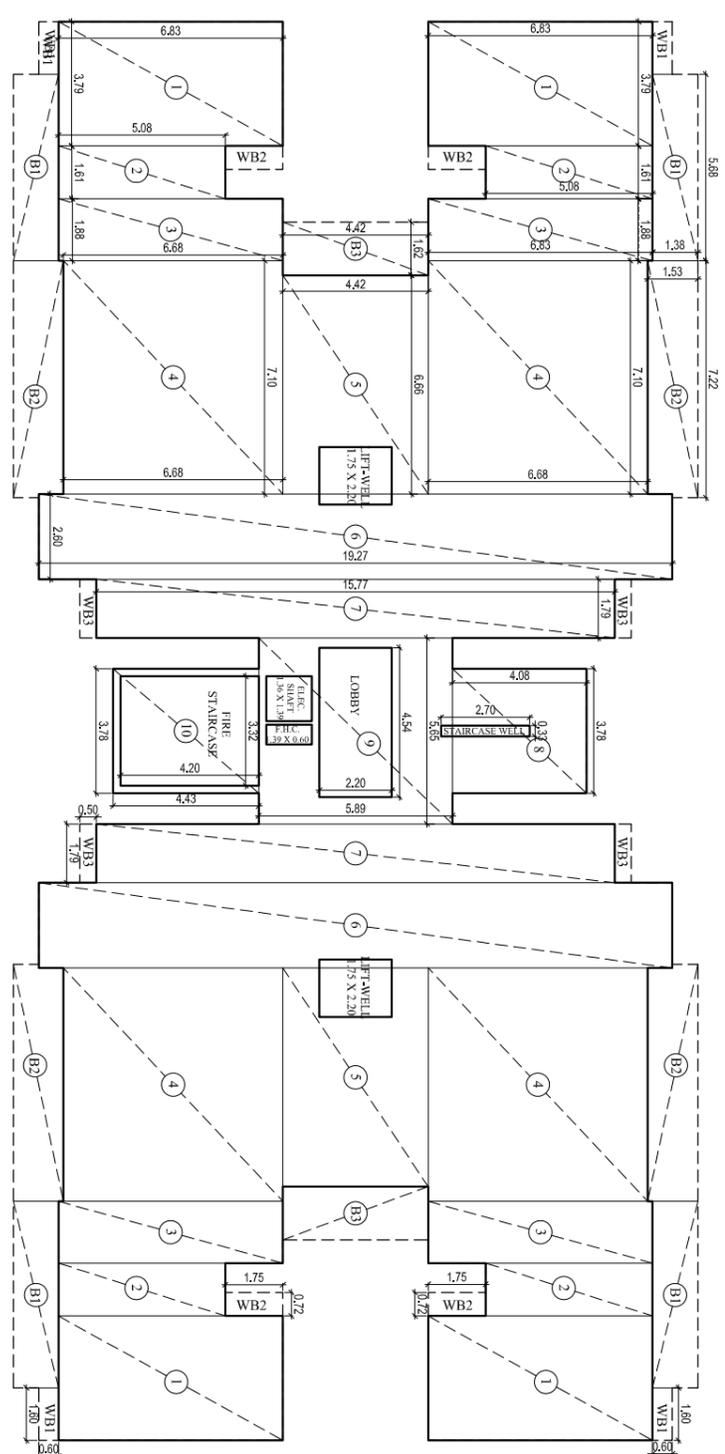

BLOCK - B (TOWER-3)
F.A.R. AREA CALCULATION
SCALE - 1:100

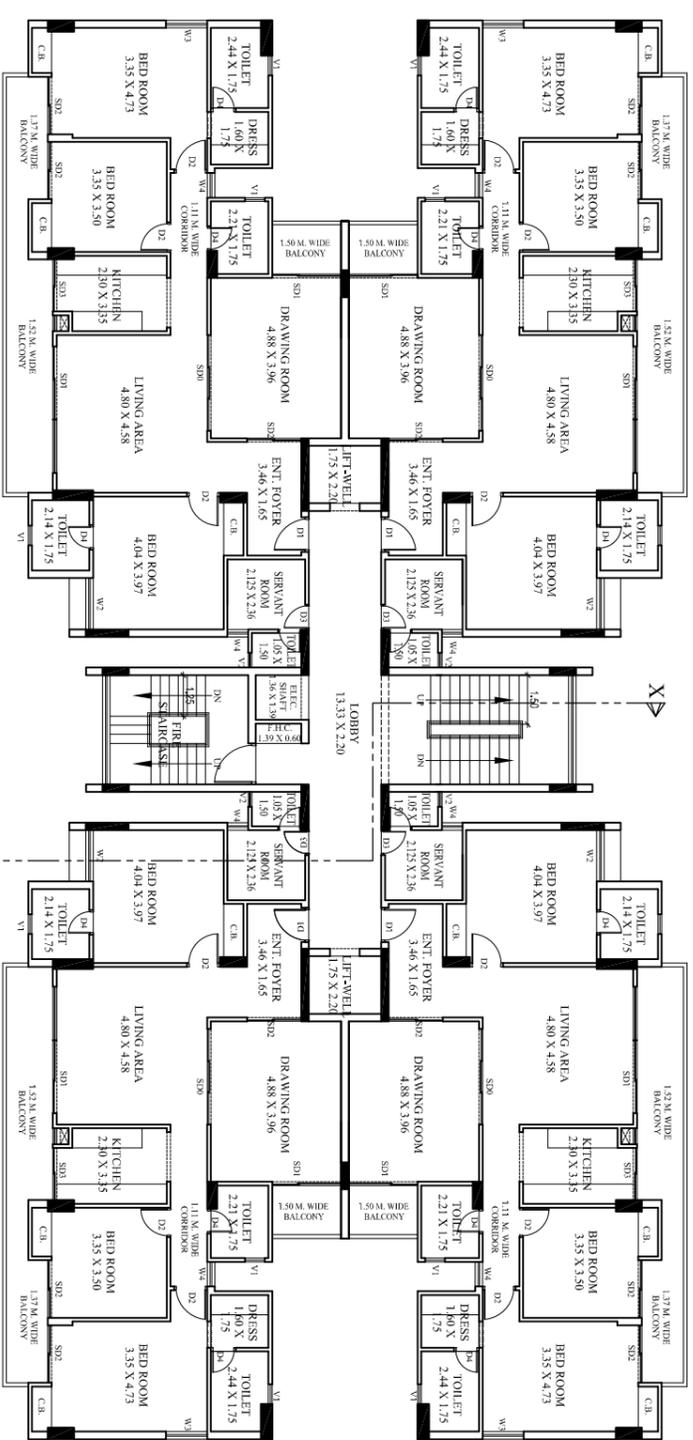


BLOCK - B (TOWER -3)
TYPICAL FLOOR PLAN
(FIRST TO FIFTH FLOOR)
SCALE - 1:100

SCHEDULE DOOR & WINDOW

TYPE	WIDTH	HEIGHT	REMARKS
S00	2.21	2.10	SLEEPING DOOR WINDOW
S01	2.22	2.10	SLEEPING DOOR WINDOW
S02	1.75	2.10	SLEEPING DOOR WINDOW
S03	1.58	2.10	SLEEPING DOOR WINDOW
D1	1.65	2.10	DOOR
D2	1.00	2.10	DOOR
D3	0.75	2.10	DOOR
W1	1.20	1.20	WINDOW
W2	1.20	1.20	WINDOW
W3	1.25	1.20	WINDOW
W4	0.75	1.20	WINDOW
V1	0.90	1.00	VENTILATOR
V2	0.40	1.00	VENTILATOR

COVERGE AREA STATEMENT

S no	Dimensions (Meters)	NCS	Area(SQM)
A	43.17	1	721.96
B	43.17	1	721.96
C	43.17	1	721.96
D	43.17	1	721.96
E	43.17	1	721.96
F	43.17	1	721.96
G	43.17	1	721.96
H	43.17	1	721.96
I	43.17	1	721.96
J	43.17	1	721.96
K	43.17	1	721.96
L	43.17	1	721.96
M	43.17	1	721.96
N	43.17	1	721.96
O	43.17	1	721.96
P	43.17	1	721.96
Q	43.17	1	721.96
R	43.17	1	721.96
S	43.17	1	721.96
T	43.17	1	721.96
U	43.17	1	721.96
V	43.17	1	721.96
W	43.17	1	721.96
X	43.17	1	721.96
Y	43.17	1	721.96
Z	43.17	1	721.96
TOTAL			1593.33

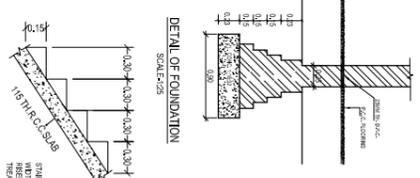

DETAIL OF STAIR
SCALE 1:50

Area Statement

S no	Dimensions(Meters)	Vol. (Area)(SQM)
1	1.75	3.06
2	1.61	2.59
3	1.61	2.59
4	1.61	2.59
5	1.61	2.59
6	1.61	2.59
7	1.61	2.59
8	1.61	2.59
9	1.61	2.59
10	1.61	2.59
Total		25.44

Non FAR Areas

S no	Dimensions(Meters)	Area(SQM)
1	1.75	3.06
2	1.75	3.06
3	1.75	3.06
4	1.75	3.06
5	1.75	3.06
6	1.75	3.06
7	1.75	3.06
8	1.75	3.06
9	1.75	3.06
10	1.75	3.06
Total		30.60

Area Statement

S no	Dimensions(Meters)	Area(SQM)
1	1.75	3.06
2	1.75	3.06
3	1.75	3.06
4	1.75	3.06
5	1.75	3.06
6	1.75	3.06
7	1.75	3.06
8	1.75	3.06
9	1.75	3.06
10	1.75	3.06
Total		30.60

Area Statement

S no	Dimensions(Meters)	Area(SQM)
1	1.75	3.06
2	1.75	3.06
3	1.75	3.06
4	1.75	3.06
5	1.75	3.06
6	1.75	3.06
7	1.75	3.06
8	1.75	3.06
9	1.75	3.06
10	1.75	3.06
Total		30.60

Area Statement

S no	Dimensions(Meters)	Area(SQM)
1	1.75	3.06
2	1.75	3.06
3	1.75	3.06
4	1.75	3.06
5	1.75	3.06
6	1.75	3.06
7	1.75	3.06
8	1.75	3.06
9	1.75	3.06
10	1.75	3.06
Total		30.60

Area Statement

S no	Dimensions(Meters)	Area(SQM)
1	1.75	3.06
2	1.75	3.06
3	1.75	3.06
4	1.75	3.06
5	1.75	3.06
6	1.75	3.06
7	1.75	3.06
8	1.75	3.06
9	1.75	3.06
10	1.75	3.06
Total		30.60

Area Statement

S no	Dimensions(Meters)	Area(SQM)
1	1.75	3.06
2	1.75	3.06
3	1.75	3.06
4	1.75	3.06
5	1.75	3.06
6	1.75	3.06
7	1.75	3.06
8	1.75	3.06
9	1.75	3.06
10	1.75	3.06
Total		30.60

Area Statement

S no	Dimensions(Meters)	Area(SQM)
1	1.75	3.06
2	1.75	3.06
3	1.75	3.06
4	1.75	3.06
5	1.75	3.06
6	1.75	3.06
7	1.75	3.06
8	1.75	3.06
9	1.75	3.06
10	1.75	3.06
Total		30.60

Area Statement

S no	Dimensions(Meters)	Area(SQM)
1	1.75	3.06
2	1.75	3.06
3	1.75	3.06
4	1.75	3.06
5	1.75	3.06
6	1.75	3.06
7	1.75	3.06
8	1.75	3.06
9	1.75	3.06
10	1.75	3.06
Total		30.60

Area Statement

S no	Dimensions(Meters)	Area(SQM)
1	1.75	3.06
2	1.75	3.06
3	1.75	3.06
4	1.75	3.06
5	1.75	3.06
6	1.75	3.06
7	1.75	3.06
8	1.75	3.06
9	1.75	3.06
10	1.75	3.06
Total		30.60

Area Statement

S no	Dimensions(Meters)	Area(SQM)
1	1.75	3.06
2	1.75	3.06
3	1.75	3.06
4	1.75	3.06
5	1.75	3.06
6	1.75	3.06
7	1.75	3.06
8	1.75	3.06
9	1.75	3.06
10	1.75	3.06
Total		30.60

Area Statement

S no	Dimensions(Meters)	Area(SQM)
1	1.75	3.06
2	1.75	3.06
3	1.75	3.06
4	1.75	3.06
5	1.75	3.06
6	1.75	3.06
7	1.75	3.06
8	1.75	3.06
9	1.75	3.06
10	1.75	3.06
Total		30.60

Area Statement

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1	1.75	3.06
2	1.75	3.06
3	1.75	3.06
4	1.75	3.06
5	1.75	3.06
6	1.75	3.06
7	1.75	3.06
8	1.75	3.06
9	1.75	3.06
10	1.75	3.06
Total		30.60

Area Statement

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1	1.75	3.06
2	1.75	3.06
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10	1.75	3.06
Total		30.60

Area Statement

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10	1.75	3.06
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Area Statement

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Total		30.60

