


BP-253/4/175-672/12/14
 5.4.2014

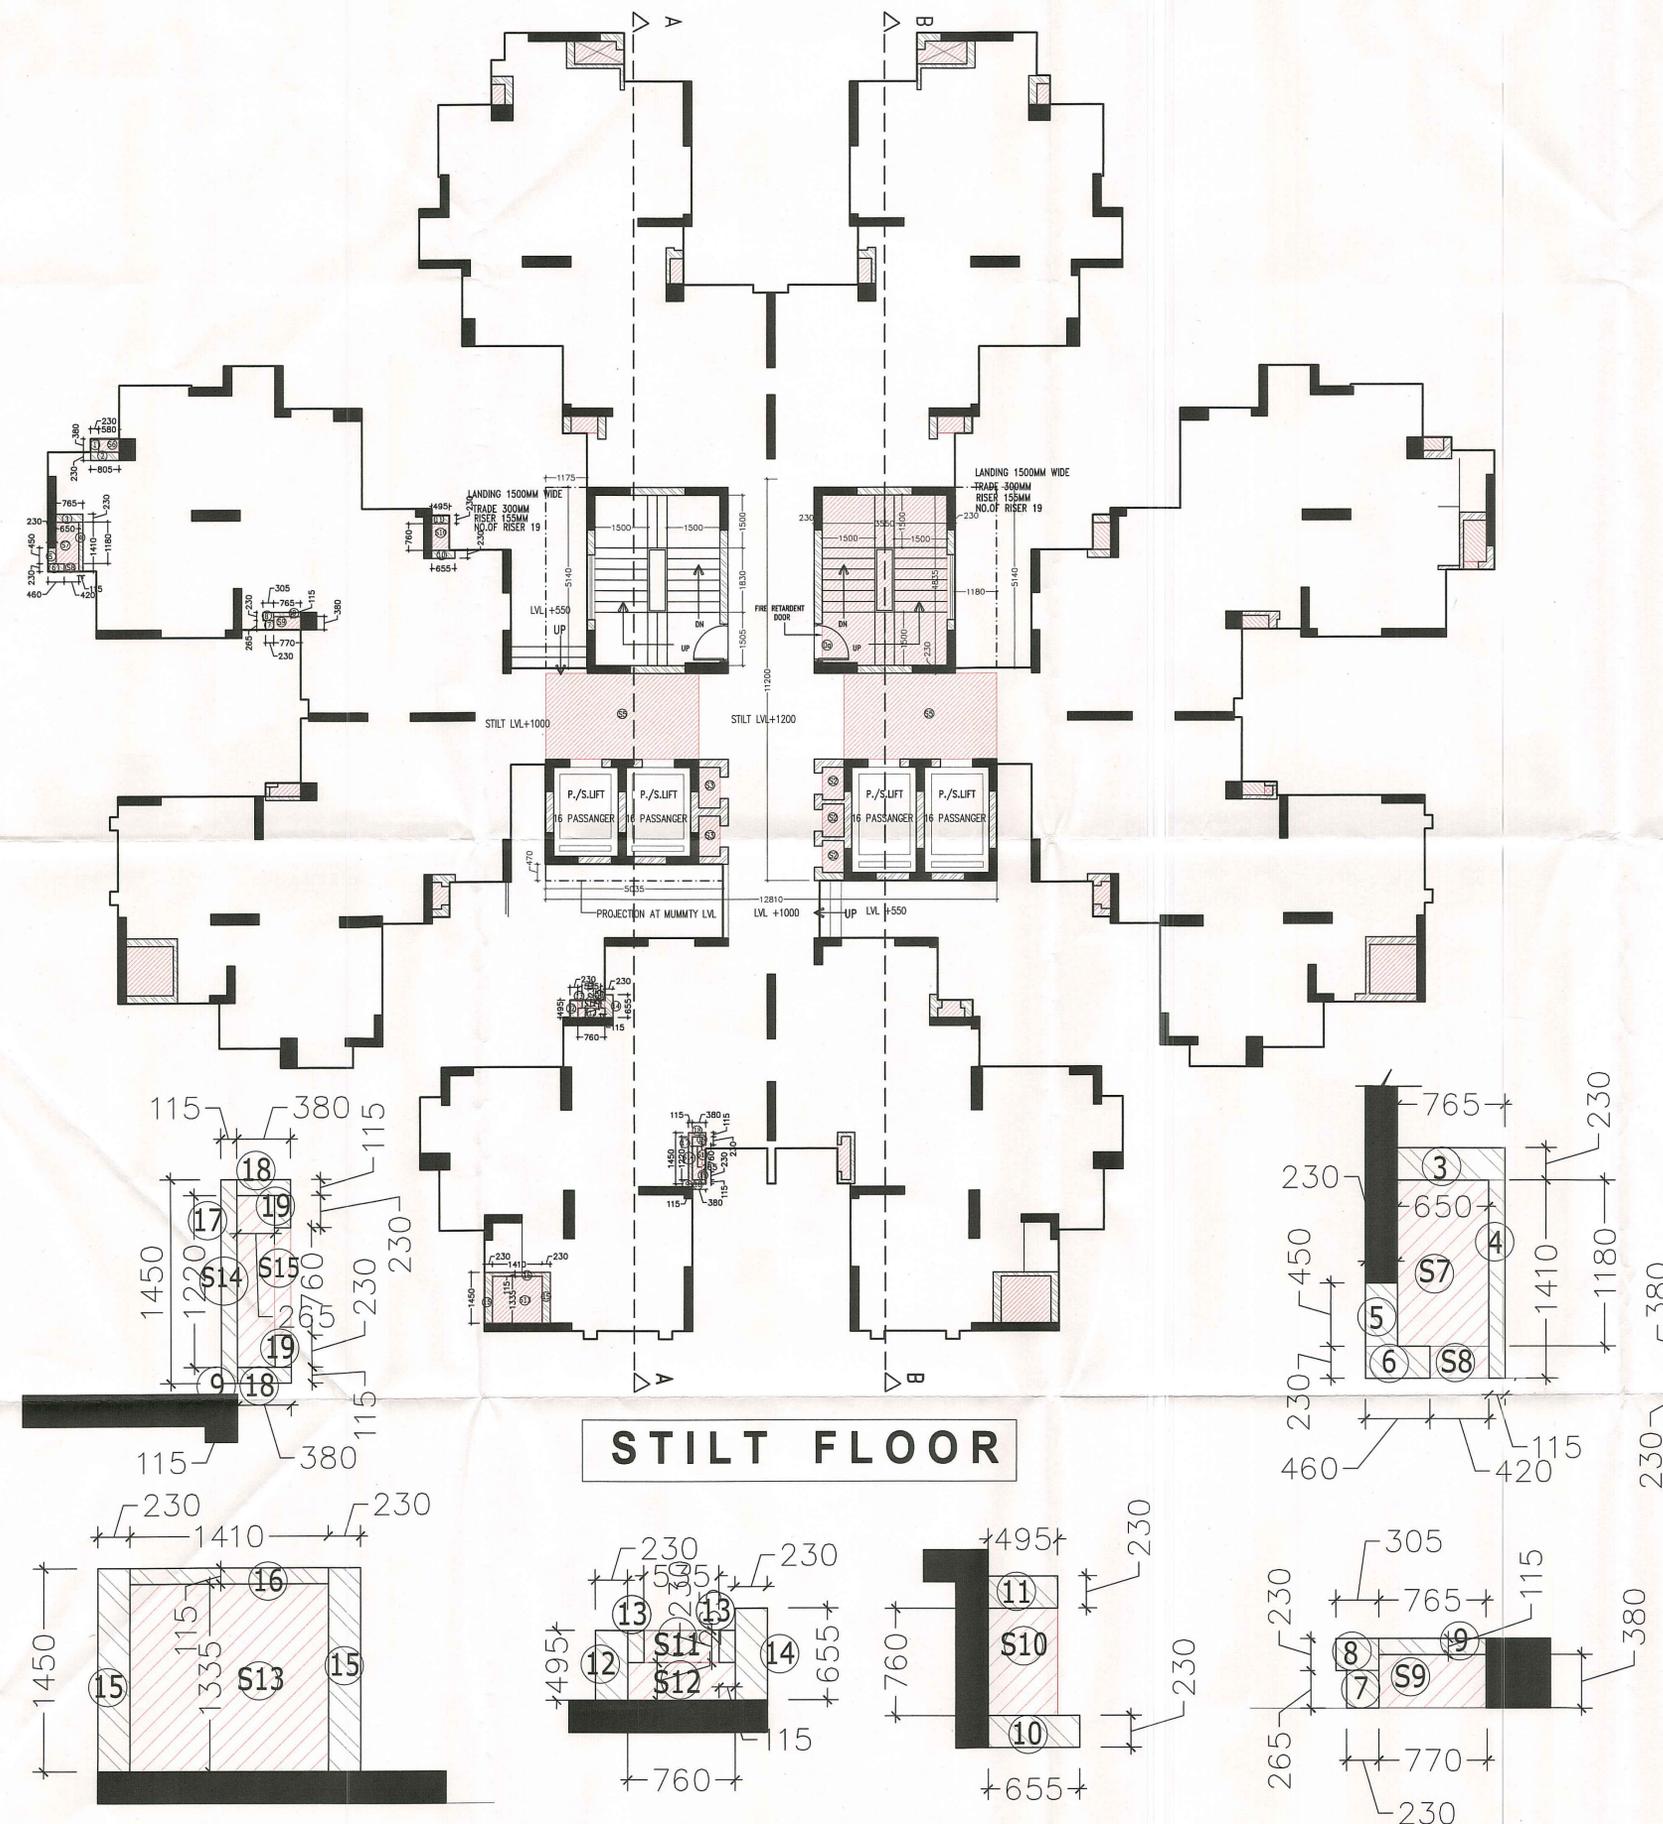


STILT FLOOR

FAR CORE AREA AT STILT FLOOR				
CORE AREA				
Shape	Factor	Length	Width	Area
Addition (all figures in Meter)				
X	1	12.810	11.200	143.472
X TOTAL				= 143.472
Subtraction (all figures in Meter)				
1	2	1.180	5.140	12.130
2	1	5.035	0.470	2.366
3	1	0.450	1.730	0.779
F.STAIR	1	3.545	4.830	17.122
S2	3	0.610	0.930	1.702
S3	2	0.610	1.182	1.442
S5	2	4.340	2.440	21.179
TOTAL				56.721
CORE FAR AREA LISFT /STAIR A= (X-Y)				86.751
CORE-15% ANCILLARY AREA				
F.STAIR	1	3.545	4.830	17.122
S2	3	0.610	0.930	1.702
S3	2	0.610	1.182	1.442
S5	2	4.340	2.440	21.179
TOTAL				41.445

STILT TOWER -15% ANCILLARY AREA				
S6	4	0.610	0.580	1.415
S7	4	0.650	1.180	3.068
S8	4	0.420	0.230	0.386
S9	4	0.770	0.380	1.170
S10	4	0.760	0.465	1.505
S11	4	0.535	0.230	0.492
S12	4	0.760	0.265	0.806
S13	4	1.410	1.335	7.529
S14	4	1.220	0.265	1.293
S15	4	0.760	0.115	0.350
TOTAL				18.015
STILT TOWER FAR AREA OF SHAFT WALL				
1	4	0.230	0.380	0.350
2	4	0.800	0.230	0.736
3	4	0.765	0.230	0.704
4	4	0.115	1.410	0.649
5	4	0.450	0.230	0.414
6	4	0.230	0.460	0.423
7	4	0.230	0.265	0.244
8	4	0.305	0.230	0.281
9	4	0.765	0.115	0.352
10	4	0.655	0.230	0.603
11	4	0.495	0.230	0.455
12	4	0.495	0.230	0.455
13	8	0.230	0.115	0.212
14	4	0.655	0.230	0.603
15	8	1.450	0.230	2.668
16	4	1.410	0.115	0.649
17	4	1.450	0.115	0.667
18	8	0.380	0.115	0.350
19	8	0.230	0.115	0.212
TOTAL				11.024
Projection area at Mumty lvi				
1	2	1.180	5.140	12.130
2	1	5.035	0.470	2.366
total				14.497

STILT AREA			
DISCRPTION	FAR	15% ANCILLARY	
CORE	86.751	41.445	
TOWER	11.024	18.015	
TOTAL	97.775	59.460	

NOTE:-
 THIS DRAWING ALREADY APPROVED
 ON FEBRUARY 5,2014 AS PER
 F.A.R 2.75 .
 PREVIOUS DRAWING NO.- DWG-07
 NEW DRAWING NO.- DWG-13

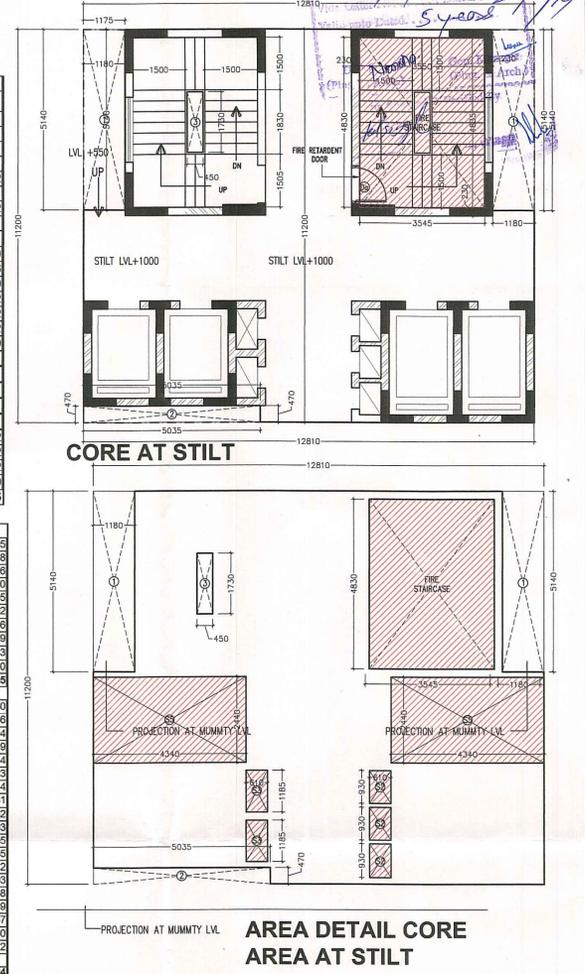

CORE AT STILT

AREA DETAIL CORE AREA AT STILT

SCHEDULE OF OPENINGS

TOWER A & H	Size	Sill	Lintel
	1200 x 2450	+0.00	+2.45

SUBMISSION DRAWING

NOTES

- BUILDING IS DESIGNED (STRUCTURES) AS PER RELEVANT IS CODES FOR EARTH QUAKE RESISTANCE.
- MECHANICAL VENTILATION SYSTEM PROVIDED AS PER NBC.

ARCHITECT
 K-47, KAILASH COLONY NEW DELHI-48
 PHONE: 011-46556000 FAX: 46556011

OWNER'S SIGNATURE
 For Rajesh Projects (India) Pvt. Ltd.

 B.K. GARWAL
 Director - Operations


ARCHITECT'S SIGNATURE


 Vishish Jaiswal
 Architect
 Registration No. CA/2003/1885

CLIENT
 RAJESH PROJECT INDIA PVT LTD.
 PROJECT:
 PROPOSED GROUP HOUSING
 AT PLOT NO. GH 07A SECTOR 16B, GREATER NOIDA
 WEST, GAUTAMBUDH NAGAR, UP - 201308

DRAWING TITLE:
**STILT PLAN
 TOWER- C, D & H**

SCALE : 1 : 100 DWG. NO.
 DATE : DWG -13

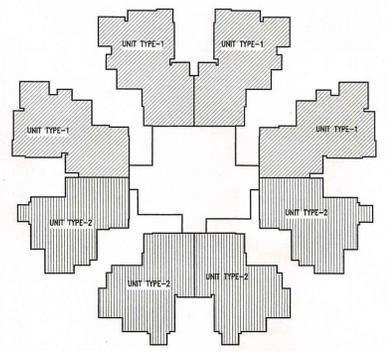

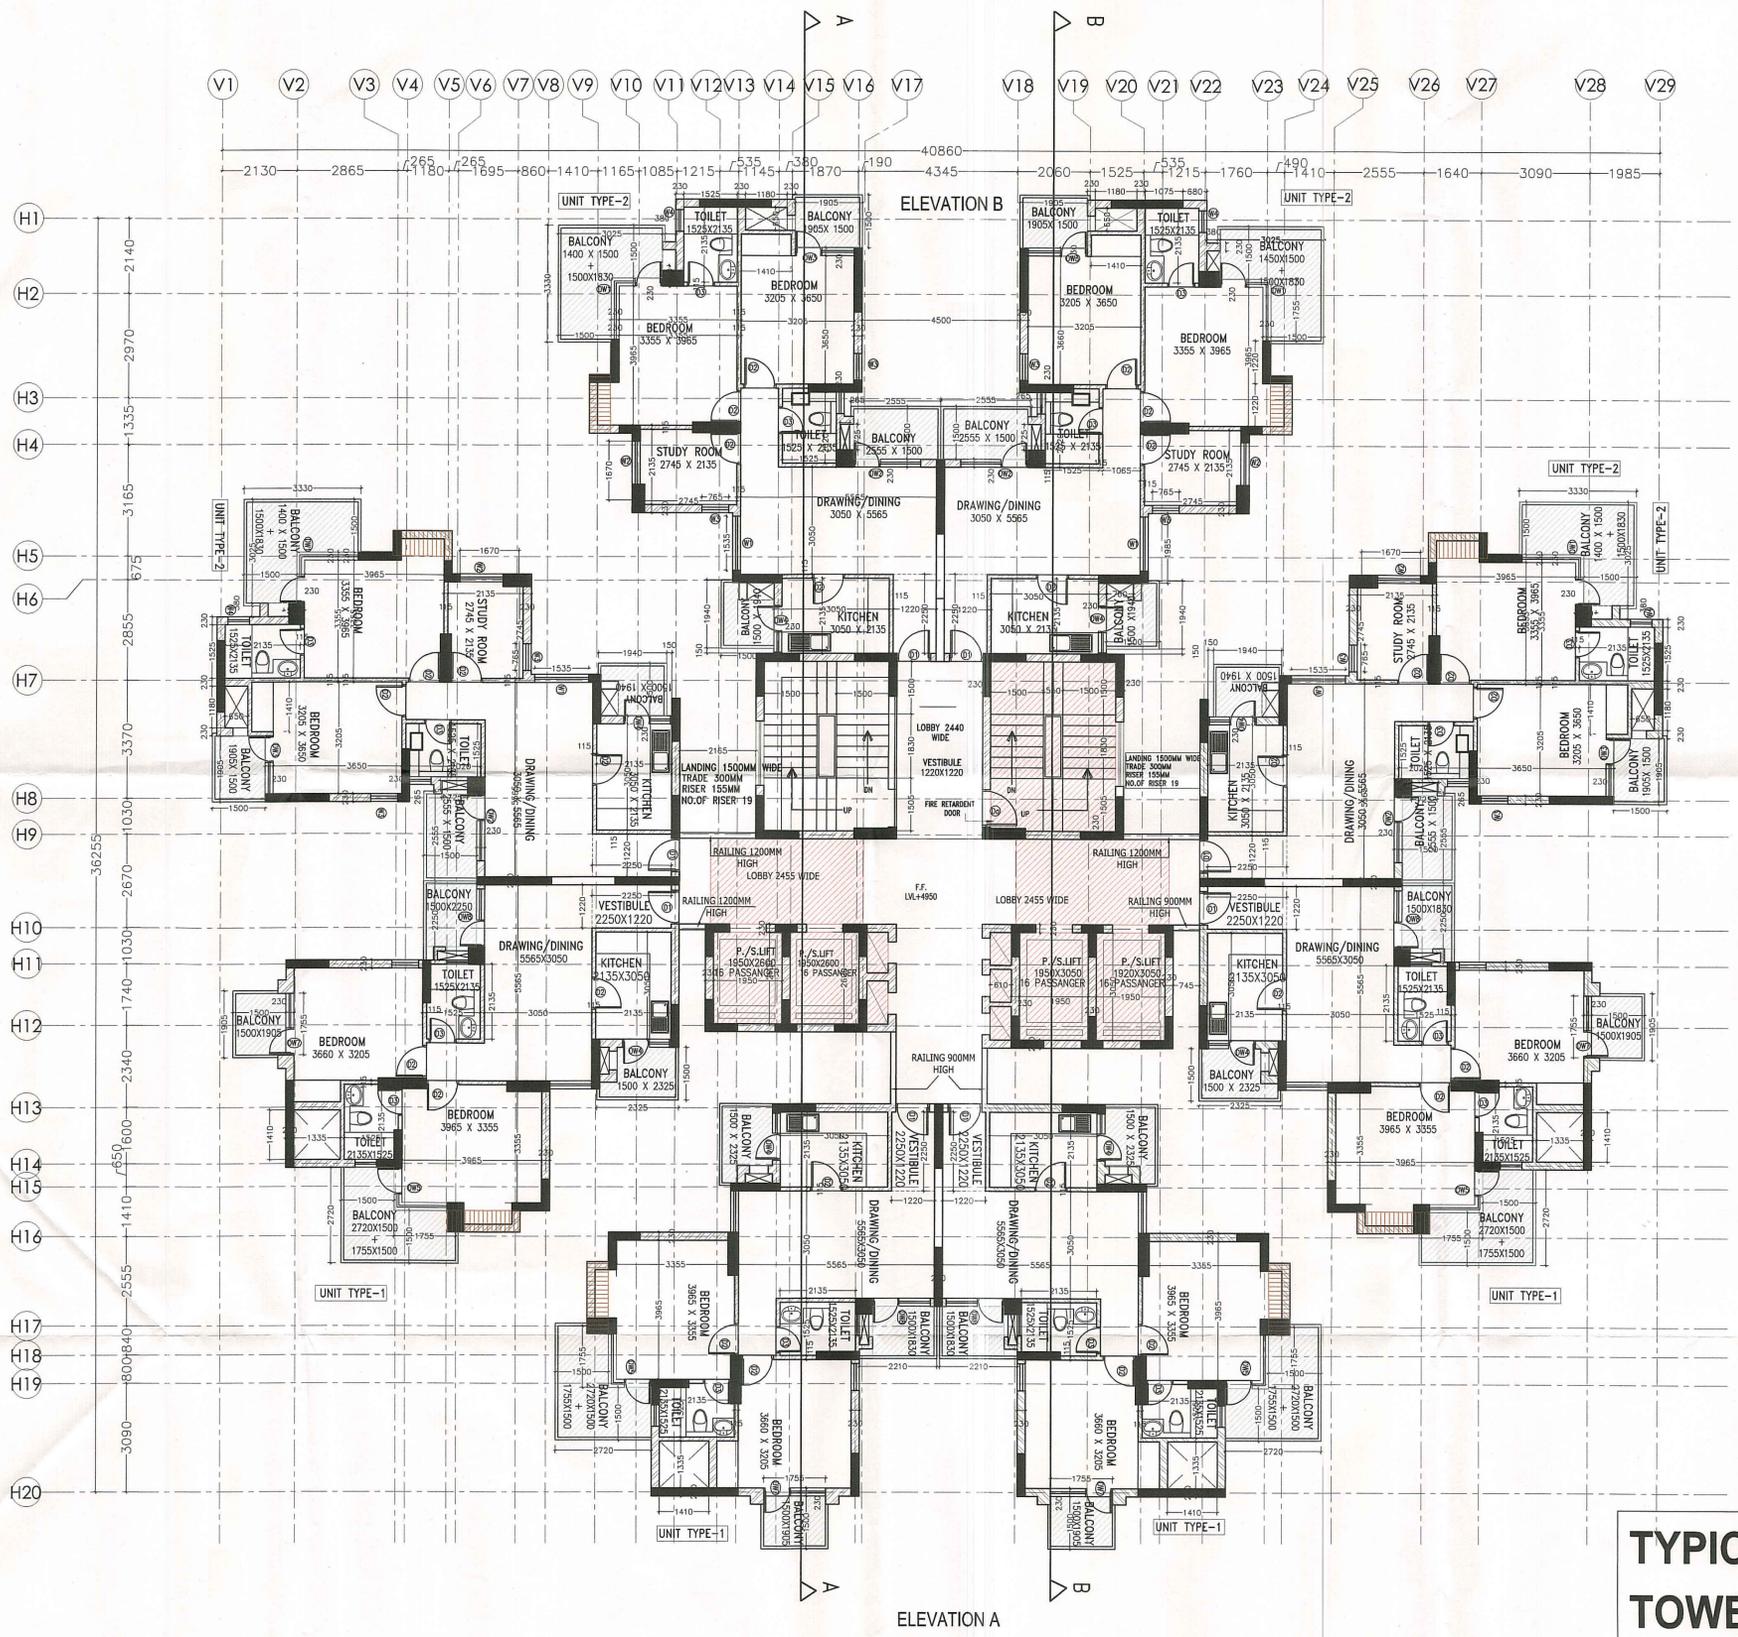

NOTE:-
THIS DRAWING ALREADY APPROVED ON FEBRUARY 5, 2014 AS PER F.A.R 2.75 .
PREVIOUS DRAWING NO.- DWG-08
NEW DRAWING NO.- DWG-14

**TYPICAL FLOOR
TOWER AH (1st-29TH)
TOWER CD (1st-25TH)
TOWER M (1st-25TH)**

SCHEDULE OF OPENINGS

TOWER A & H	Size	Depth Sill	Lintel
DA	1200 x 2450	+0.00	+2.45
D1	1000 x 2450	+0.00	+2.45
D2	900 x 2100	+0.00	+2.10
D3	750 x 2100	+0.00	+2.10
DW1	1755/1450 x 2400	+0.10	+2.40
DW2	1905 x 2400	+0.10	+2.40
DW3	1680 x 2400	+0.10	+2.40
DW4	1330 x 2400	+0.10	+2.40
DW5	1525/1220 x 2400	+0.10	+2.40
DW6	1755/1220 x 2400	+0.10	+2.40
DW7	1755 x 2400	+0.10	+2.40
DW8	11640 x 2400	+0.10	+2.40
W1	1450 x 1450	+0.95	+2.40
W2	1220 x 1450	+0.95	+2.40
W3	765 x 1450	+0.95	+2.40
W4	610 x 900	+1.50	+2.40

ARCHITECT
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SUBMISSION DRAWING


NOTES

- BUILDING IS DESIGNED (STRUCTURES) AS PER RELEVANT IS CODES FOR EARTH QUAKE RESISTANCE.
- MECHANICAL VENTILATION SYSTEM PROVIDED AS PER NBC.

OWNER'S SIGNATURE: For Rajesh Projects (India) Pvt. Ltd.
ARCHITECT'S SIGNATURE: [Signature]


CLIENT: RAJESH PROJECT INDIA PVT. LTD.
PROJECT: PROPOSED GROUP HOUSING AT PLOT NO. GH 07A SECTOR 16B, GREATER NOIDA WEST, GAUTAMBUDH NAGAR, UP - 201308

DRAWING TITLE: TYPICAL FLOORS TOWER-A, C, D, H & M
SCALE: 1:100
DATE: _____
DWG. NO. DWG-14

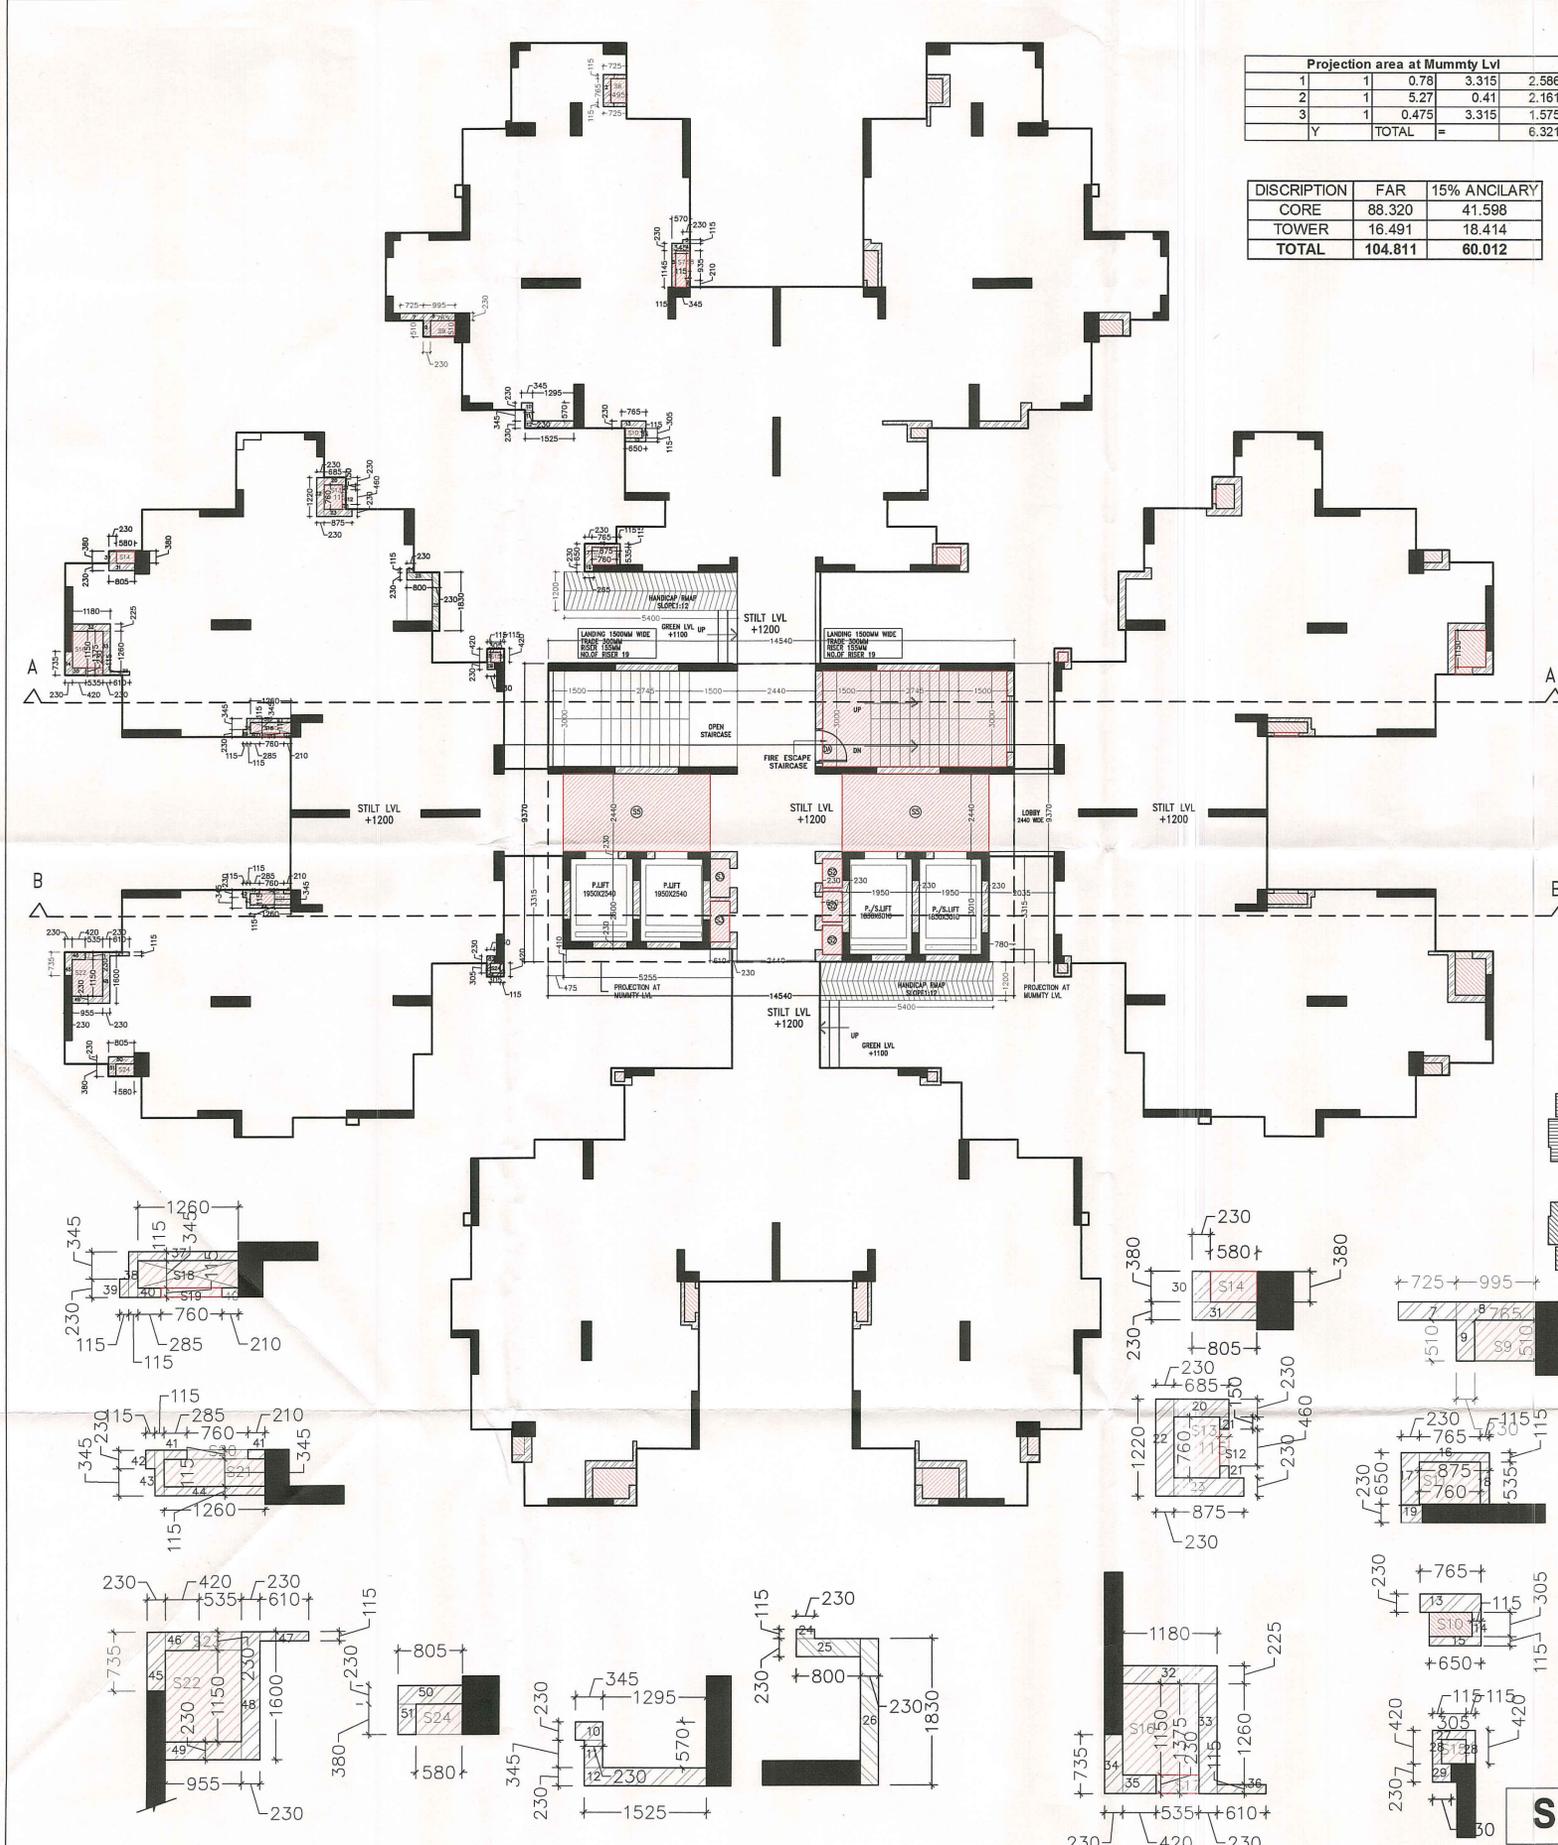


Projection area at Mummy Lvl				
1	1	0.78	3.315	2.586
2	1	5.27	0.41	2.161
3	1	0.475	3.315	1.575
Y	TOTAL	=		6.321

DISCRIPTION	FAR	15% ANCILARY
CORE	88.320	41.598
TOWER	16.491	18.414
TOTAL	104.811	60.012

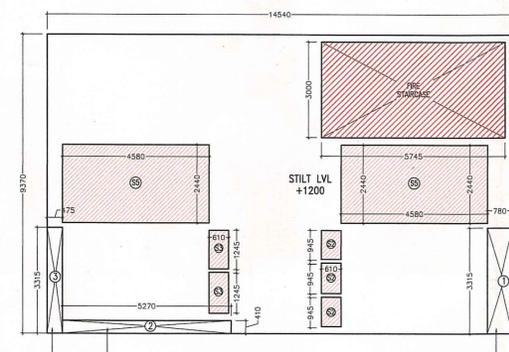

AREA DETAIL AT STILT FLOOR

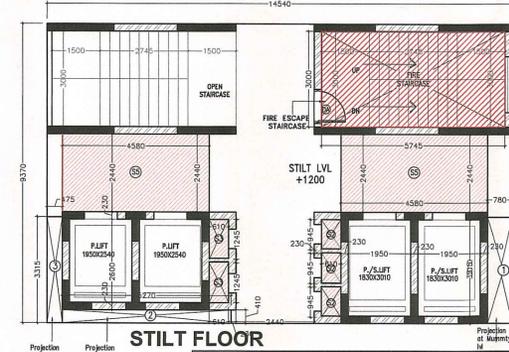

STILT FLOOR

TOWER SHAFT BRICK WALL - FAR

Shape	Factor	Length	Width	Area
1	4	0.725	0.115	0.3335
2	2	0.765	0.23	0.3519
3	2	0.23	0.115	0.0529
4	2	0.57	0.23	0.2622
5	2	1.145	0.115	0.26335
6	2	0.115	0.21	0.0483
7	2	0.725	0.23	0.3335
8	2	0.995	0.23	0.4577
9	2	0.51	0.23	0.2346
10	2	0.23	0.345	0.1587
11	2	0.23	0.345	0.1587
12	2	0.23	1.525	0.7015
13	2	0.765	0.23	0.3519
14	2	0.115	0.305	0.07015
15	2	0.65	0.115	0.1495
16	2	0.765	0.115	0.17595
17	2	0.65	0.23	0.299
18	2	0.535	0.115	0.12305
19	2	0.265	0.23	0.1219
20	2	0.685	0.23	0.3151
21	4	0.15	0.115	0.069
22	2	1.22	0.23	0.5612
23	2	0.875	0.23	0.4025
24	2	0.23	0.115	0.0529
25	2	0.8	0.23	0.368
26	2	1.83	0.23	0.8418
27	2	0.305	0.115	0.07015
28	2	0.42	0.115	0.0966
29	2	0.23	0.23	0.1058
30	2	0.38	0.23	0.1748
31	2	0.805	0.23	0.3703
32	2	1.18	0.23	0.5428
33	2	1.375	0.23	0.6325
34	2	0.735	0.23	0.3381
35	2	0.42	0.23	0.1932
36	2	0.61	0.115	0.1403
37	2	1.26	0.115	0.2898
38	2	0.345	0.115	0.07935
39	2	0.23	0.23	0.1058
40	4	0.21	0.115	0.0966
41	8	0.285	0.115	0.2622
42	4	0.23	0.115	0.1058
43	4	0.115	0.575	0.2645
44	4	1.26	0.115	0.5796
45	4	0.735	0.23	0.6762
46	4	0.42	0.23	0.3864
47	4	0.61	0.115	0.2806
48	4	1.6	0.23	1.472
49	4	0.955	0.23	0.8786
50	4	0.805	0.23	0.7406
51	4	0.38	0.23	0.3496
TOTAL				16.491

STILT FLOOR

EP-253/1/4/14/14/2014

CORE AREA AT STILT FLOOR UNDER FAR				
Shape	Factor	Length	Width	Area
Addition				(all figures in Meter)
X	1	14.540	9.370	136.240
X TOTAL				= 136.240

Area of core - Subtraction				
Subtraction				(all figures in Meter)
1	1	0.780	3.315	2.586
2	1	5.270	0.410	2.161
3	1	0.475	3.315	1.575
F. STAIR	1	5.745	3.000	17.235
S2	3	0.610	0.930	1.702
S3	2	0.610	1.215	1.482
S5	2	4.340	2.440	21.179
Y TOTAL				= 47.919
CORE AREA AT STILT Z(X-Y)				= 88.320

15% Ancillary Area of STILT CORE				
Shape	Factor	Length	Width	Area
F. STAIR	1	5.745	3.000	17.235
S2	3	0.610	0.930	1.702
S3	2	0.610	1.215	1.482
S5	2	4.340	2.440	21.179
TOTAL				41.598

Tower shaft - 15% Ancillary Area

Subtraction (all figures in Meter)				
Shape	Factor	Length	Width	Area
S6	2	0.765	0.495	0.757
S7	2	0.345	1.145	0.790
S8	2	0.935	0.115	0.780
S9	2	0.765	0.510	0.397
S10	2	0.650	0.305	0.813
S11	2	0.760	0.535	0.813
S12	2	0.460	0.115	0.106
S13	2	0.760	0.570	0.866
S14	2	0.580	0.380	0.441
S15	2	0.305	0.305	0.186
S16	2	1.150	0.950	2.185
S17	2	0.535	0.230	0.246
S18	2	1.260	0.345	0.869
S19	2	0.760	0.115	0.175
S20	4	0.760	0.115	0.350
S21	4	0.345	1.260	1.739
S22	4	1.150	0.955	4.393
S23	4	0.305	0.305	0.372
S24	4	0.580	0.380	0.882
S23	4	0.305	0.305	0.372
S24	4	0.580	0.380	0.882
TOTAL				18.414

SCHEDULE OF OPENINGS

TOWER B & E	Size	Sill	Lintel
DA	1200 x 2450	+0.00	+2.45

SUBMISSION DRAWING

- NOTES
- BUILDING IS DESIGNED (STRUCTURES) AS PER RELEVANT IS CODES FOR EARTH QUAKE RESISTANCE.
 - MECHANICAL VENTILATION SYSTEM PROVIDED AS PER NBC.

PRINCIPLE ARCHITECT

dff
DESIGN FORUM INTERNATIONAL
K-47, KAILASH COLONY NEW DELHI-48
PHONE: 011-46556600 FAX: 46556601

OWNER'S SIGNATURE
For Rajesh Projects (India) Pvt. Ltd.

ARCHITECT'S SIGNATURE
B.K. AGARWAL
Director - Operation


PROJECT:
RAJESH PROJECTS INDIA PVT LTD

PROJECT:
PROPOSED GROUP HOUSING
AT PLOT NO. GH 07A SECTOR 16B,
GREATER NOIDA WEST, GAUTAMBUDH
NAGAR, UP - 201308

DRAWING TITLE:
STILT FLOOR PLANS
TOWER B & E

SCALE: 1:100 DWG. NO.
DATE: DWG-24

NOTE: -
THIS DRAWING ALREADY APPROVED
ON FEBRUARY 5, 2014 AS PER
F.A.R. 2.75
PREVIOUS DRAWING NO. - DWG-18
NEW DRAWING NO. - DWG-24

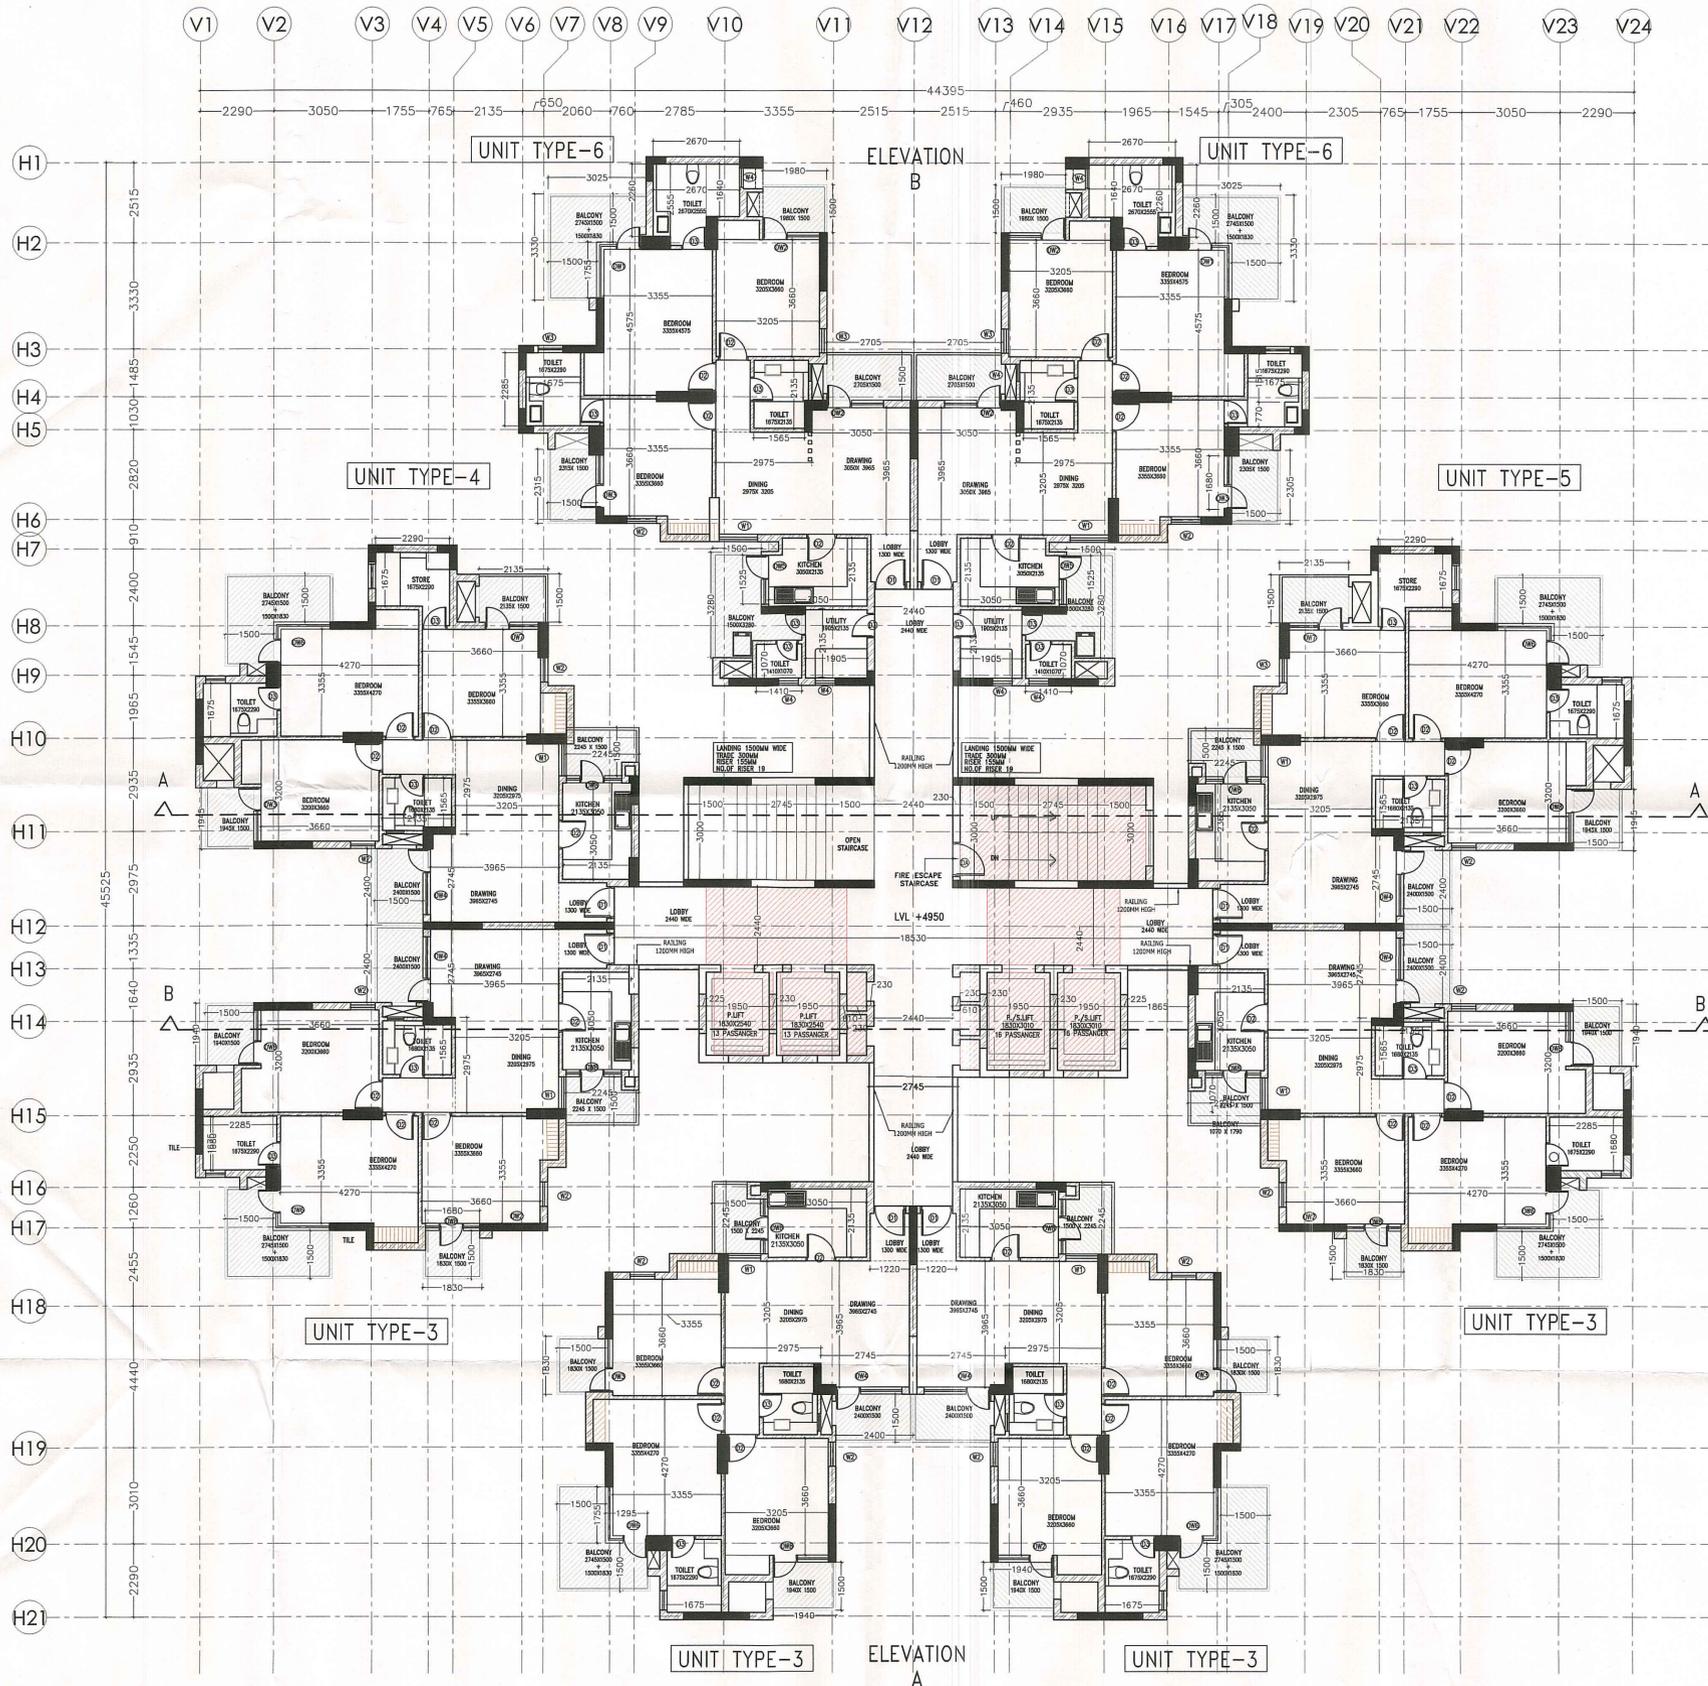

TYPICAL FLOOR (1ST-25RD)

NOTE:-
THIS DRAWING ALREADY APPROVED
ON FEBRUARY 5, 2014 AS PER
F.A.R. 2.75
PREVIOUS DRAWING NO.- DWG-19
NEW DRAWING NO.- DWG-25

SCHEDULE OF OPENINGS

TOWER B & E	Size of Sill	Lintel
DA	1200 x 2450	+0.00 to +2.45
D1	1000 x 2450	+0.00 to +2.45
D2	900 x 2100	+0.00 to +2.10
D3	750 x 2100	+0.00 to +2.10
DW1	1525/1375 x 2400	+0.10 to +2.40
DW2	1755 x 2400	+0.10 to +2.40
DW3	1680 x 2400	+0.10 to +2.40
DW4	2060 x 2400	+0.10 to +2.40
DW5	1525 x 2400	+0.10 to +2.40
DW6	1755/11295 x 2400	+0.10 to +2.40
DW7	1640 x 2400	+0.10 to +2.40
DW8	1715 x 2400	+0.10 to +2.40
W1	1180 x 1450	+0.95 to +2.40
W2	915 x 1450	+0.95 to +2.40
W3	765 x 1450	+0.95 to +2.40
W4	765 x 900	+1.50 to +2.40
W5	610 x 900	+1.50 to +2.40

SUBMISSION DRAWING

- NOTES**
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 - MECHANICAL VENTILATION SYSTEM PROVIDED AS PER NBC.

PRINCIPLE ARCHITECT
dfi
 DESIGN FORUM INTERNATIONAL
 K-47, KAILASH COLONY NEW DELHI-48
 PHONE: 011-46558600 FAX: 46558601

OWNER'S SIGNATURE: [Signature]
 ARCHITECT'S SIGNATURE: [Signature]
 Director - Operations

PROJECT:
RAJESH PROJECTS INDIA PVT LTD

PROPOSED GROUP HOUSING
 AT PLOT NO. GH 07A SECTOR 16B,
 GREATER NOIDA WEST, GAUTAMBUDH
 NAGAR, UP - 201308

DRAWING TITLE:
**TYPICAL FLOOR PLANS
 TOWER B & E**

SCALE: 1:100
 DATE: _____
 DWG. NO.
DWG - 25