



BP-253/4/175-672/12/14  
 5.4.2014

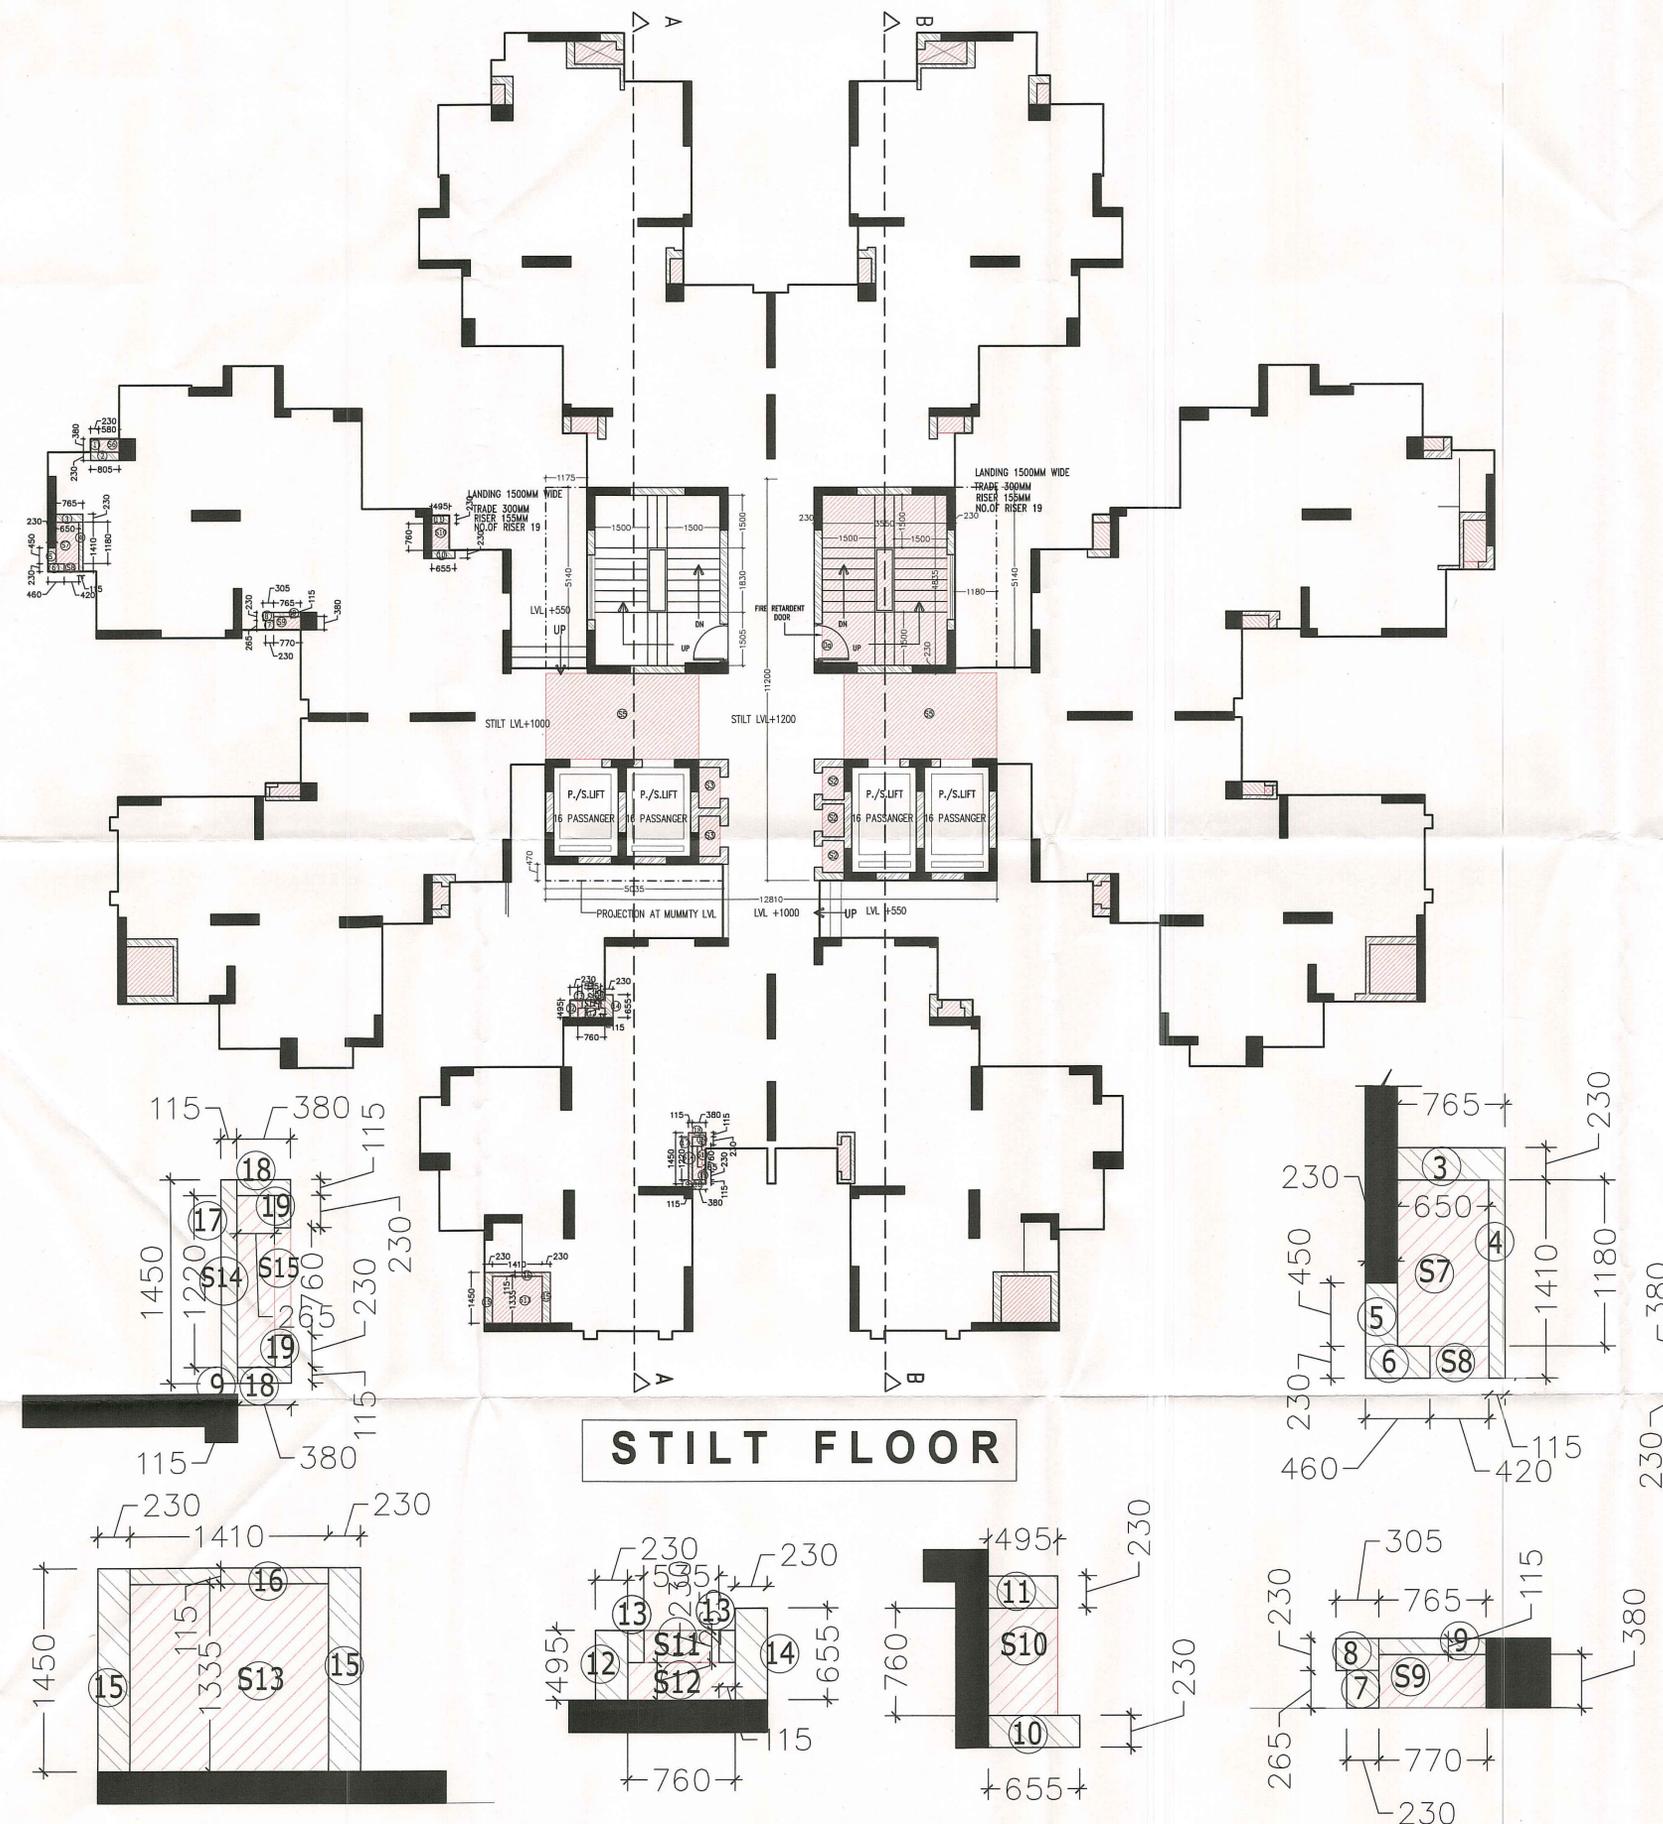


**STILT FLOOR**

FAR CORE AREA AT STILT FLOOR				
CORE AREA				
Shape	Factor	Length	Width	Area
<b>Addition</b> (all figures in Meter)				
X	1	12.810	11.200	143.472
<b>X TOTAL</b>				<b>= 143.472</b>
<b>Subtraction</b> (all figures in Meter)				
1	2	1.180	5.140	12.130
2	1	5.035	0.470	2.366
3	1	0.450	1.730	0.779
F.STAIR	1	3.545	4.830	17.122
S2	3	0.610	0.930	1.702
S3	2	0.610	1.182	1.442
S5	2	4.340	2.440	21.179
<b>TOTAL</b>				<b>56.721</b>
<b>CORE FAR AREA LISFT /STAIR A= (X-Y)</b>				<b>86.751</b>
<b>CORE-15% ANCILLARY AREA</b>				
F.STAIR	1	3.545	4.830	17.122
S2	3	0.610	0.930	1.702
S3	2	0.610	1.182	1.442
S5	2	4.340	2.440	21.179
<b>TOTAL</b>				<b>41.445</b>

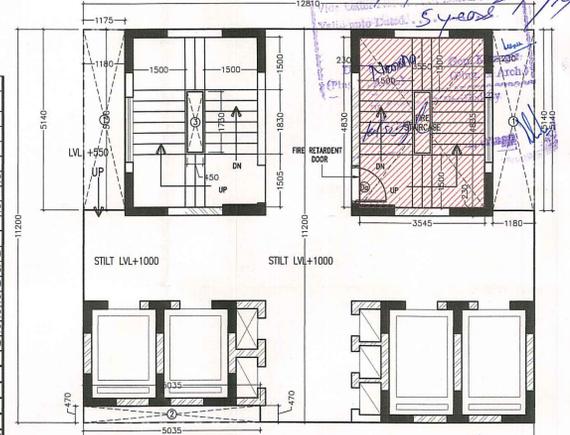

**CORE AT STILT**

STILT TOWER -15% ANCILLARY AREA				
S6	4	0.610	0.580	1.415
S7	4	0.650	1.180	3.068
S8	4	0.420	0.230	0.386
S9	4	0.770	0.380	1.170
S10	4	0.780	0.465	1.505
S11	4	0.535	0.230	0.492
S12	4	0.760	0.265	0.806
S13	4	1.410	1.335	7.529
S14	4	1.220	0.265	1.293
S15	4	0.760	0.115	0.350
<b>TOTAL</b>				<b>18.015</b>
<b>STILT TOWER FAR AREA OF SHAFT WALL</b>				
1	4	0.230	0.380	0.350
2	4	0.800	0.230	0.736
3	4	0.765	0.230	0.704
4	4	0.115	1.410	0.649
5	4	0.450	0.230	0.414
6	4	0.230	0.460	0.423
7	4	0.230	0.265	0.244
8	4	0.305	0.230	0.281
9	4	0.765	0.115	0.352
10	4	0.655	0.230	0.603
11	4	0.495	0.230	0.455
12	4	0.495	0.230	0.455
13	8	0.230	0.115	0.212
14	4	0.655	0.230	0.603
15	8	1.450	0.230	2.668
16	4	1.410	0.115	0.649
17	4	1.450	0.115	0.667
18	8	0.380	0.115	0.350
19	8	0.230	0.115	0.212
<b>TOTAL</b>				<b>11.024</b>
<b>Projection area at Mumty lvi</b>				
1	2	1.180	5.140	12.130
2	1	5.035	0.470	2.366
<b>total</b>				<b>14.497</b>

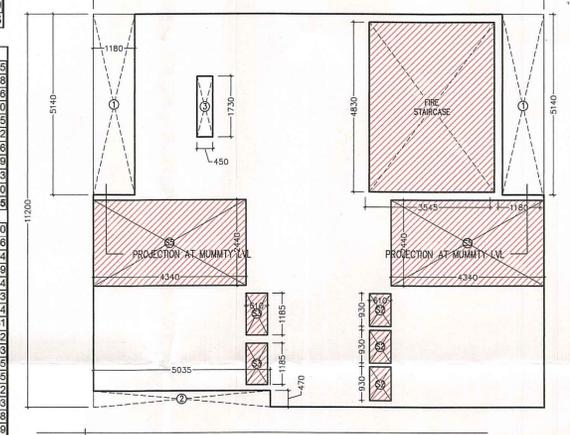

**AREA DETAIL CORE AREA AT STILT**

STILT AREA			
DISCRPTION	FAR	15% ANCILLARY	
CORE	86.751	41.445	
TOWER	11.024	18.015	
<b>TOTAL</b>	<b>97.775</b>	<b>59.460</b>	

NOTE:-  
 THIS DRAWING ALREADY APPROVED ON FEBRUARY 5,2014 AS PER F.A.R 2.75 .  
 PREVIOUS DRAWING NO.- DWG-07  
 NEW DRAWING NO.- DWG-13

**SCHEDULE OF OPENINGS**

TOWER A & H	Size	Sill	Lintel
	1200 x 2450	+0.00	+2.45

**SUBMISSION DRAWING**

**NOTES**

- BUILDING IS DESIGNED (STRUCTURES) AS PER RELEVANT IS CODES FOR EARTH QUAKE RESISTANCE.
- MECHANICAL VENTILATION SYSTEM PROVIDED AS PER NBC.


ARCHITECT  
 K-47, KAILASH COLONY NEW DELHI-48  
 PHONE: 011-46556000 FAX: 46556011


OWNER'S SIGNATURE  
 For Rajesh Projects (India) Pvt. Ltd.  
  
 B.K. GARWAL  
 Director - Operations

ARCHITECT'S SIGNATURE  
  
 Vishish Jaiswal  
 Architect  
 Registration No. CA/200301886

CLIENT  
 RAJESH PROJECT INDIA PVT LTD.  
 PROJECT:  
 PROPOSED GROUP HOUSING  
 AT PLOT NO. GH 07A SECTOR 16B, GREATER NOIDA  
 WEST, GAUTAMBUDH NAGAR, UP - 201308

DRAWING TITLE:  
**STILT PLAN TOWER- C, D & H**  
 SCALE : 1 :100 DWG. NO.  
 DATE : DWG -13

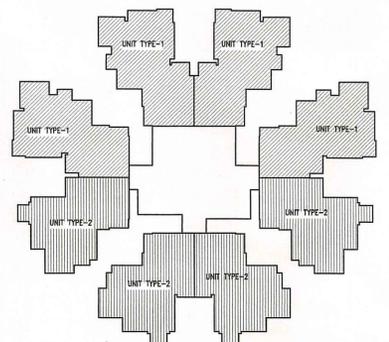

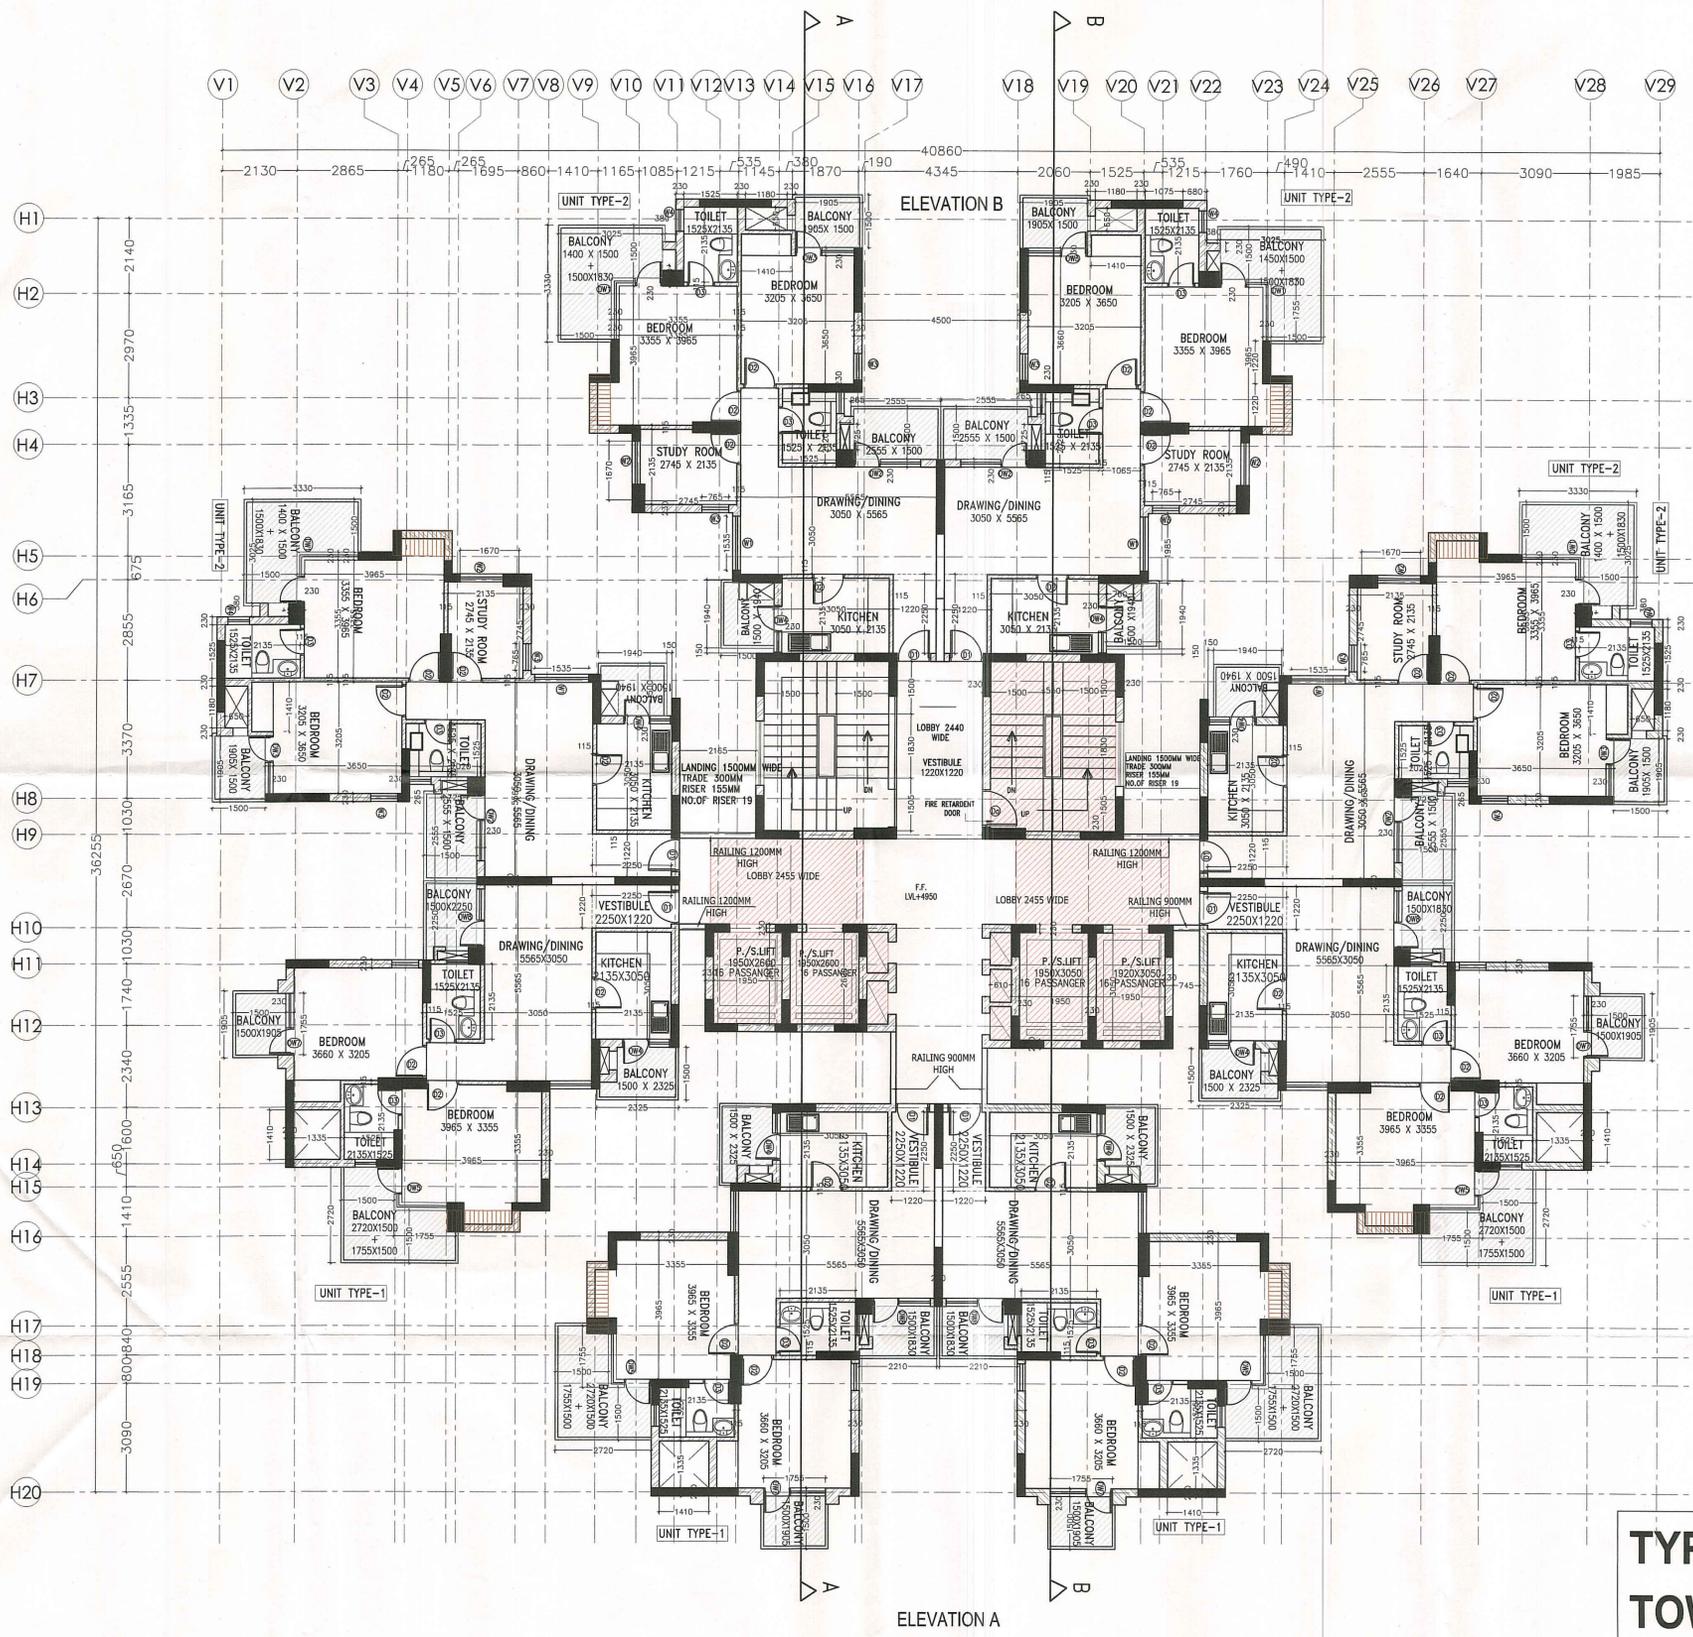

NOTE:-  
THIS DRAWING ALREADY APPROVED ON FEBRUARY 5, 2014 AS PER F.A.R 2.75 .  
PREVIOUS DRAWING NO.- DWG-08  
NEW DRAWING NO.- DWG-14

**TYPICAL FLOOR  
TOWER AH (1st-29TH)  
TOWER CD (1st-25TH)  
TOWER M (1st-25TH)**

**SCHEDULE OF OPENINGS**

TOWER A & H	Size	Depth Sill	Lintel
DA	1200 x 2450	+0.00	+2.45
D1	1000 x 2450	+0.00	+2.45
D2	900 x 2100	+0.00	+2.10
D3	750 x 2100	+0.00	+2.10
DW1	1755/1450 x 2400	+0.10	+2.40
DW2	1905 x 2400	+0.10	+2.40
DW3	1680 x 2400	+0.10	+2.40
DW4	1330 x 2400	+0.10	+2.40
DW5	1525/1220 x 2400	+0.10	+2.40
DW6	1755/1220 x 2400	+0.10	+2.40
DW7	1755 x 2400	+0.10	+2.40
DW8	11640 x 2400	+0.10	+2.40
W1	1450 x 1450	+0.95	+2.40
W2	1220 x 1450	+0.95	+2.40
W3	765 x 1450	+0.95	+2.40
W4	610 x 900	+1.50	+2.40

ARCHITECT  
K-47, KAILASH COLONY NEW DELHI-48  
PHONE: 011-46556000 FAX: 46556001




**SUBMISSION DRAWING**

**NOTES**  
1. BUILDING IS DESIGNED (STRUCTURES) AS PER RELEVANT IS CODES FOR EARTH QUAKE RESISTANCE.  
2. MECHANICAL VENTILATION SYSTEM PROVIDED AS PER NBC.

OWNER'S SIGNATURE: For Rajesh Projects (India) Pvt. Ltd.  
ARCHITECT'S SIGNATURE: [Signature]

CLIENT: RAJESH PROJECT INDIA PVT. LTD.  
PROJECT: PROPOSED GROUP HOUSING AT PLOT NO. GH 07A SECTOR 16B, GREATER NOIDA WEST, GAUTAMBUDH NAGAR, UP - 201308

DRAWING TITLE: TYPICAL FLOORS TOWER-A, C, D, H & M  
SCALE: 1:100  
DATE: \_\_\_\_\_  
DWG. NO. DWG-14

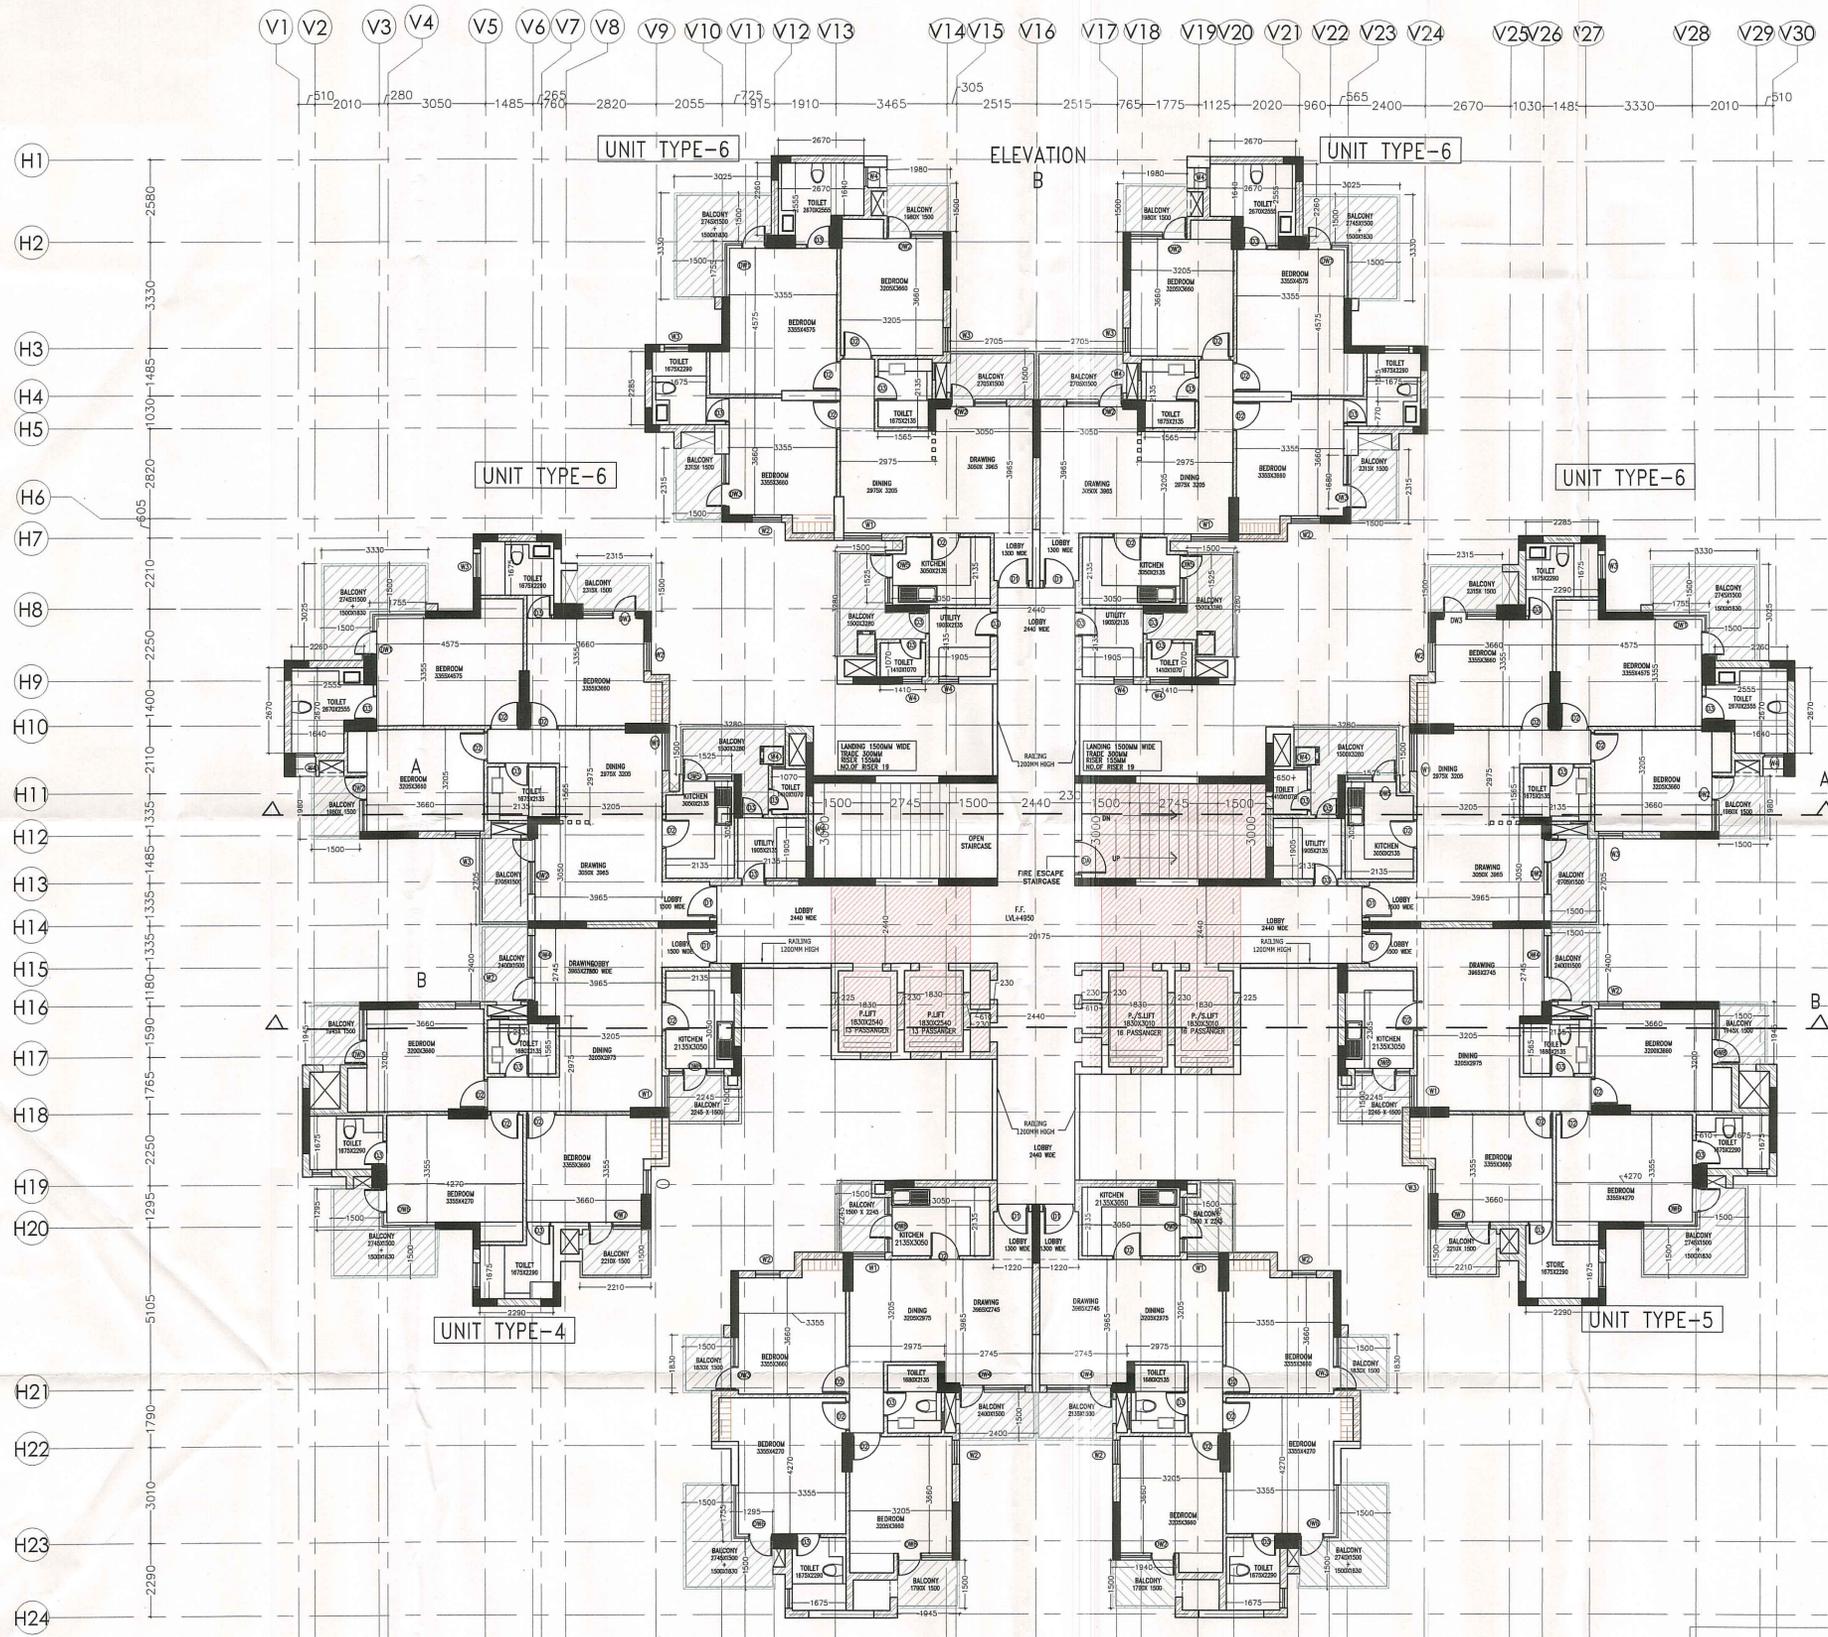

**SCHEDULE OF OPENINGS**

TOWER	Size	Sill	Lintel
DA	1200 x 2450	+0.00	+2.45
D1	1000 x 2450	+0.00	+2.45
D2	900 x 2100	+0.00	+2.10
D3	750 x 2100	+0.00	+2.10
DW1	1755/1450 x 2400	+0.10	+2.40
DW2	1905 x 2400	+0.10	+2.40
DW3	1680 x 2400	+0.10	+2.40
DW4	1330 x 2400	+0.10	+2.40
DW5	1525/1220 x 2400	+0.10	+2.40
DW6	1755/1220 x 2400	+0.10	+2.40
DW7	1755 x 2400	+0.10	+2.40
DW8	11640 x 2400	+0.10	+2.40
W1	1450 x 1450	+0.95	+2.40
W2	1220 x 1450	+0.95	+2.40
W3	765 x 1450	+0.95	+2.40
W4	610 x 900	+1.50	+2.40

**SUBMISSION DRAWING**

- NOTES**
- BUILDING IS DESIGNED (STRUCTURES) AS PER RELEVANT IS CODES FOR EARTH QUAKE RESISTANCE.
  - MECHANICAL VENTILATION SYSTEM PROVIDED AS PER NBC.

PRINCIPLE ARCHITECT  
**dfi**  
 DESIGN FORUM INTERNATIONAL  
 K-47, KAILASH COLONY NEW DELHI-48  
 PHONE: 011-46556600 FAX: 46556601

OWNER'S SIGNATURE  
 For Rajesh Projects (India) Pvt. Ltd.  
 B.R. AGARWAL  
 Director - Operations

ARCHITECT'S SIGNATURE  
 [Signature]  
 Project No. [Number]

PROJECT:  
**RAJESH PROJECTS INDIA PVT LTD**

PROPOSED GROUP HOUSING  
 AT PLOT NO. GH 07A SECTOR 16B,  
 GREATER NOIDA WEST, GAUTAMBUDH  
 NAGAR, UP - 201308

DRAWING TITLE:  
**TYPICAL FLOOR PLANS  
 TOWER F & G**

SCALE: 1:100  
 DATE: \_\_\_\_\_

DWG. NO.  
**DWG-32**

NOTE:-  
 THIS DRAWING ALREADY APPROVED  
 ON FEBRUARY 5, 2014 AS PER  
 F.A.R- 2.75 .  
 PREVIOUS DRAWING NO.- DWG-26  
 NEW DRAWING NO.- DWG-32

**TYPICAL FLOOR  
 TOWER F (1ST-25TH)  
 TOWER G (1ST-29 TH)**