




TOWER-A  
GROUND FLOOR PLAN

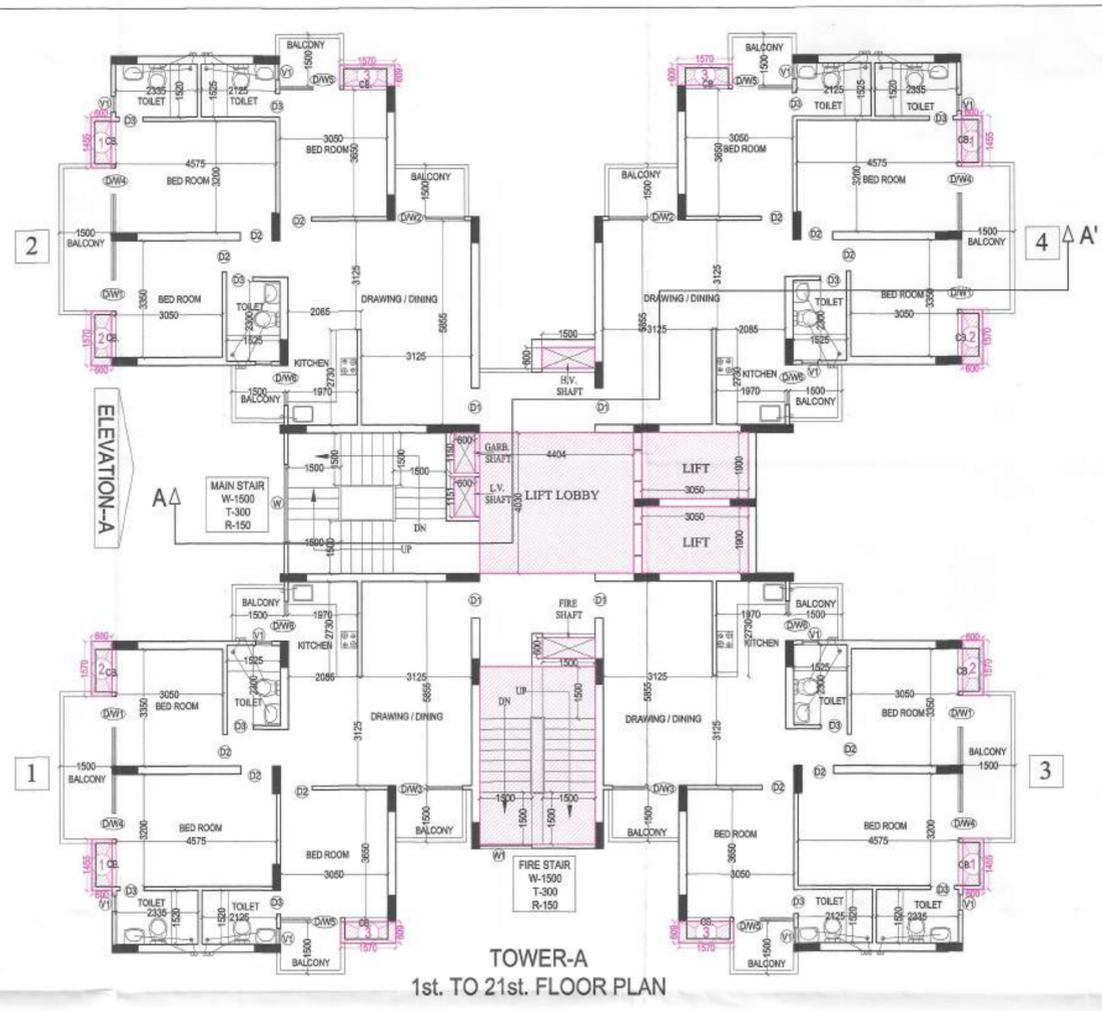

TOWER-A  
1st. TO 21st. FLOOR PLAN

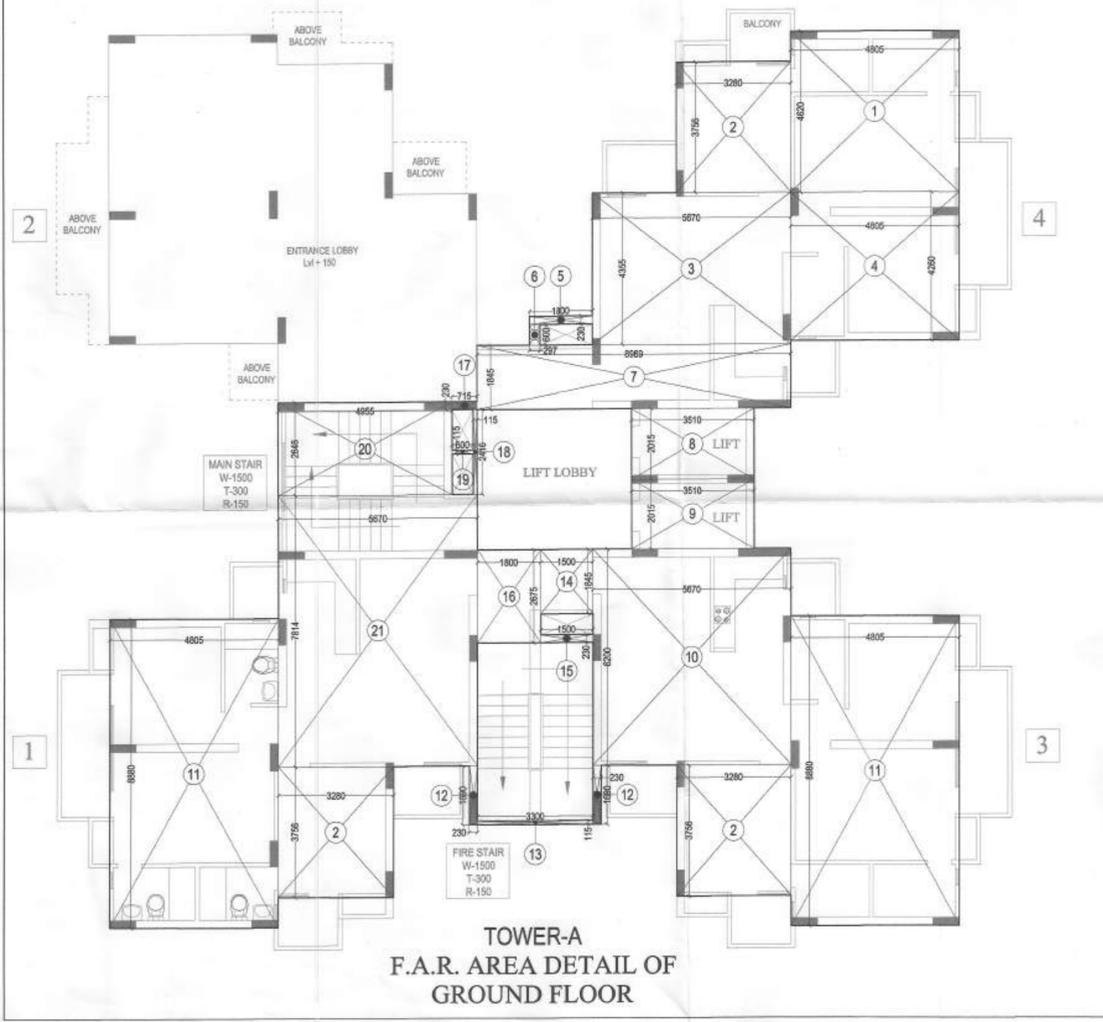

TOWER-A  
F.A.R. AREA DETAIL OF  
GROUND FLOOR

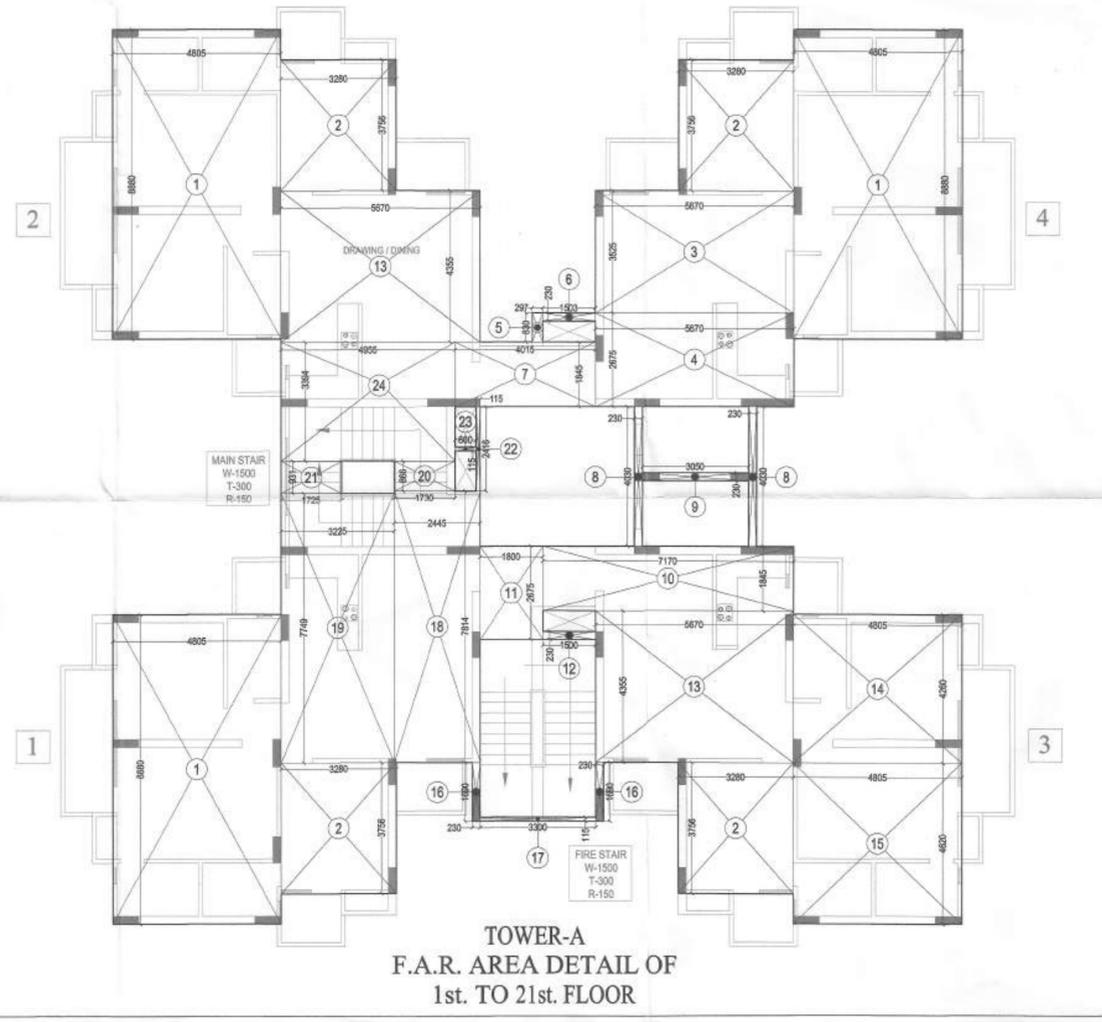

TOWER-A  
F.A.R. AREA DETAIL OF  
1st. TO 21st. FLOOR

**F.A.R. AREA DETAIL OF GROUND FLOOR**

1.	4.805 X 4.620	=	22.199	SQ.M
2.	3.280 X 3.756	=	12.319	SQ.M
3.	5.670 X 4.355	=	24.693	SQ.M
4.	4.805 X 4.260	=	20.469	SQ.M
5.	1.800 X 0.230	=	0.414	SQ.M
6.	0.297 X 0.600	=	0.178	SQ.M
7.	8.969 X 1.845	=	16.548	SQ.M
8.	3.510 X 2.015	=	7.072	SQ.M
9.	3.510 X 2.015	=	7.072	SQ.M
10.	5.670 X 6.200	=	35.154	SQ.M
11.	4.805 X 8.880 X 2 =	=	85.337	SQ.M
12.	0.230 X 1.690 X 2 =	=	0.777	SQ.M
13.	3.300 X 0.115 =	=	0.380	SQ.M
14.	1.500 X 1.845 =	=	2.768	SQ.M
15.	1.500 X 0.230 =	=	0.345	SQ.M
16.	1.800 X 2.675 =	=	4.815	SQ.M
17.	0.715 X 0.230 =	=	0.164	SQ.M
18.	0.115 X 2.416 =	=	0.278	SQ.M
19.	0.600 X 0.115 =	=	0.069	SQ.M
20.	4.955 X 2.646 =	=	13.111	SQ.M
21.	5.670 X 7.814 =	=	44.305	SQ.M
<b>TOTAL =</b>				<b>323.113</b>
<b>SAY AS =</b>				<b>323.11</b>

**F.A.R. AREA DETAIL OF 1st. TO 21st. FLOOR**

1.	4.805 X 8.880 X 3 =	=	128.005	SQ.M
2.	3.280 X 3.756 X 4 =	=	49.279	SQ.M
3.	5.670 X 3.525 =	=	19.987	SQ.M
4.	5.670 X 2.675 =	=	15.167	SQ.M
5.	0.297 X 0.830 =	=	0.247	SQ.M
6.	1.503 X 0.230 =	=	0.346	SQ.M
7.	4.015 X 1.845 =	=	7.408	SQ.M
8.	0.230 X 4.030 X 2 =	=	1.854	SQ.M
9.	3.050 X 0.230 =	=	0.702	SQ.M
10.	7.170 X 1.845 =	=	13.229	SQ.M
11.	1.800 X 2.675 =	=	4.815	SQ.M
12.	1.500 X 0.230 =	=	0.345	SQ.M
13.	5.670 X 4.355 X 2 =	=	49.386	SQ.M
14.	4.805 X 4.260 =	=	20.469	SQ.M
15.	4.805 X 4.620 =	=	22.199	SQ.M
16.	0.230 X 1.690 X 2 =	=	0.777	SQ.M
17.	3.300 X 0.115 =	=	0.380	SQ.M
18.	2.445 X 7.814 =	=	19.105	SQ.M
19.	3.225 X 7.749 =	=	24.991	SQ.M
20.	1.730 X 0.866 =	=	1.498	SQ.M
21.	1.725 X 0.931 =	=	1.606	SQ.M
22.	0.115 X 2.416 =	=	0.278	SQ.M
23.	0.600 X 0.115 =	=	0.069	SQ.M
24.	4.955 X 3.394 =	=	16.817	SQ.M
<b>TOTAL =</b>				<b>398.959</b>
<b>SAY AS =</b>				<b>398.96</b>

**DOOR WINDOW SCHEDULE**

TYPE	SIZE	CILL LVL.	LINTEL LVL.
D1	1050 X 2500	-----	2500
D2	900 X 2100	-----	2100
D3	750 X 2100	-----	2100
DW1	2010 X 2050	450	2500
DW2	1975 X 1350	450	2500
DW3	1895 X 2050	450	2500
DW4	1860 X 2050	450	2500
DW5	1710 X 2050	450	2500
DW6	1710 X 2050	450	2500
W	2235 X 2050	450	2500
W1	1500 X 2050	450	2500
V	450 X 1000	1500	2500

**PROJECT :-**  
PROPOSED GROUP HOUSING  
AT PLOT No. GH-01C, SECTOR-16,  
G. NOIDA.

**BUILDERS & PROMOTER :-**  
M/s COSMOS INFRAESTATE PVT. LTD.  
ADD:- B150, SEC 63, NOIDA.

**DRAWING TITLE :-** TOWER-A  
GROUND TO 21st. FLOOR PLAN  
F.A.R. AREA DETAIL OF  
GROUND TO 21st. FLOOR

**ARCHITECTS :-**  
Space Designers International  
Architects Pvt. Ltd.  
B - 34, SECTOR-67, NOIDA  
PH: 002-2484445-49  
MOB: 981070399, 981036023  
e-mail: spacesd@gmail.com, www.spacedi.com

**Space Designers**  
architects & planners

**ARCHITECT'S SIGN.**

**OWNER'S SIGN**

**DRG. NO. - 08**

**DRAWN BY :-** SANJAY **CHECKED BY :-** WISHAL **SCALE:** 1 : 100 **DATED :-** -----

Greater Noida Industrial Dev. Auth.  
**APPROVED**  
 Plotter No. 8162, Dated: 17/10/2014  
 Valid upto Dated: 5 years  
 Noida  
 DCM  
 (Plan & Arch.)  
 Gen. Man  
 (Eng. & J)  
 Date: 17/10/2014  
 Sign: [Signature]



**TOWER-A**  
**BALCONY NON F.A.R. AREA DETAIL OF**  
**1st. TO 21st. FLOOR**

BALCONY NON F.A.R. AREA DETAIL OF 1st. TO 21st. FLOOR	
01	BALCONY TYPE -A = 2.447 X 4 = 9.788 SQ.MT.
02	BALCONY TYPE -B = 6.357 X 4 = 25.428 SQ.MT.
03	BALCONY TYPE -C = 2.741 X 4 = 10.964 SQ.MT.
04	BALCONY TYPE -D = 3.014 X 2 = 6.028 SQ.MT.
05	BALCONY TYPE -E = 3.134 X 2 = 6.268 SQ.MT.
<b>TOTAL</b>	<b>= 58.476 SQ.MT. SAY AS 58.48 SQ.MT.</b>



**TOWER-A**  
**BALCONY NON F.A.R. AREA DETAIL OF**  
**22nd. FLOOR**

BALCONY NON F.A.R. AREA DETAIL OF 22nd. FLOOR	
01	BALCONY TYPE -A = 2.447 X 2 = 4.894 SQ.MT.
02	BALCONY TYPE -B = 6.357 X 2 = 12.714 SQ.MT.
03	BALCONY TYPE -C = 2.741 X 2 = 5.482 SQ.MT.
04	BALCONY TYPE -D = 3.014 X 1 = 3.014 SQ.MT.
05	BALCONY TYPE -E = 3.134 X 1 = 3.134 SQ.MT.
<b>TOTAL</b>	<b>= 29.238 SQ.MT. SAY AS 29.24 SQ.MT.</b>

**PROJECT :-**  
 PROPOSED GROUP HOUSING  
 AT PLOT No. GH-01C, SECTOR-16,  
 G. NOIDA.

**BUILDERS & PROMOTER :-**  
 M/s COSMOS INFRAESTATE PVT. LTD.  
 ADD:- B150, SEC 63, NOIDA.

**DRAWING TITLE :-** TOWER-A  
 BALCONY NON F.A.R. AREA  
 GROUND TO 1st. TO 22nd. FLOOR

**ARCHITECTS :-**  
 Space Designers International  
 Architects Pvt. Ltd.  
 B - 34, SECTOR-67, NOIDA  
 PH : 020-246445-49  
 FAX: 981070599, 981326251  
 e-mail : spacesdi@gmail.com, www.spacesdi.com

**Space Designers**  
 architects & planners

**DRAWN BY :-** SANJAY **CHECKED BY :-** VISHAL **SCALE** 1 : 100 **DATED :-** -----

**OWNER'S SIGN** **ARCHITECT'S SIGN**

**DRG.NO. - 10**



TOWER-B1  
TOWER-B1 & B2 ARE SAME  
GROUND FLOOR PLAN

DOOR WINDOW SCHEDULE			
TYPE	SIZE	CILL LVL.	LINTEL LVL.
D1	1050 X 2500	-----	2500
D2	900 X 2100	-----	2100
D3	750 X 2100	-----	2100
DW1	1595X 2050	450	2500
DW2	1410X 2050	450	2500
DW3	1385X 2050	450	2500
DW4	1330X 2050	450	2500
DW5	1710X 2050	450	2500
DW6	1650X 2050	450	2500
W1	690X 2050	450	2500
W2	1450X 2050	450	2500
W3	690 X 2050	450	2500
V1	450X1000	1500	2500




TOWER-B1  
TOWER-B1 & B2 ARE SAME  
1st. TO 22nd. FLOOR PLAN

PROJECT :-  
PROPOSED GROUP HOUSING  
AT PLOT No. GH-01C, SECTOR-16,  
G. NOIDA.  
BUILDERS & PROMOTER :-  
M/s COSMOS INFRAESTATE PVT. LTD.  
ADD:- B150, SEC 63, NOIDA.  
DRAWING TITLE :- TOWER-B1  
TOWER-B1 & B2 ARE SAME  
GROUND TO 22nd. FLOOR PLAN


ARCHITECTS :-  
Space Designers International  
Architects Pvt. Ltd.  
B-34, SECTOR-67, NOIDA  
PH: 920-246445-49  
MO: 981070399, 9810336231  
e-mail: spocdi@gmail.com, www.spocdi.com

DRAWN BY :- SANJAY VISHAL  
CHECKED BY :-  
SCALE 1:100  
DATED :-

OWNER'S SIGN  
ARCHITECT'S SIGN  
DRG. NO. - 13

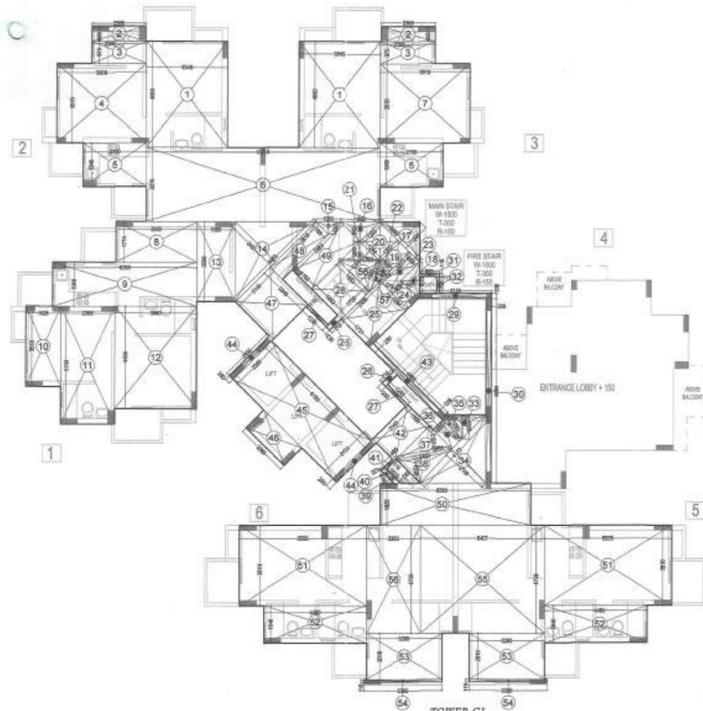

TOWER-C1  
F.A.R. AREA DETAIL OF GROUND FLOOR

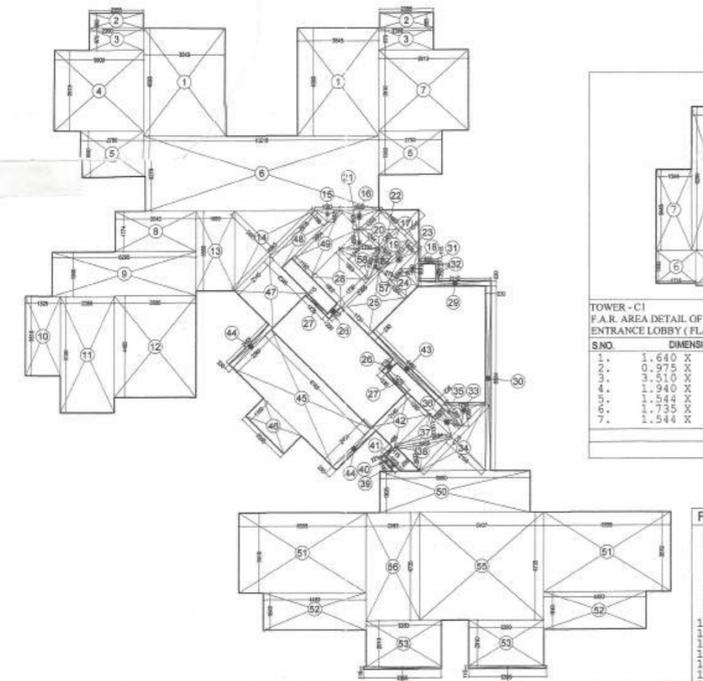


TOWER-C1  
F.A.R. AREA DETAIL OF GROUND FLOOR

TOWER-C1  
F.A.R. AREA DETAIL OF ENTRANCE LOBBY (FLAT NO.-04)


S.NO.	DIMENSION	AREA
1.	1.640 X 2.353	3.859 SQ.M
2.	0.975 X 1.590	1.550 SQ.M
3.	3.510 X 7.460	26.185 SQ.M
4.	1.940 X 6.250	12.125 SQ.M
5.	1.344 X 1.560	2.097 SQ.M
6.	1.735 X 3.445	5.977 SQ.M
7.	1.544 X 3.545	5.473 SQ.M
TOTAL		56.135 SQ.M
SAY AS		56.14 SQ.M

F.A.R. AREA DETAIL OF GROUND FLOOR

S.NO.	DIMENSION	AREA
1.	3.585 X 4.650	16.670 SQ.M
2.	2.355 X 0.665	1.557 SQ.M
3.	2.390 X 0.975	2.330 SQ.M
4.	2.750 X 1.940	5.335 SQ.M
5.	10.210 X 3.270	33.397 SQ.M
6.	3.545 X 1.774	6.289 SQ.M
7.	3.545 X 1.774	6.289 SQ.M
8.	1.525 X 3.510	5.353 SQ.M
9.	2.355 X 5.150	12.128 SQ.M
10.	3.580 X 4.485	16.056 SQ.M
11.	1.685 X 3.509	5.913 SQ.M
12.	0.5 X 4.963	2.481 SQ.M
13.	1.083 X 1.513	1.637 SQ.M
14.	0.5 X 1.577	0.788 SQ.M
15.	0.5 X 1.577	0.788 SQ.M
16.	0.5 X 1.577	0.788 SQ.M
17.	0.5 X 1.577	0.788 SQ.M
18.	0.5 X 1.577	0.788 SQ.M
19.	1.202 X 0.609	0.732 SQ.M
20.	1.202 X 0.609	0.732 SQ.M
21.	0.5 X 1.760	0.880 SQ.M
22.	0.5 X 0.861	0.430 SQ.M
23.	0.5 X 0.861	0.430 SQ.M
24.	0.5 X 0.861	0.430 SQ.M
25.	0.5 X 0.861	0.430 SQ.M
26.	0.5 X 0.861	0.430 SQ.M
27.	0.115 X 1.235	0.142 SQ.M
28.	0.115 X 1.235	0.142 SQ.M
29.	0.115 X 1.235	0.142 SQ.M
30.	0.230 X 0.230	0.053 SQ.M
31.	0.230 X 0.230	0.053 SQ.M
32.	0.115 X 0.750	0.086 SQ.M
33.	0.115 X 0.750	0.086 SQ.M
34.	1.785 X 0.055	0.098 SQ.M
35.	1.785 X 0.055	0.098 SQ.M
36.	0.800 X 1.283	1.026 SQ.M
37.	0.800 X 1.283	1.026 SQ.M
38.	0.5 X 1.151	0.576 SQ.M
39.	0.5 X 1.151	0.576 SQ.M
40.	0.5 X 1.151	0.576 SQ.M
41.	0.5 X 1.151	0.576 SQ.M
42.	0.5 X 1.151	0.576 SQ.M
43.	0.230 X 4.450	1.023 SQ.M
44.	0.230 X 4.450	1.023 SQ.M
45.	1.100 X 2.360	2.596 SQ.M
46.	2.145 X 2.984	6.400 SQ.M
47.	2.145 X 2.984	6.400 SQ.M
48.	1.192 X 2.984	3.557 SQ.M
49.	1.192 X 2.984	3.557 SQ.M
50.	0.5 X 3.510	1.755 SQ.M
51.	0.5 X 3.510	1.755 SQ.M
52.	4.480 X 1.640	7.349 SQ.M
53.	4.480 X 1.640	7.349 SQ.M
54.	3.395 X 4.735	16.077 SQ.M
55.	3.395 X 4.735	16.077 SQ.M
56.	0.5 X 1.385	0.693 SQ.M
57.	0.5 X 1.385	0.693 SQ.M
58.	0.5 X 1.385	0.693 SQ.M
59.	0.5 X 1.385	0.693 SQ.M
60.	0.5 X 1.385	0.693 SQ.M
TOTAL		355.603 SQ.M
SAY AS		355.60 SQ.M

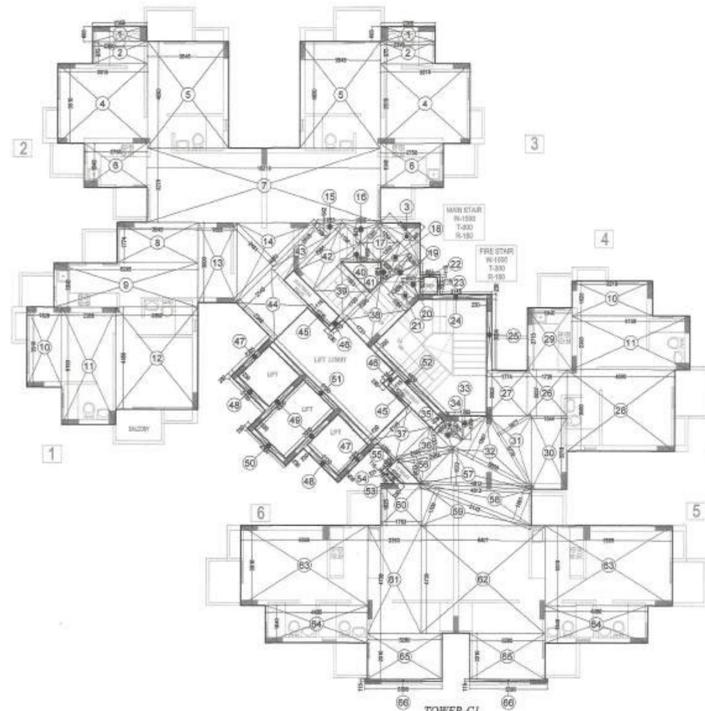

TOWER-C1  
F.A.R. AREA DETAIL OF 1st. TO 22nd. FLOOR

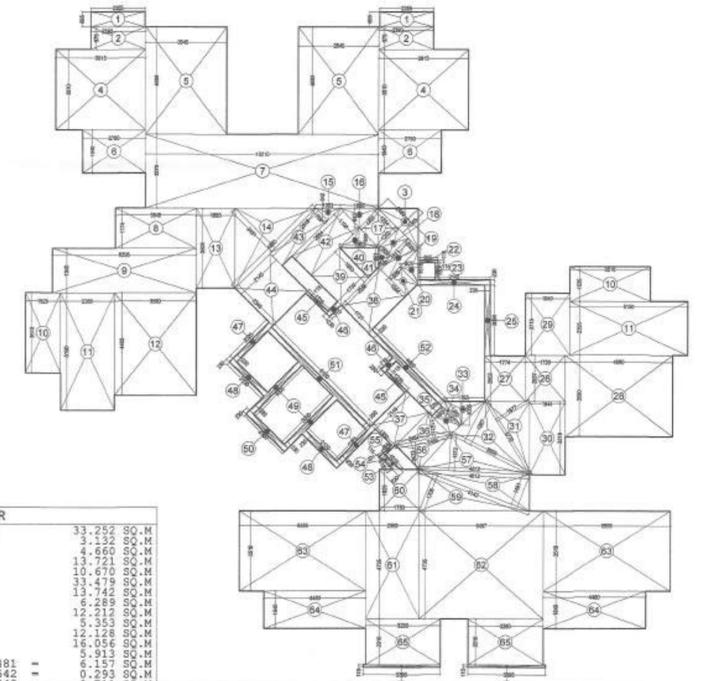

TOWER-C1  
F.A.R. AREA DETAIL OF 1st. TO 22nd. FLOOR

F.A.R. AREA DETAIL OF 1st. TO 22nd. FLOOR

S.NO.	DIMENSION	AREA
1.	0.5 X 5.652	2.826 SQ.M
2.	0.5 X 5.943	2.971 SQ.M
3.	0.5 X 5.943	2.971 SQ.M
TOTAL		22.048 SQ.M
SAY AS		22.05 SQ.M

15% FACILITY AREA DETAIL OF WATER TANK :-

S.NO.	DIMENSION	AREA
1.	0.5 X 5.652	2.826 SQ.M
2.	0.5 X 5.943	2.971 SQ.M
3.	0.5 X 5.943	2.971 SQ.M
TOTAL		22.048 SQ.M
SAY AS		22.05 SQ.M

15% FACILITY AREA DETAIL OF MUMTY :-

S.NO.	DIMENSION	AREA
1.	0.5 X 5.943	2.971 SQ.M
2.	0.5 X 5.943	2.971 SQ.M
3.	0.5 X 5.943	2.971 SQ.M
TOTAL		22.048 SQ.M
SAY AS		22.05 SQ.M

15% FACILITY AREA DETAIL OF MUMTY

S.NO.	DIMENSION	AREA
1.	0.5 X 5.943	2.971 SQ.M
2.	0.5 X 5.943	2.971 SQ.M
3.	0.5 X 5.943	2.971 SQ.M
TOTAL		22.048 SQ.M
SAY AS		22.05 SQ.M

15% FACILITY AREA DETAIL OF LIFT SHAFT AREA :-

S.NO.	DIMENSION	AREA
1.	1.900 X 1.900	3.610 SQ.M
2.	1.900 X 3.000	5.700 SQ.M
TOTAL		12.920 SQ.M
SAY AS		12.92 SQ.M

15% FACILITY AREA DETAIL OF CUPBOARD :-

S.NO.	DIMENSION	AREA
1.	0.600 X 1.570	0.942 SQ.M
2.	0.635 X 1.570	1.000 SQ.M
TOTAL		1.942 SQ.M
SAY AS		1.94 SQ.M

15% FACILITY AREA DETAIL OF CUPBOARD :-

S.NO.	DIMENSION	AREA
1.	0.600 X 1.570	0.942 SQ.M
2.	0.635 X 1.570	1.000 SQ.M
TOTAL		1.942 SQ.M
SAY AS		1.94 SQ.M

15% FACILITY AREA DETAIL OF MACHINE ROOM :-

S.NO.	DIMENSION	AREA
1.	2.130 X 3.560	7.583 SQ.M
2.	4.660 X 2.360	10.998 SQ.M
TOTAL		18.581 SQ.M
SAY AS		18.58 SQ.M

15% FACILITY AREA DETAIL OF FIRE STAIR CASE :-

S.NO.	DIMENSION	AREA
1.	0.5 X 5.905	2.952 SQ.M
2.	0.5 X 5.905	2.952 SQ.M
3.	0.5 X 5.235	2.618 SQ.M
TOTAL		8.522 SQ.M
SAY AS		8.52 SQ.M

15% FACILITY AREA DETAIL OF FIRE STAIR CASE :-

S.NO.	DIMENSION	AREA
1.	0.5 X 5.905	2.952 SQ.M
2.	0.5 X 5.905	2.952 SQ.M
3.	0.5 X 5.235	2.618 SQ.M
TOTAL		8.522 SQ.M
SAY AS		8.52 SQ.M

15% FACILITY AREA DETAIL OF SERVICE SHAFT :-

S.NO.	DIMENSION	AREA
1.	0.600 X 2.375	1.425 SQ.M
2.	0.750 X 0.750	0.562 SQ.M
3.	0.5 X 0.849	0.424 SQ.M
4.	0.600 X 0.900	0.540 SQ.M
TOTAL		2.951 SQ.M
SAY AS		2.95 SQ.M

15% FACILITY AREA DETAIL OF LIFT LOBBY :-

S.NO.	DIMENSION	AREA
1.	1.465 X 2.125	3.113 SQ.M
2.	3.230 X 2.840	9.173 SQ.M
TOTAL		12.286 SQ.M
SAY AS		12.29 SQ.M

A TOWER -C1 & C2 ARE SAME AREA STATEMENT (PROPOSED IN METER SQUARE)

S. NO.	PARTICULARS	AREA sq.m. (F.A.R.)	UNITS	FACILITY	BALCONY NON F.A.R. AREA
1	BASEMENT (PROPOSED)				
2	GROUND FLOOR (PROPOSED)	355.60	56.14	5	46.05
3	1st. FLOOR (PROPOSED)	397.78	6	59.56	43.26
4	2nd. FLOOR (PROPOSED)	397.78	6	59.56	43.26
5	3rd. FLOOR (PROPOSED)	397.78	6	59.56	43.26
6	4th. FLOOR (PROPOSED)	397.78	6	59.56	43.26
7	5th. FLOOR (PROPOSED)	397.78	6	59.56	43.26
8	6th. FLOOR (PROPOSED)	397.78	6	59.56	43.26
9	7th. FLOOR (PROPOSED)	397.78	6	59.56	43.26
10	8th. FLOOR (PROPOSED)	397.78	6	59.56	43.26
11	9th. FLOOR (PROPOSED)	397.78	6	59.56	43.26
12	10th. FLOOR (PROPOSED)	397.78	6	59.56	43.26
13	11th. FLOOR (PROPOSED)	397.78	6	59.56	43.26
14	12th. FLOOR (PROPOSED)	397.78	6	59.56	43.26
15	13th. FLOOR (PROPOSED)	397.78	6	59.56	43.26
16	14th. FLOOR (PROPOSED)	397.78	6	59.56	43.26
17	15th. FLOOR (PROPOSED)	397.78	6	59.56	43.26
18	16th. FLOOR (PROPOSED)	397.78	6	59.56	43.26
19	17th. FLOOR (PROPOSED)	397.78	6	59.56	43.26
20	18th. FLOOR (PROPOSED)	397.78	6	59.56	43.26
21	19th. FLOOR (PROPOSED)	397.78	6	59.56	43.26
22	20th. FLOOR (PROPOSED)	397.78	6	59.56	43.26
23	21st. FLOOR (PROPOSED)	397.78	6	59.56	43.26
24	22nd. FLOOR (PROPOSED)	397.78	6	59.56	43.26
25	TERRACE (PROPOSED)				
26	MAIN STAIR MUMTY (PROPOSED)			22.05	
27	FIRE STAIR MUMTY (PROPOSED)			22.05	
28	MACHINE ROOM (PROPOSED)			26.16	
29	WATER TANK (PROPOSED)			22.05	
30	TOTAL	9,162.90	137	1,448.68	984.07

PROJECT :-  
PROPOSED GROUP HOUSING  
AT PLOT No. GH-01C, SECTOR-16,  
G. NOIDA.




BUILDERS & PROMOTER :-  
M/s COSMOS INFRASTATE PVT. LTD.  
ADD:- B150, SEC 63, NOIDA.

DRAWING TITLE :- TOWER - C1  
F.A.R. AREA & 15% FACILITY AREA DETAIL OF  
GROUND TO 22nd. FLOOR  
AREA STATEMENT

ARCHITECTS :-  
Space Designers International  
Architects Pvt. Ltd.  
B-34, SECTOR-67, NOIDA  
Ph: 002-243443-9  
Pin: 201309, 201302  
e-mail: spoid@gmail.com, www.spoid.com

DRAWN BY :- CHECKED BY :- SCALE 1:150 DATED :-

OWNER'S SIGN

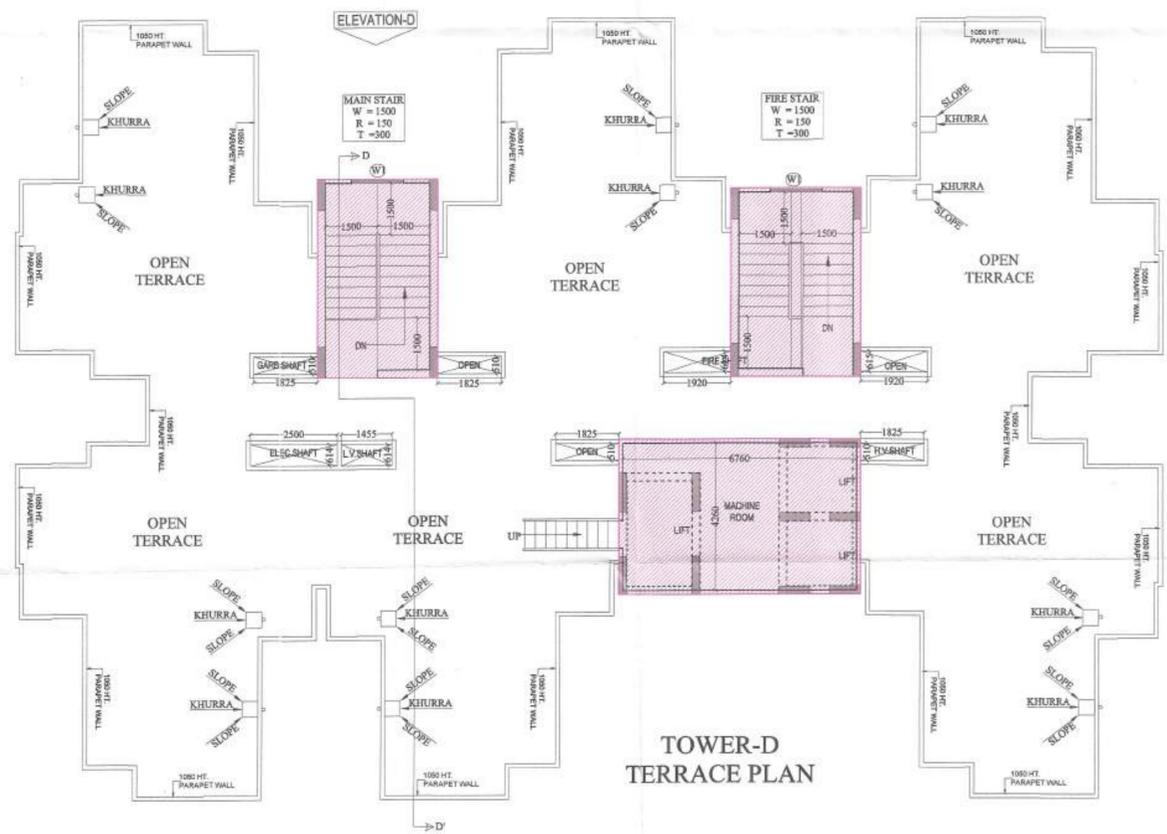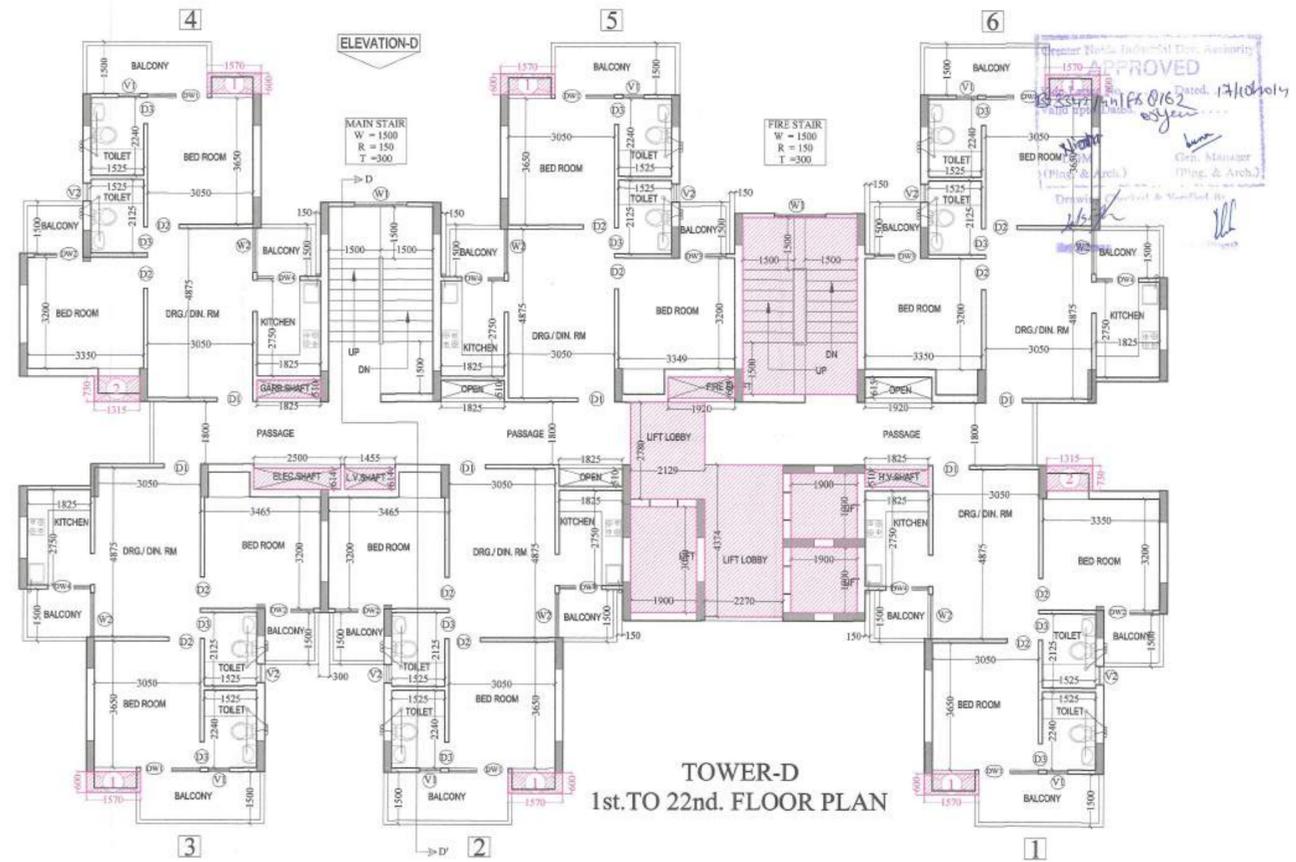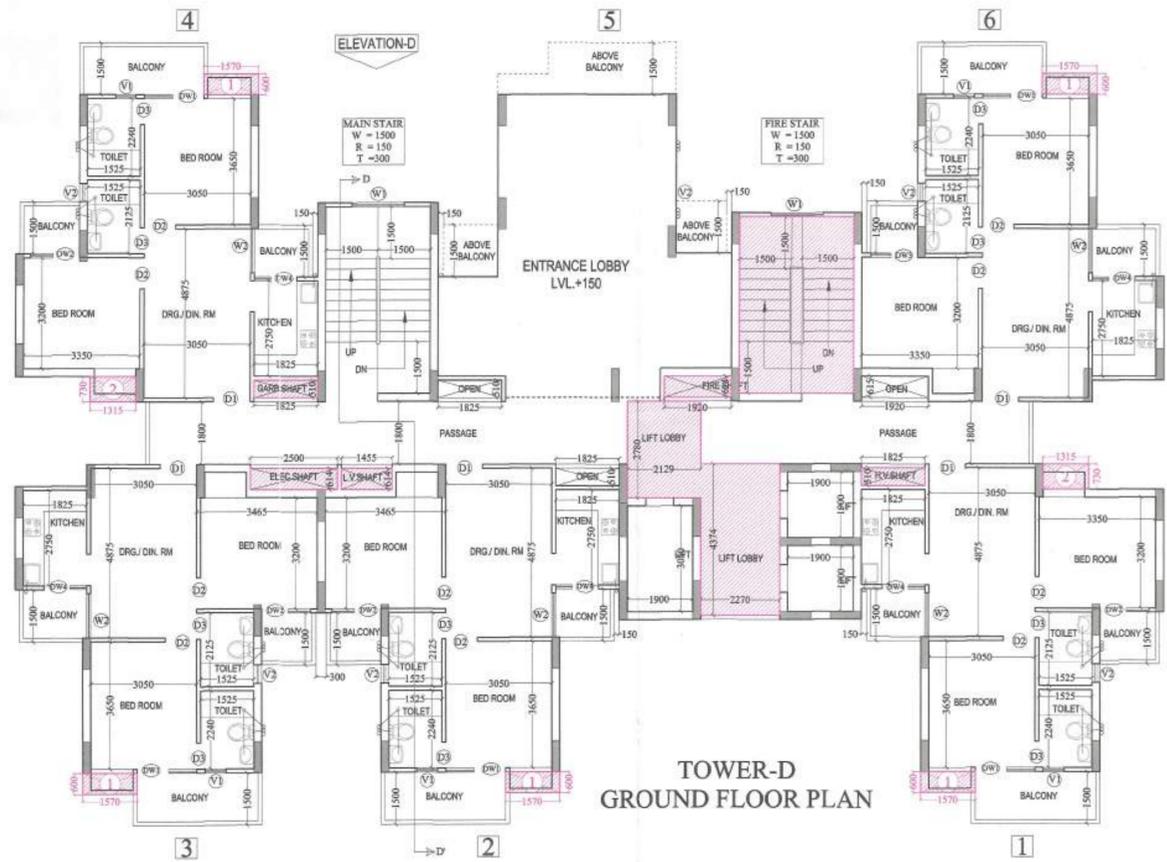


**I TOWER-D AREA STATEMENT**

S. NO.	PARTICULARS	AREA sq.ML (IN F.A.R.)	UNITS	15% FACILITY MUMTY AREA	15% FACILITY AREA	BALCONY NON F.A.R. AREA
1	2	3	4	5		
1	2 BASEMENT (NON F.A.R.)					
2	GROUND FLOOR (ENTRANCE LOBBY) (PROPOSED)	369.16 + 55.22	05		44.78	52.99
3	1st FLOOR (PROPOSED)	412.04	06		58.74	63.13
4	2nd FLOOR (PROPOSED)	412.04	06		58.74	63.13
5	3rd FLOOR (PROPOSED)	412.04	06		58.74	63.13
6	4th FLOOR (PROPOSED)	412.04	06		58.74	63.13
7	5th FLOOR (PROPOSED)	412.04	06		58.74	63.13
8	6th FLOOR (PROPOSED)	412.04	06		58.74	63.13
9	7th FLOOR (PROPOSED)	412.04	06		58.74	63.13
10	8th FLOOR (PROPOSED)	412.04	06		58.74	63.13
11	9th FLOOR (PROPOSED)	412.04	06		58.74	63.13
12	10th FLOOR (PROPOSED)	412.04	06		58.74	63.13
13	11th FLOOR (PROPOSED)	412.04	06		58.74	63.13
14	12th FLOOR (PROPOSED)	412.04	06		58.74	63.13
15	13th FLOOR (PROPOSED)	412.04	06		58.74	63.13
16	14th FLOOR (PROPOSED)	412.04	06		58.74	63.13
17	15th FLOOR (PROPOSED)	412.04	06		58.74	63.13
18	16th FLOOR (PROPOSED)	412.04	06		58.74	63.13
19	17th FLOOR (PROPOSED)	412.04	06		58.74	63.13
20	18th FLOOR (PROPOSED)	412.04	06		58.74	63.13
21	19th FLOOR (PROPOSED)	412.04	06		58.74	63.13
22	20th FLOOR (PROPOSED)	412.04	06		58.74	63.13
23	21st FLOOR (PROPOSED)	412.04	06		58.74	63.13
24	22nd FLOOR (PROPOSED)	412.04	06		58.74	63.13
25	TERRACE FLOOR (PROPOSED)					
26	FIRE STAIR CASE MUMTY (PROPOSED)			20.64		
27	MAIN STAIR CASE MUMTY (PROPOSED)			19.88		
28	WATER TANK (PROPOSED)			19.88		
29	MACHINE ROOM (PROPOSED)			31.39		
30	TOTAL	9,489.26	137	91.79	1,337.06	1441.85
				91.79+1337.06 = 1,428.85		

NOTE :-  
TOTAL GROUND COVERAGE OF THE TOWER-D = F.A.R. AREA OF 1st.FLOOR + 15% FACILITY AREA OF 1st.FLOOR = 412.04 + 58.74 = 470.78 SQ.M

**DETAIL OF DOOR WINDOW**

TYPE	SIZE	CILL LVL.	LINTEL LVL.
D1	1050 X 2500	----	2500
D2	900 X 2100	----	2100
D3	750 X 2100	----	2100
DW1	1710 X 2050	450	2500
DW2	1405 X 2050	450	2500
DW3	1330 X 2050	450	2500
DW4	1225 X 1350	1150	2500
W1	1500 X 2050	450	2500
W2	1270 X 1350	550	2500
V1	525 X 1000	1500	2500
V2	600 X 1000	1500	2500

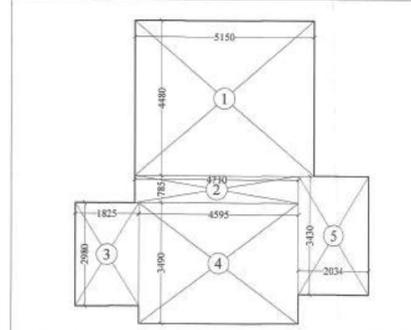

1.	5.150 X	4.480	=	23.072	SQ.M
2.	4.710 X	0.785	=	3.697	SQ.M
3.	1.825 X	2.980	=	5.438	SQ.M
4.	4.595 X	3.490	=	16.037	SQ.M
5.	2.034 X	3.430	=	6.977	SQ.M
	<b>TOTAL</b>			<b>55.221</b>	<b>SQ.M</b>
	<b>SAY AS</b>			<b>55.22</b>	<b>SQ.M</b>

**PROJECT :-**  
PROPOSED GROUP HOUSING  
AT PLOT No. GH-01C, SECTOR-16,  
G. NOIDA.

**BUILDERS & PROMOTER :-**  
M/s COSMOS INFRAESTATE PVT. LTD.  
ADD:- B150, SEC 63, NOIDA.

**DRAWING TITLE :-** TOWER - D  
GROUND TO 22nd. FLOOR PLAN  
TERRACE PLAN  
AREA STATEMENT

**ARCHITECTS :-**  
Space Designers International  
Architects Pvt. Ltd.  
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**Space Designers**  
architects & planners

**DRAWN BY :-** SANJAY  
**CHECKED BY :-** VISHAL  
**SCALE** 1:100  
**DATED :-**

**OWNER'S SIGN**

**ARCHITECT'S SIGN**  
DRG.NO. - 22