
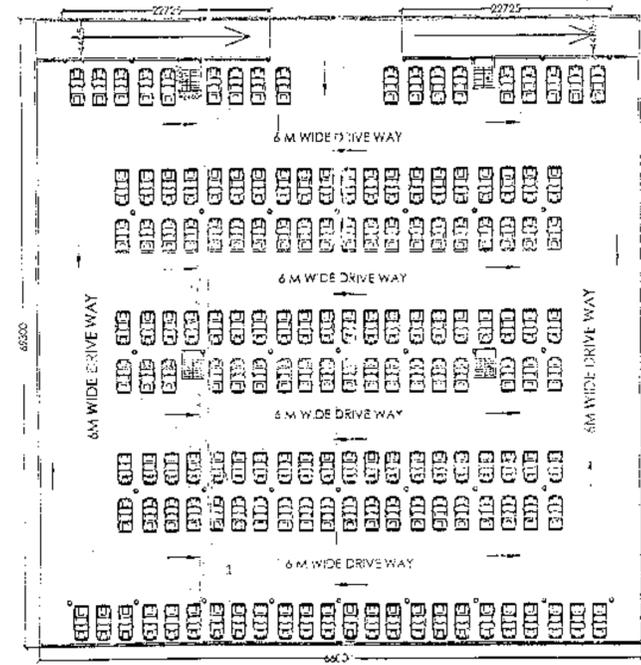


Greater Noida Industrial Dev. Authority
OCCUPANCY
 Via Letter No. Date:
 Valid from Date:

DOM (Plng & Arch) Genl. Manager (Plng & Arch)
 Drawing Checked & Verified By

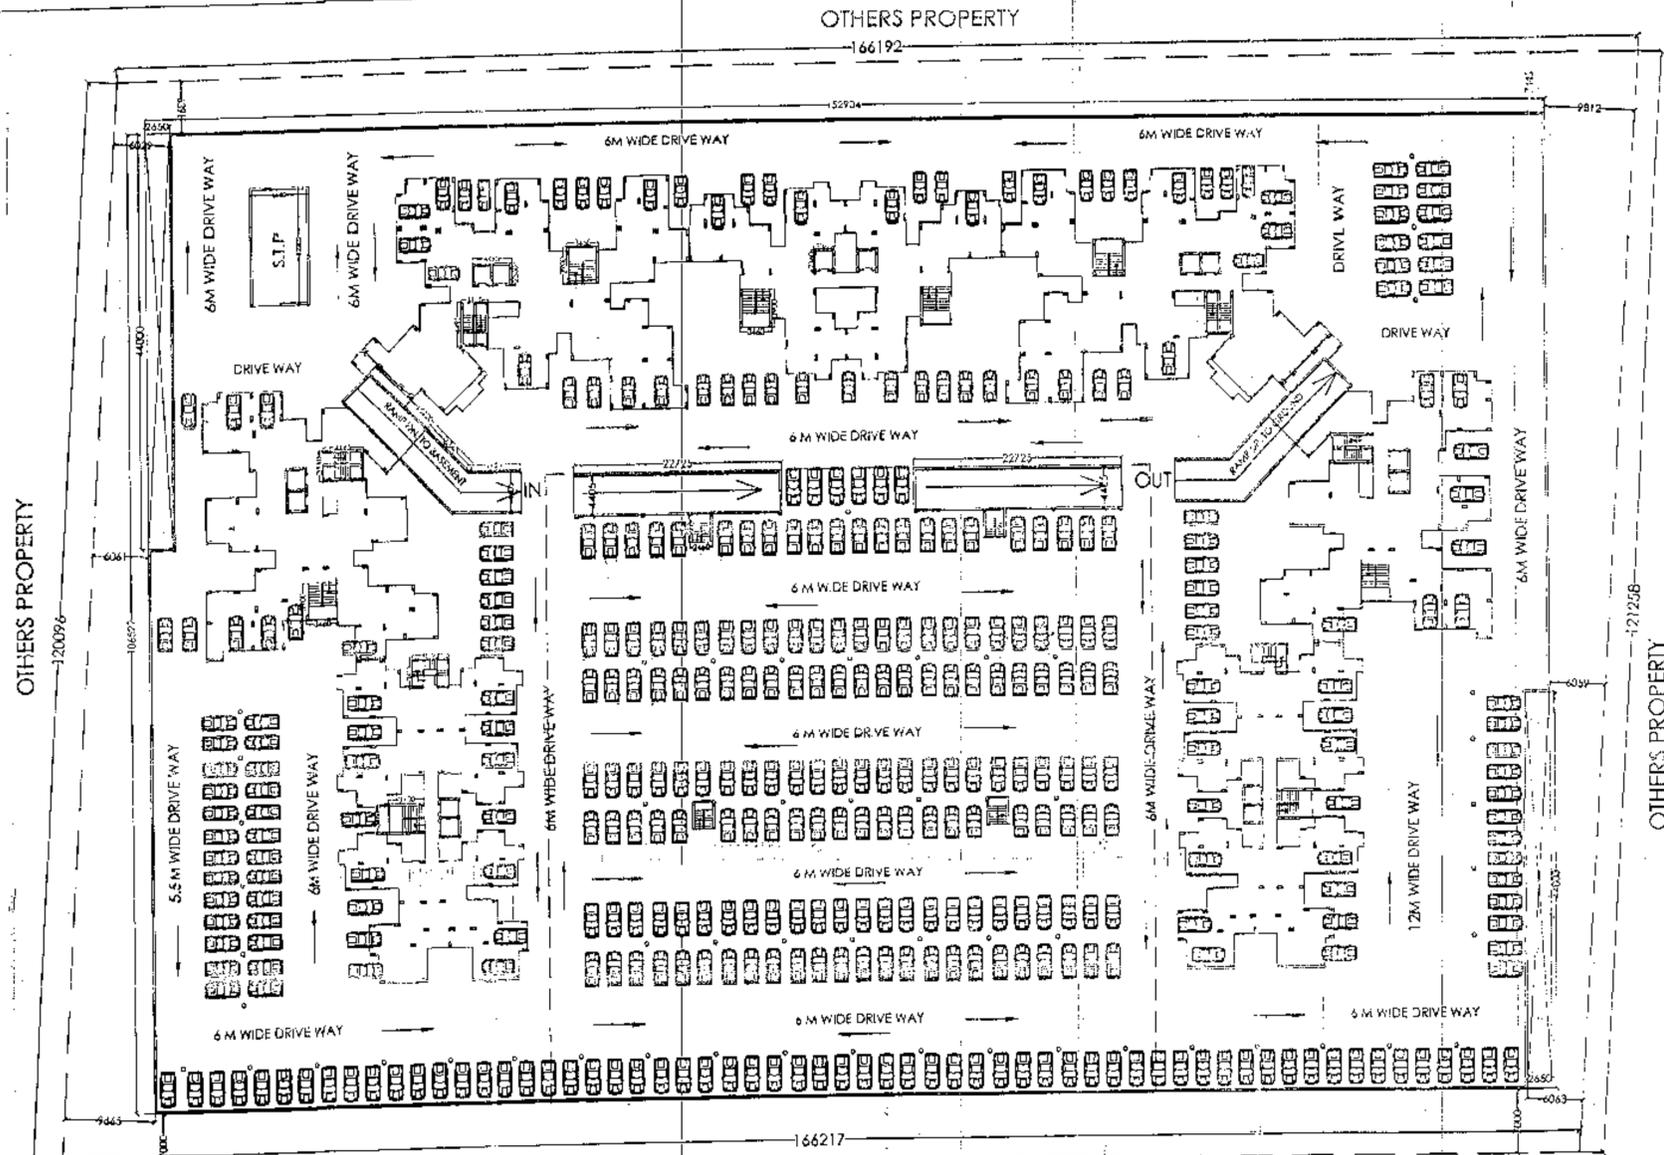

SECOND BASEMENT PLAN

FIRST BASEMENT PLAN

(1)	=	(3.9X3.46X8)	=	107.952
(2)	=	(3.11X4.495X4)	=	55.917
(3)	=	(3.61X4.05X2)	=	29.241
(4)	=	(2.46X3.33X4)	=	32.767
(5)	=	(4.49X2.36X6)	=	63.578
(6)	=	(2.36X2.36X2)	=	11.139
(7)	=	(15.22+5.986)X4.405X2	=	186.824
(8)	=	(22.725X4.405X2)	=	200.207
(9)	=	(6.44X12.20)	=	78.568
TOTAL DEDUCTIONS			=	766.193 SQ.M.
CARPARKING PROVIDED			=	15288.246 SQ.M.
OR (15288.246/30)			=	509 E.C.S.

COVERED AREA FOR FIRST BASEMENT FLOOR AREA :-
 = 152.904 X 106.522 (2.65X44.00X2 NOS.)
 = 16287.639 - (233.20) = **16054.439 SQ.M.**

CAR PARKING SPACE PROVIDED IN FIRST BASEMENT AREA (DEDUCTION):-
 = STAIRCASE AREA+LIFT WELL + RAMP AREA + S.T.P.

COVERED AREA FOR SECOND BASEMENT FLOOR AREA :-
 = 66.0 X 69.30
 = **4573.80 SQ.M.**



CAR PARKING SPACE PROVIDED IN SECOND BASEMENT AREA (DEDUCTION):-
 = (STAIRCASE AREA+ RAMP AREA)

(1)	=	(2.46X3.33X4)	=	32.767
(2)	=	(22.725X4.405X2)	=	200.207
TOTAL DEDUCTIONS			=	232.974 SQ.M.
CARPARKING PROVIDED			=	4340.826 SQ.M.
OR (4340.826/30)			=	144 E.C.S.


Greater Noida Industrial Dev. Authority
APPROVED
 M. N. ANDLEY
 B. ARCH. P.L.A. F.V.
 ARCHITECTS

PROJECT:-
GROUP HOUSING FOR
M/S JNC CONSTRUCTION PVT. LTD.
 PLOT NO. 1C, SECTOR 16 C AT GREATER NOIDA. (U.P.)


SIGNING AUTHORITY	ARCHITECTS SIGN	SUBMISSION DRAWING	NORTH	ARCHITECTS
<i>Thomas P...</i>	<i>M. N. Andley</i>	1ST & 2ND BASEMENT FLOOR PLAN	↑	M. N. ANDLEY B. ARCH. P.L.A. F.V.
	M. N. ANDLEY B. ARCH. P.L.A. F.V. ARCHITECTS	SCALE: 1/400		ANDLEYS ASSOCIATES PVT. LTD.
		DRG. NO.: 02		ENGINEERS PLANNERS
		DATE: 18/03/2014		39 HOUSING SOCIETY NO. 524 NEW DELHI - 110049

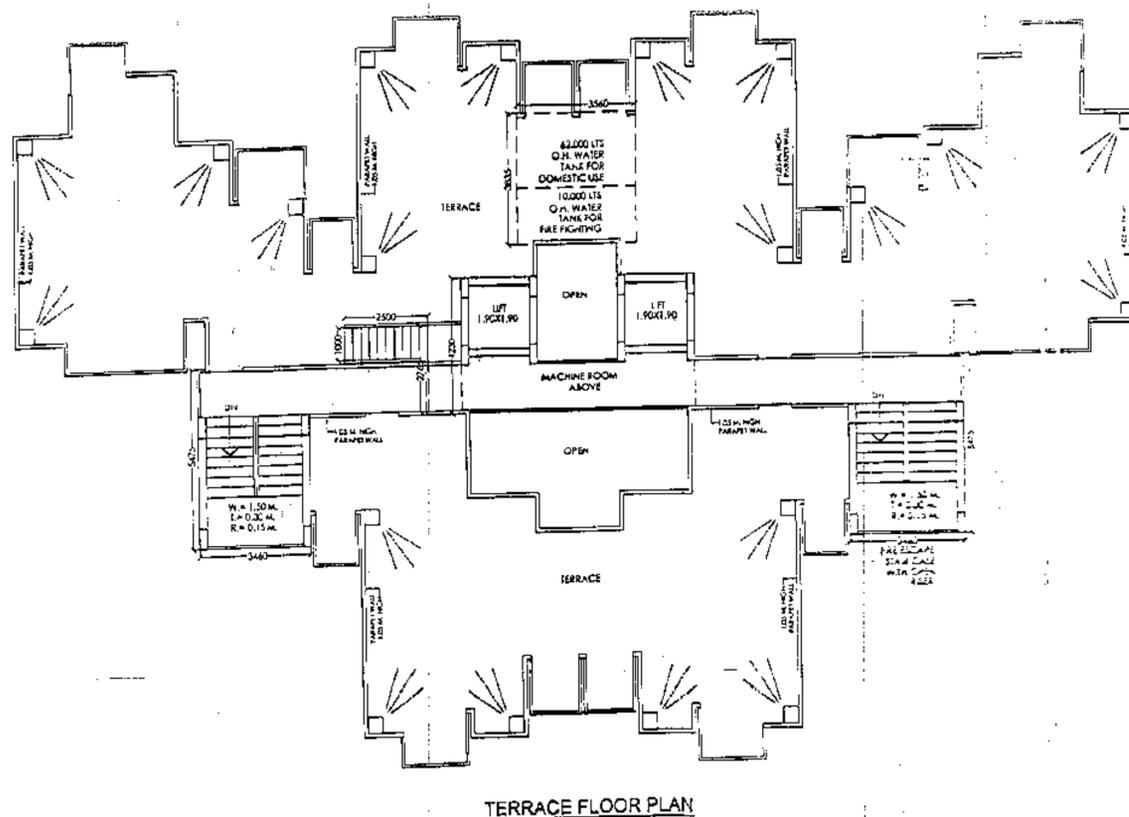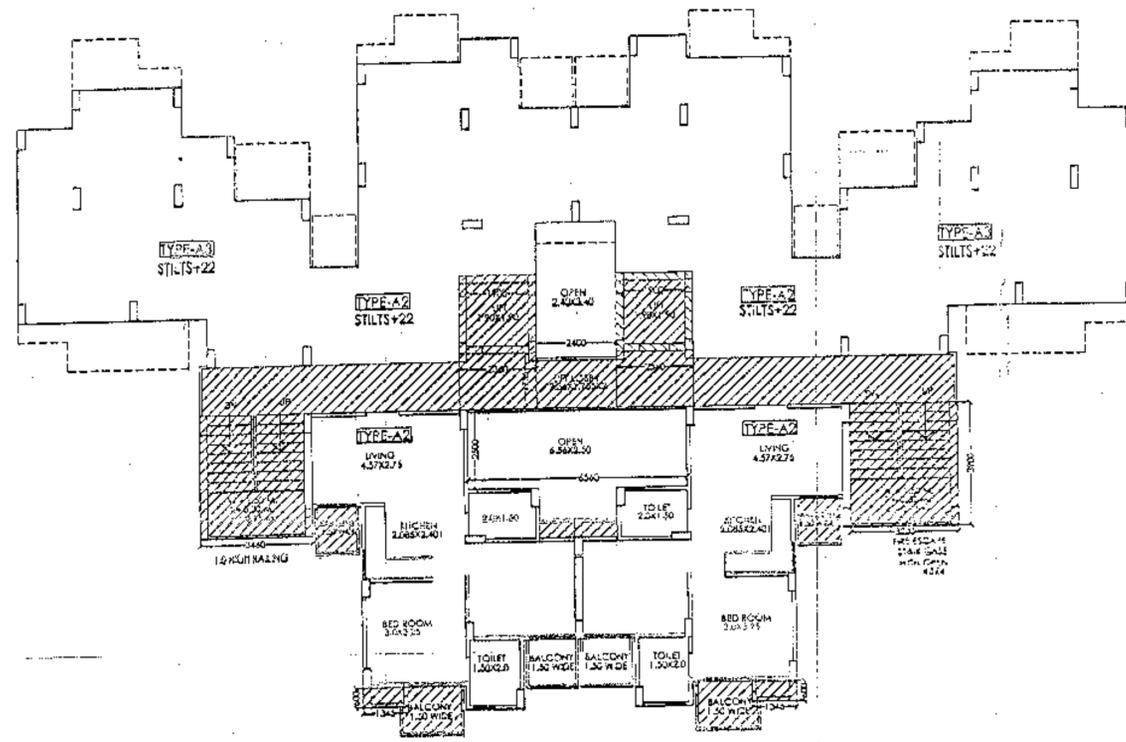


AREA DETAIL OF MUMTY :-
 $= (3.44 \times 5.475 \times 2) = 37.887 \text{ SQ.M.}$

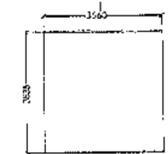

AREA DETAIL OF WATER TANK :-
 $= 3.54 \times 3.635 = 13.652 \text{ SQ.M.}$

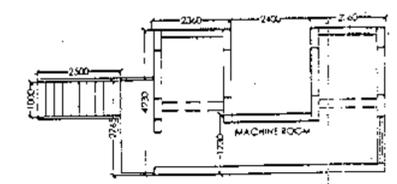

MACHINE ROOM FLOOR PLAN

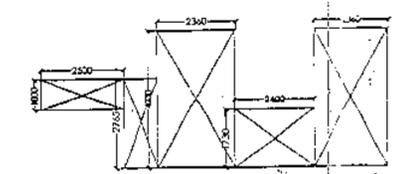

AREA DETAIL OF MACHINE ROOM :-
 $= (4.23 \times 2.36 \times 2) + (2.4 \times 1.73) + (1.8 \times 2.75) + (2.50 \times 1.0) = 29.38 \text{ SQ.M.}$

SCHEDULE OF DOOR & WINDOWS				
NO.	TYPE	SIZE	CILL. LVL.	LTL. LVL.
1	W	1.100 X 2.10	-	2.10 M.
2	W	1.90 X 2.10	-	2.10
3	W	1.680 X 2.50	-	2.50
4	DW-2	1.250 X 2.50	-	2.50
5	W	0.90 X 1.450	1.050	2.50
6	W	0.45 X 1.450	1.050	2.50

SIGN NO AUTHORITY

Jitendra Singh

ARCHITECT'S SIGN

M. N. Andley
 M. N. ANDLEY
 B. ARCH. F.I.I.A., F.I.V.
 ARCHITECT CA/78/1841

SUBMISSION DRAWING

PROJECT:-
 GROUP HOUSING FOR
JNC CONSTRUCTION (P) LTD.
 PLOT NO.-1C, SECTOR-16 C AT
 GREATER NOIDA. (U.P.)

DRG. TITLE:-
 TYPICAL FLOOR PLAN (BLOCK-D)

SCALE:-1:20

DRG. NO:-15

D.T.BY:-

DATE:-18/05/2014


ARCHITECTS:-

M.N. ANDLEY B.A.R.C.H. F.I.I.A. F.I.V.

ANDLEYS ASSOCIATES PVT. LTD.

ARCHITECTS ENGINEERS PLANNERS

39 HOUSING SOCIETY N.C.S.E SW DELHI - 1100

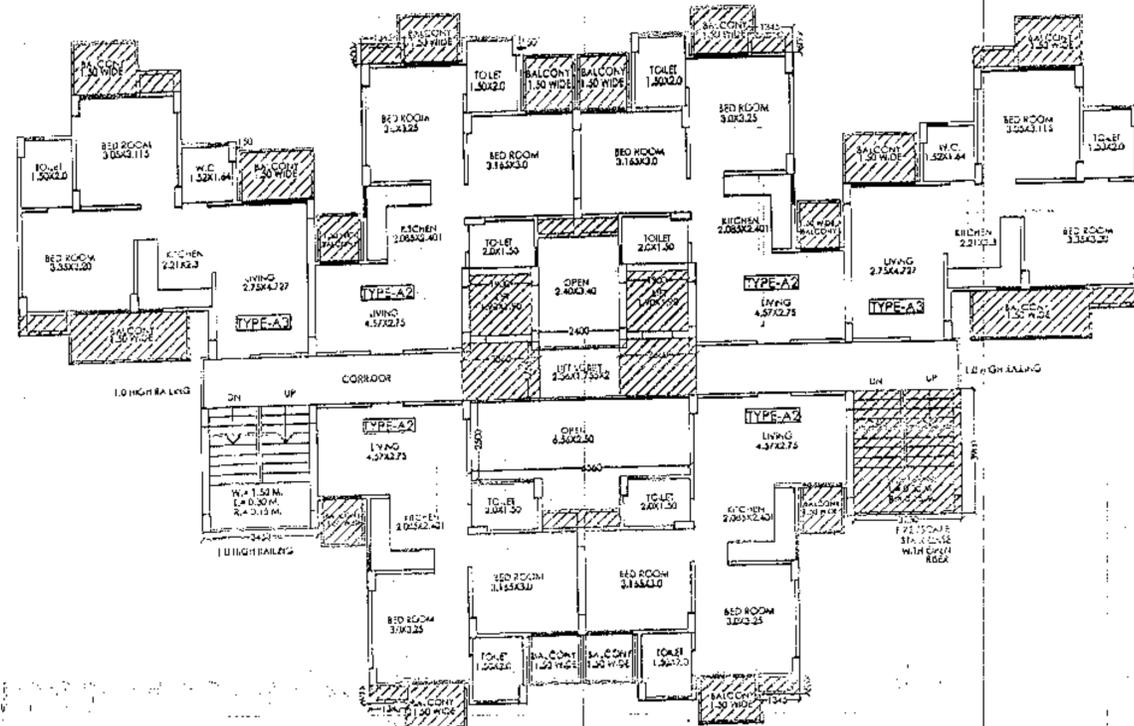

F.A.R. AREA:-

COVERED AREA DETAIL ON GROUND FLOOR :-

= (A2X2) (CIRCULATION AREA AT ONE FLOOR) + (LIFT WELL) :-

= (50.091X2) + (42.571) + (7.22)

= 149.973 SQ.M.

COVERED AREA DETAIL AT ONE FLOOR (1ST TO 22ND) :-

= (TYPE-A2X4) + (TYPE-A3X2) + (CIRCULATION AREA AT ONE FLOOR) :-

= (50.091X4) + (52.343X2) + (42.571)

= (200.364) + (104.686) + (42.571) = 347.621 SQ.M.

GROUND COVERAGE FOR ONE BLOCK :-

= (TYPE-A2X4) + (TYPE-B3X2) + (CIRCULATION AREA AT ONE FLOOR)

+ (LIFT WELL AREA) + (LIFT LOBBY) + FIRESCAPE STAIR + CUP BOARD (A2X4 + A3X2) :-

= (50.091X4) + (52.343X2) + (42.571) + (1.9X1.9X2) + (8.283)

+ (12.597) + (1.575X4) + (1.854X2)

= (200.364) + (104.686) + (42.571) + (7.22) + (8.283) + (12.597) + (10.008)

= 385.729 SQ.M.

15% EXTRA F.A.R. AREA CALCULATION FOR BLOCK-D :-

AREA DETAIL OF FIRESCAPE STAIRCASE :-

= 3.23 X 3.9 = 12.597 SQ.M.

AREA DETAIL OF MUMTY :-

= (3.46 X 5.475 X 2) = 37.887 SQ.M.

AREA DETAIL OF MACHINE ROOM

= (4.23 X 2.34X2) + (2.4X1.73) + (1.0X2.765) + (2.50X1.0) = 29.888 SQ.M.

AREA DETAIL OF WATER TANK :-

= 3.56 X 3.835 = 13.622 SQ.M.

CUPBOARD AREA DETAIL FOR ONE UNIT TYPE-A2

(1.345X0.6) + (1.28X0.6) = 1.575 SQ.M.

CUPBOARD AREA DETAIL FOR ONE UNIT TYPE-A3

(1.545X0.6X2) = 1.854 SQ.M.

DETAIL OF LIFT WELL AREA :-

(1.90 X 1.90X2) = 7.22 SQ.M.

DETAIL OF LIFT LOBBY AREA :-

(2.36X1.75X2) = 8.283 SQ.M.

15% EXTRA FAR AREA DETAIL ON GROUND FLOOR :-

= FIRESCAPE STAIR + LIFT LOBBY + CUP BOARD (A2X2) + CUP BOARD (A3X2) :-

= 12.597 + 8.283 + (1.575X2) + (1.854X2) = 32.738 SQ.M.

15% EXTRA FAR AREA DETAIL AT ONE FLOOR (1ST TO 22ND) :-

= FIRESCAPE STAIR + CUP BOARD (A2X4) + CUP BOARD (A3X2) + LIFT LOBBY :-

= 12.597 + (1.575X4) + (1.854X2) + 8.283 = 39.888 SQ.M.

15% EXTRA FAR AREA DETAIL ON ALL FLOOR :- BLOCK-D :-


= GROUND FLOOR + 1ST FLOOR TO 22ND FLOOR + MUMTY +

MACHINE ROOM + WATER TANK

= 27.738 + (30.888X2) + 37.887 + 29.382 + 13.622

= 788.195 SQ.M.

SCHEDULE OF DOOR & WINDOWS				
S.NO	TYPE	SIZE	QTY	LVL. LVL.
1	D	0.90 X 2.10	10	2.10 M.
2	D	1.50 X 2.10	10	2.10
3	DW-1	1.80 X 2.50	10	2.50
4	DW-2	1.200 X 2.50	10	2.50
5	W	0.90 X 1.450	1050	2.50
6	W-1	0.45 X 1.450	1050	2.50

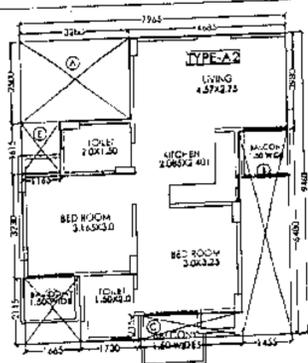

UNIT PLAN TYPE-A2 (SCALE:- 1:100)

COVERED AREA DETAIL OF ONE UNIT TYPE-A2


= (7.965X9.46) - ((A)+(B)+(C)+(D)+(E))

= (75.348) - A(3.28X2.50) + B(1.455X6.48) + C(3.115X0.715)

+ D(1.665X2.115) + E(1.165X1.615)

= (75.348) - A(8.2) + B(9.428) + C(2.227) + D(3.521) + E(1.881)

= (75.348) - (25.257) = 50.091 SQ.M.

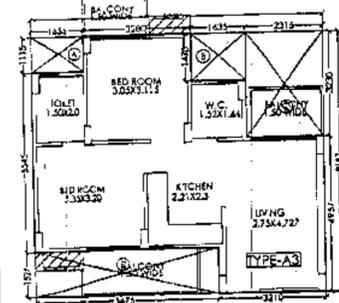

UNIT PLAN TYPE-A3 (SCALE:- 1:100)

COVERED AREA DETAIL OF ONE UNIT TYPE-A3


= (6.885X8.67) - ((A)+(B)+(C)+(D))

= (72.741) - A(1.655X1.115) + B(1.635X1.475) + C(2.315X3.23)

+ D(5.675X1.527)

= (72.741) - A(1.845) + B(2.411) + C(7.477) + D(8.665)

= (72.741) - (20.398) = 52.343 SQ.M.

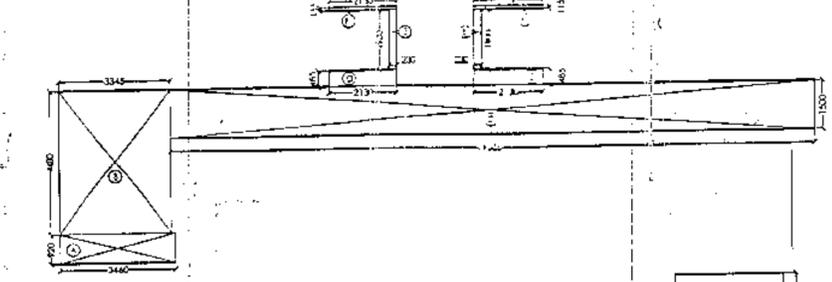

CIRCULATION AREA AT ONE FLOOR (SCALE:- 1:100)

COVERED AREA OF CIRCULATION AT ONE FLOOR :-

= (A)+(B)+(C)+(DX2)+(EX2)+(FX2) - (LIFT LOBBY) :-

= A(3.45X0.92) + B(3.345X4.48) + C(1.950X1.5) + D(2.13X0.895X2) + E(0.234X1.942)

+ F(2.13X0.115X2) - (2.36X1.755X2) :-

= A(3.183) + B(14.985) + C(29.257) + D(2.066) + E(0.874) + F(2.489) - (8.283) :-

= 50.854 - 8.283 = 42.571 SQ.M.

AREA DETAIL OF FIRESCAPE STAIRCASE :-

= 3.23 X 3.9 = 12.597 SQ.M.

SIGNING AUTHORITY

Handwritten Signature

ARCHITECTS SIGN

Handwritten Signature

M. N. ANDLEY
B. ARCH. F.I.I.A., F.I.V.
ARCHITECT CA/75/1841

SUBMISSION DRAWING

PROJECT:-
GROUP HOUSING FOR
JNC CONSTRUCTION (P) LTD.
PLOT NO.-1C, SECTOR-16 C AT
GREATER NOIDA. (U.P.)


DRG. TITLE:-
TYPICAL FLOOR PLAN (BLOCK-D)

SCALE:- 1:100


DRG. NO.- 14

DATE:- 18/05/2014


ARCHITECTS:-
M. N. ANDLEY BARCH. F.I.I.A., F.I.V.
ANDLEYS ASSOCIATES PVT. LTD.
ARCHITECTS ENGINEERS PLANNERS
39 HOUSING SOCIETY N.D.S.E-4 NEW DELHI - 110049

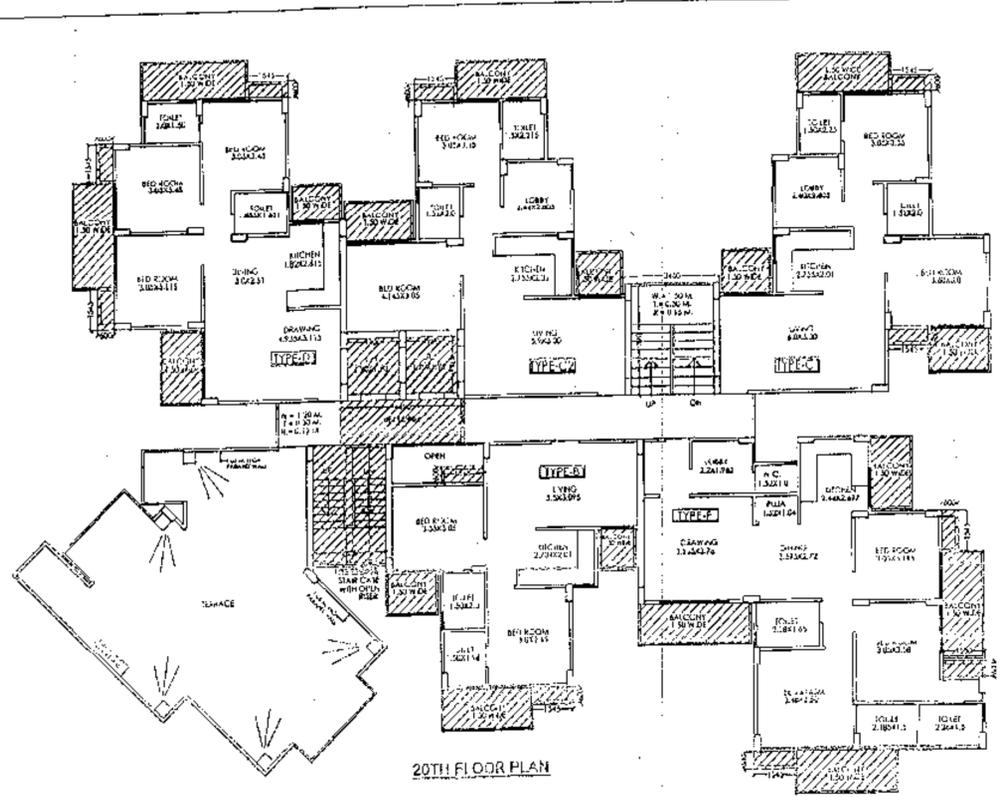


20TH FLOOR PLAN

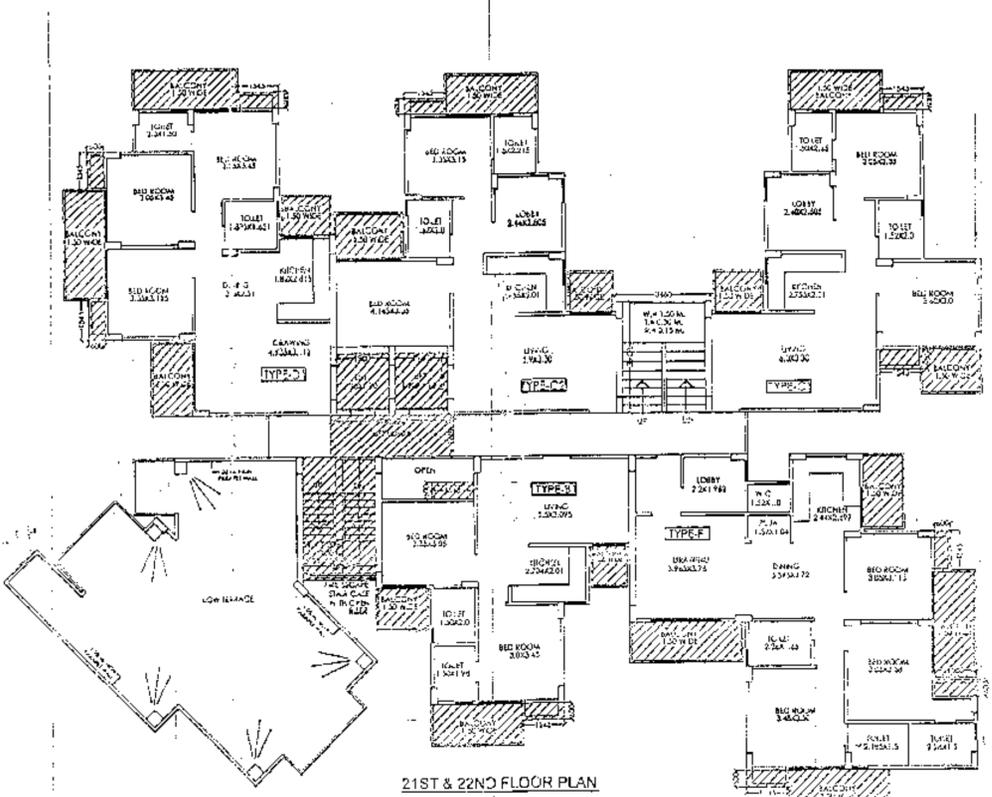


21ST & 22ND FLOOR PLAN

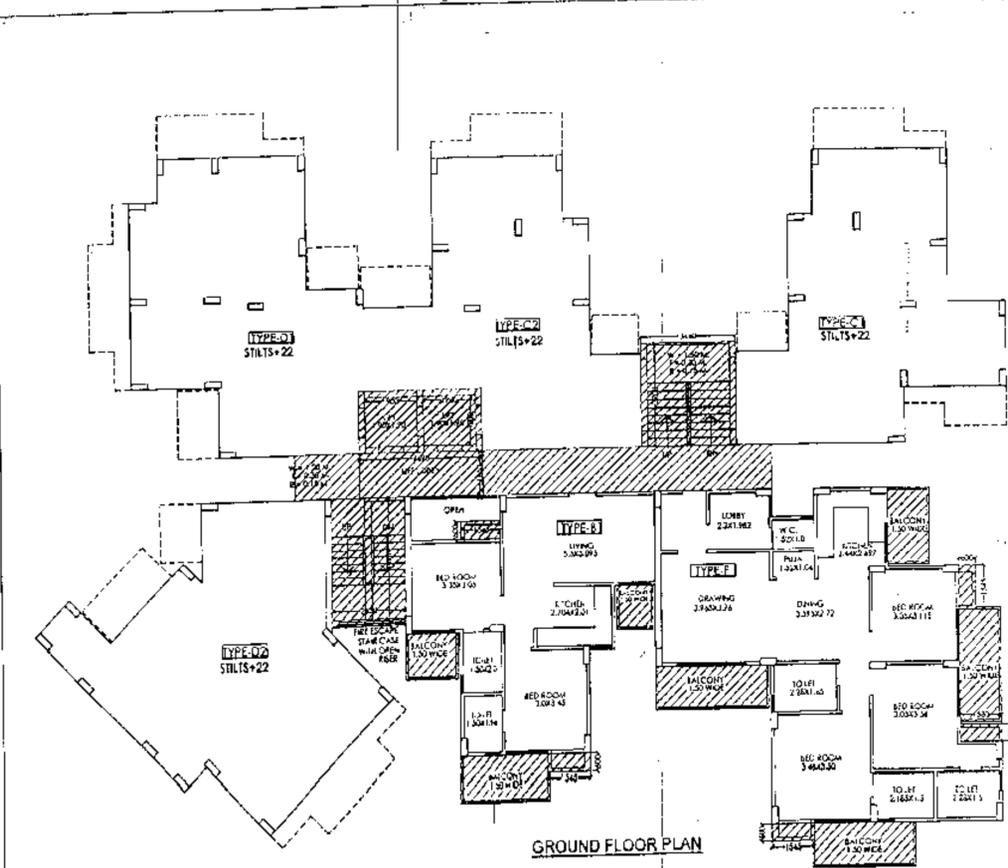

GROUND FLOOR PLAN

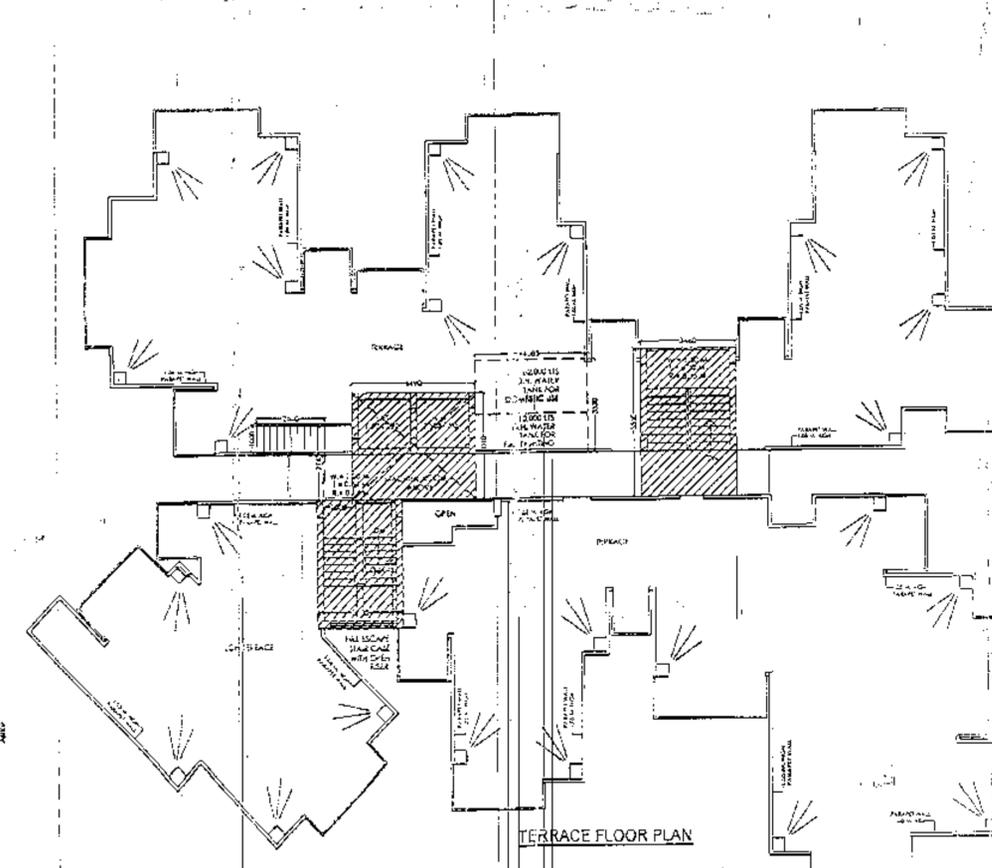

TERRACE FLOOR PLAN

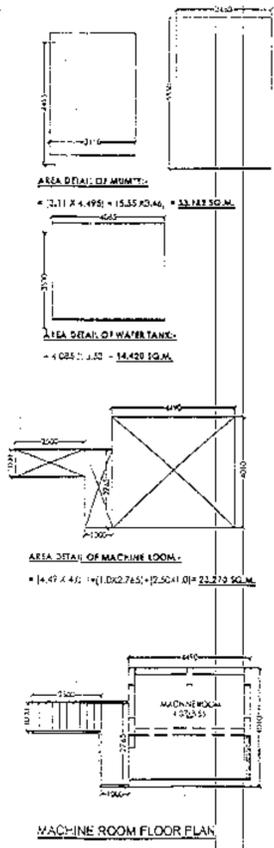

MACHINE ROOM FLOOR PLAN

SCHEDULE OF DOOR & WINDOWS

NO.	TYPE	SIZE	QTY	UNIT	QTY	UNIT
1	DOOR	0.150 X 2.10	-		2.10	M.
2	DOOR	0.900 X 2.10	-		2.10	M.
3	DOOR	0.680 X 2.50	-		2.50	M.
4	DWELL	1.250 X 2.50	-		2.50	M.
5	DOOR	0.90 X 1.450	1,050		2.50	M.
6	W-I	0.45 X 1.450	1,050		2.50	M.

COVERED AREA DETAIL AT ONE FLOOR (21ST TO 23RD):
 = (TYPE-B) + (TYPE-B1) + (TYPE-C1) + (TYPE-C2) + (TYPE-D)
 = (CIRCULATION AREA AT ONE FLOOR):
 = (79.623) + (58.309) + (71.438) + (73.025) + (74.281) + (36.258)
 = 412.904 SQ.M.
 15% EXTRA FAR AREA DETAIL AT ONE FLOOR (21ST TO 23RD):
 = FRESH AIR STAIR + CUP BOARD + (B1 + C1 + C2 + D1)
 + LIFT LOBBY:
 = 11.911 + 2.772 + 1.254 + 1.254 + 0.977 + 2.751 + 7.408
 = 28.507 SQ.M.
 15% EXTRA FAR AREA DETAIL USE TO 20TH FLOOR OF BLOCK-C:
 = GROUND FLOOR + 1ST FLOOR TO 20TH FLOOR + MUMTY +
 MACHINE ROOM + WATER TANK + 21ST TO 23RD FLOOR
 = 31.165 + (31.261 X 20) + 32.82 + 23.270 + 14.420 + (28.507 X 3)
 = 312.778 SQ.M.

AREA DETAIL OF MUMTY:
 = 2.11 X 4.495 = 9.4844 = 9.484 SQ.M.

AREA DETAIL OF WATER TANK:
 = 4.085 X 3.50 = 14.297 SQ.M.

AREA DETAIL OF MACHINE ROOM:
 = 14.47 X 4.40 = 63.868 SQ.M.

SIGNING AUTHORITY

ARCHITECT'S SIGN

M. N. ANDLEY
 B. ARCH. F.I.A., F.I.V.
 ARCHITECT (A/751/184)

SUBMISSION DRAWING


PROJECT:
**GROUP HOUSING FOR
 JNC CONSTRUCTION (P) LTD.
 PLOT NO.-1C, SECTOR-16 C AT
 GREATER NOIDA. (U.P.)**

DRG. TITLE:
**GROUND & TERRACE FLOOR PLAN (BLOCK-C & C2)
 21ST TO 23RD FLOOR PLAN**

SCALE: 1:100 DRG. NO.: 12

DATE: 18/05/2014

ARCHITECTS:
 M. N. ANDLEY B. ARCH. F.I.A., F.I.V.
ANDLEYS ASSOCIATES PVT. LTD.
 ARCHITECTS ENGINEERS PLANNERS
 39 HOUSING SOCIETY N.D.S.E.H. NEW DELHI - 110049

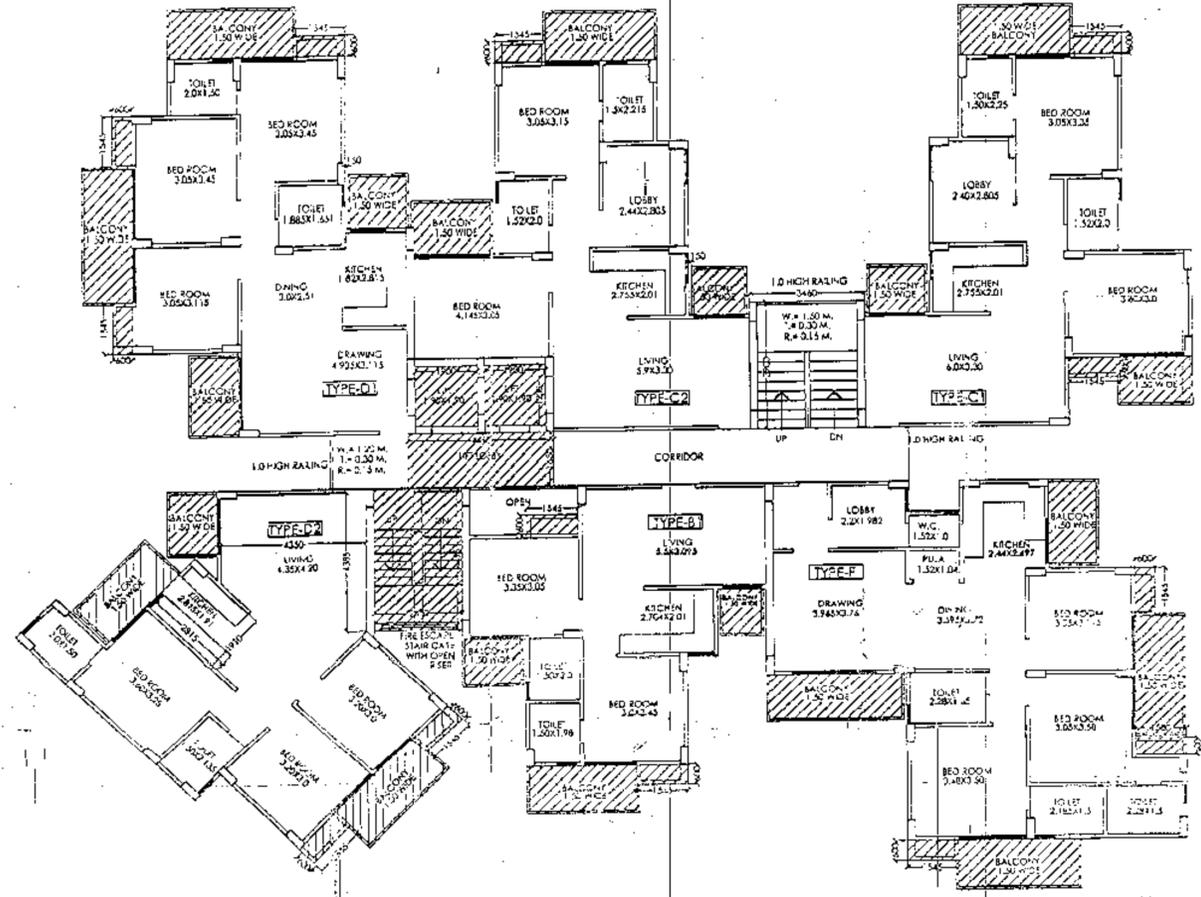

1ST TO 19TH FLOOR PLAN

F.A.R. AREA:-

COVERED AREA DETAIL ON GROUND FLOOR:-
 $= (B1) + (F) + (CIRCULATION AREA AT ONE FLOOR) + (LIFT WELL) = 201.41 \text{ SQ.M.}$

COVERED AREA DETAIL AT ONE FLOOR (1ST TO 19TH):-
 $= (TYPE-F) + (TYPE-B1) + (TYPE-C1) + (TYPE-C2) + (TYPE-D1) + (TYPE-D2) + (CIRCULATION AREA AT ONE FLOOR) = 489.355 \text{ SQ.M.}$

COVERED AREA DETAIL AT ONE FLOOR (20TH TO 22ND):-
 $= (TYPE-F) + (TYPE-B1) + (TYPE-C2) + (TYPE-D1) + (CIRCULATION AREA AT ONE FLOOR) = 412.904 \text{ SQ.M.}$

GROUND COVERAGE FOR ONE BLOCK:-
 $= (TYPE-F) + (TYPE-B1) + (TYPE-C1) + (TYPE-C2) + (TYPE-D1) + (TYPE-D2) + (CIRCULATION AREA AT ONE FLOOR) + (LIFT WELL AREA) + (LIFT LOBBY) + (FIRE STAIRCASE + CUP BOARD (F+B1+C1+C2+D1+D2)) = 527.936 \text{ SQ.M.}$

15% EXTRA FAR AREA DETAIL AT ONE FLOOR (20TH TO 22ND):-
 $= \text{FIRESCAPE STAIR} + \text{CUP BOARD (F+B1+C1+C2+D1+D2)} + \text{LIFT LOBBY} = 29.507 \text{ SQ.M.}$

15% EXTRA FAR AREA DETAIL ON ALL FLOORS OF BLOCK-C & C2:-
 $= \text{GROUND FLOOR} + \text{1ST FLOOR TO 19TH FLOOR} + \text{MUMTY} + \text{MACHINE ROOM} + \text{WATER TANK} + \text{20TH TO 22ND FLOOR} = 779.197 \text{ SQ.M.}$

15% EXTRA F.A.R. AREA CALCULATION FOR BLOCK C1 & C2:-

AREA DETAIL OF FIRESCAPE STAIRCASE:-
 $= 2.65 \times 4.495 = 11.911 \text{ SQ.M.}$

AREA DETAIL OF MUMTY:-
 $= (3.11 \times 4.495) + (5.55 \times 3.44) = 33.182 \text{ SQ.M.}$

AREA DETAIL OF MACHINE ROOM
 $= (4.49 \times 4.01) + (1.0 \times 2.765) + (2.50 \times 1.0) = 23.270 \text{ SQ.M.}$

AREA DETAIL OF WATER TANK:-
 $= 4.085 \times 3.53 = 14.420 \text{ SQ.M.}$

CUPBOARD AREA DETAIL FOR ONE UNIT TYPE-F
 $(1.545 \times 0.6 \times 2) + (1.53 \times 0.6) = 2.772 \text{ SQ.M.}$

CUPBOARD AREA DETAIL FOR ONE UNIT TYPE-B1
 $(1.545 \times 0.6 \times 2) = 1.854 \text{ SQ.M.}$

CUPBOARD AREA DETAIL FOR ONE UNIT TYPE-C1
 $(1.545 \times 0.6 \times 2) = 1.854 \text{ SQ.M.}$

CUPBOARD AREA DETAIL FOR ONE UNIT TYPE-C2
 $(1.545 \times 0.6) = 0.927 \text{ SQ.M.}$

CUPBOARD AREA DETAIL FOR ONE UNIT TYPE-D1
 $(1.545 \times 0.6 \times 3) = 2.781 \text{ SQ.M.}$

CUPBOARD AREA DETAIL FOR ONE UNIT TYPE-D2
 $(1.545 \times 0.6 \times 2) = 1.854 \text{ SQ.M.}$


DETAIL OF LIFT WELL AREA:-
 $(1.90 \times 1.90 \times 2) = 7.22 \text{ SQ.M.}$

DETAIL OF LIFT LOBBY AREA:-
 $(4.49 \times 1.65) = 7.409 \text{ SQ.M.}$


15% EXTRA FAR AREA DETAIL ON GROUND FLOOR:-
 $= \text{FIRESCAPE STAIR} + \text{LIFT LOBBY} + \text{CUP BOARD (F+B1+C1+C2+D1+D2)} = 23.945 \text{ SQ.M.}$

15% EXTRA FAR AREA DETAIL AT ONE FLOOR (1ST TO 19TH):-
 $= \text{FIRESCAPE STAIR} + \text{CUP BOARD (F+B1+C1+C2+D1+D2)} + \text{LIFT LOBBY} = 31.361 \text{ SQ.M.}$


NO.	TYPE	SIZE	QTY.	AREA	HT. LVL.	TL. LVL.
1	D	0.100 X 2.10	-	2.10 M.	-	-
2	D	0.90 X 2.10	-	2.10	-	-
3	D	1.680 X 2.50	-	2.50	-	-
4	DW-2	1.250 X 2.50	-	2.50	-	-
5	DW-1	0.90 X 1.450	1.050	2.50	-	-
6	W-1	0.45 X 1.450	1.050	2.50	-	-

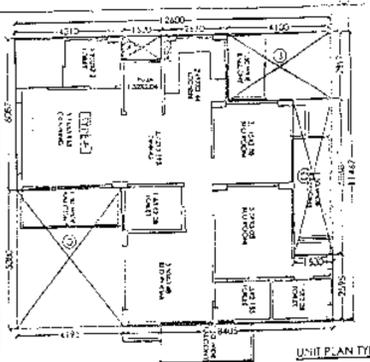


COVERED AREA DETAIL OF ONE UNIT TYPE-F
 $= (12.60 \times 11.467) - [(A) + (B) + (C) + (D)] = 144.484$
 $+ C(1.53 \times 0.6) + D(1.95 \times 0.5) = 144.484 - (1.44) - (1.11) - (1.529) + C(9.27) + D(2.569) = 144.454 - (4.461) = 139.993 \text{ SQ.M.}$

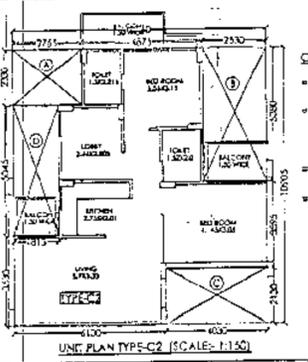


COVERED AREA DETAIL OF ONE UNIT TYPE-C2
 $= (10.6 \times 10.905) - [(A) + (B) + (C) + (D)] = 110.794$
 $+ C(2.75 \times 0.33) + D(2.5 \times 0.5) + E(4.52 \times 2.10) + D(1.8 \times 0.5) = 110.794 - (6.419) - (13.611) - (8.583) - (0.9156) + (1.10794) - (37.765) = 73.025 \text{ SQ.M.}$

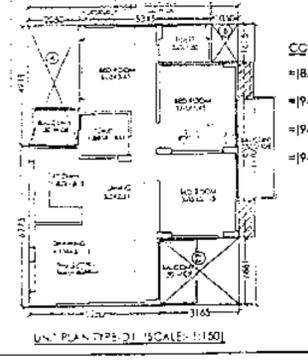


COVERED AREA DETAIL OF ONE UNIT TYPE-D1
 $= (8.415 \times 11.184) - [(A) + (B) + (C)] = 94.465$
 $- A(2.05 \times 4.911) - B(1.05 \times 1.615) + C(3.16 \times 2.661) = 94.465 - (10.067) - (1.695) + (8.422) = 94.465 - (20.34) = 74.231 \text{ SQ.M.}$

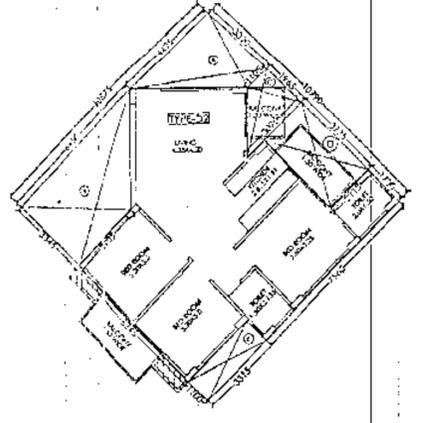


COVERED AREA DETAIL OF ONE UNIT TYPE-D2
 $= (10.5 \times 10.79) - [(A) + (B) + (C) + (D)] = 117.041$
 $- A(0.5 \times 6.45) - B(3.105 \times 3.345) - C(0.5 \times 4.425) - D(1.05 \times 3.32) = 117.041 - (3.225) - (10.395) - (1.7625) - (3.465) = 98.294 \text{ SQ.M.}$

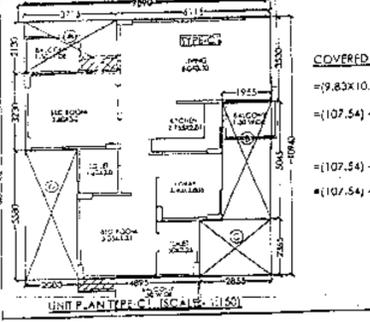

COVERED AREA DETAIL OF ONE UNIT TYPE-C1
 $= (9.83 \times 10.94) - [(A) + (B) + (C) + (D)] = 107.54$
 $- A(3.71 \times 2.13) - B(1.95 \times 0.45) + C(2.85 \times 2.365) + D(2.0 \times 0.5) = 107.54 - (7.912) - (0.8775) + (6.752) - (1.0) = 107.54 - (26.132) = 81.408 \text{ SQ.M.}$

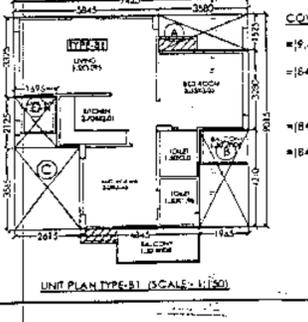

COVERED AREA DETAIL OF ONE UNIT TYPE-B1
 $= (8.425 \times 9.015) - [(A) + (B) + (C) + (D)] = 84.966$
 $- A(3.58 \times 1.52) - B(1.75 \times 4.21) + C(2.15 \times 3.565) + D(1.69 \times 2.125) = 84.966 - (5.441) - (7.3675) + (7.66125) - (3.59375) = 84.966 - (26.657) = 58.309 \text{ SQ.M.}$

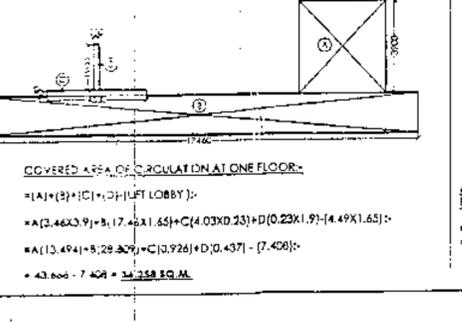

COVERED AREA OF CIRCULATION AT ONE FLOOR:-
 $= (A) + (B) + (C) + (D) + (LIFT LOBBY) = 43.600 - 7.409 = 36.191 \text{ SQ.M.}$

SIGNING AUTHORITY

Indira Singh

ARCHITECTS SIGN

M. N. Andley

M. N. ANDLEY
 B. ARCH. P.L.L. F.I.V.
 ARCHITECT CA/75/1841

SUBMISSION DRAWING

PROJECT:
 GROUP HOUSING FOR
 JNC CONSTRUCTION (P) LTD.
 PLOT NO.-1C, SECTOR-16 C AT
 GREATER NOIDA, (U.P.)

DRG. TITLE:
 TYPICAL FLOOR PLAN (BLOCK-C1 & C2)

SCALE: 1:100

DRG. NO: 11

DATE: 16/05/2014

ARCHITECTS:
 M. N. ANDLEY B. ARCH. P.L.L. F.I.V.

ANDLEYS ASSOCIATES PVT. LTD.
 ARCHITECTS ENGINEERS PLANNERS
 HOUSING SOCIETY N.D.S.E.-1 NEW DELHI - 110049

GROUP HOUSING FOR JNC CONSTRUCTION (P) LTD. PLOT NO.-1C, SECTOR-16 C AT GREATER NOIDA. (U.P.)

DATE: 18/05/2014

SCALE: 1:100


DRG. NO.: 09

DATE: 18/05/2014


ARCHITECTS: M.N. ANDLEY ARCH. F.I.A., F.V. ARCHITECTS ENGINEERS PLANNERS

PROJECT: GROUP HOUSING SOCIETY N.D.S.E.I. NEW DELHI - 110049


SCHEDULE OF DOOR & WINDOWS				
S.NO.	TYPE	SIZE	CILL. LVL.	L.T. LVL.
1	CPD-2	2.100 X 2.10	-	2.10 M.
2	VP-1	0.90 X 2.10	-	2.10
3	Gr. W	1.480 X 2.50	-	2.50 ..
4	DW-2	1.250 X 2.50	-	2.50 ..
5	W	0.90 X 1.450	1.050	2.50 ..
6	W-1	0.45 X 1.450	1.050	2.50

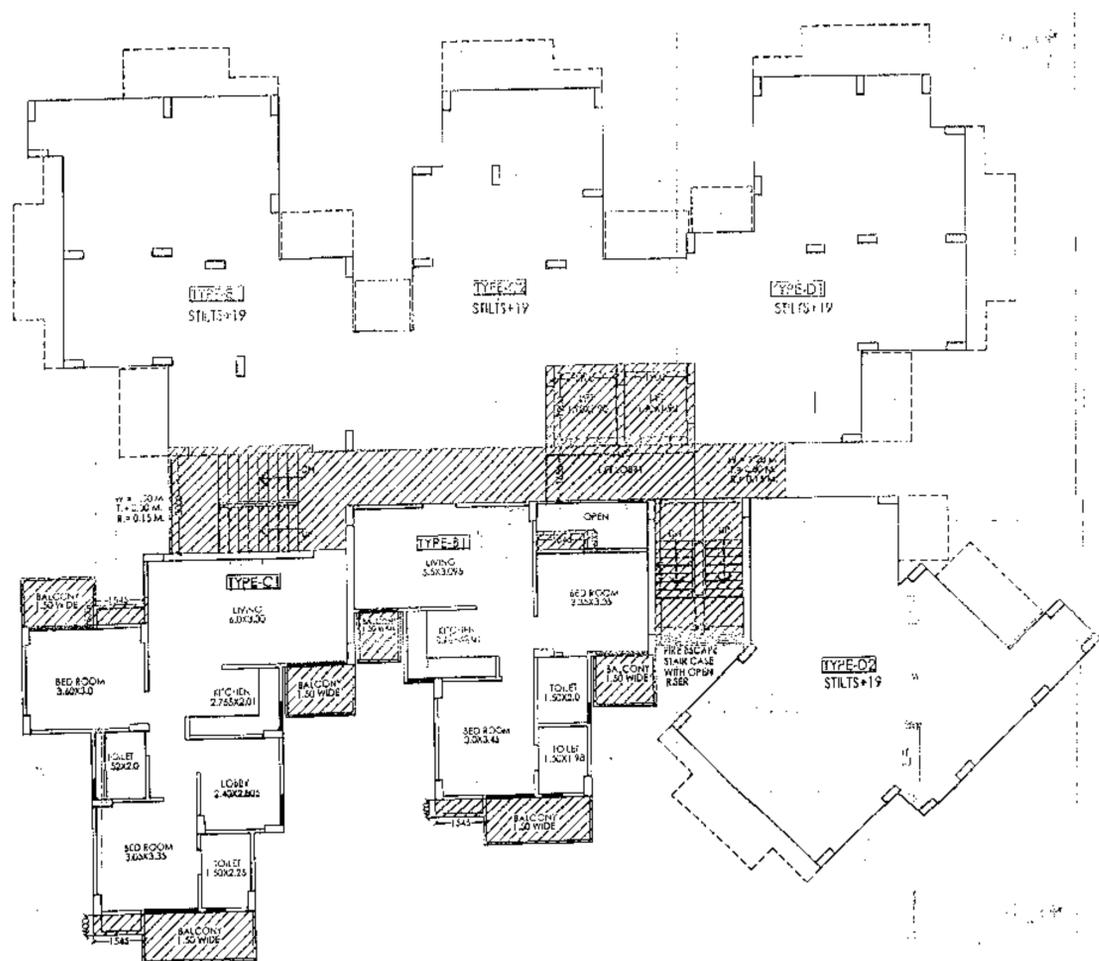

GROUND FLOOR PLAN

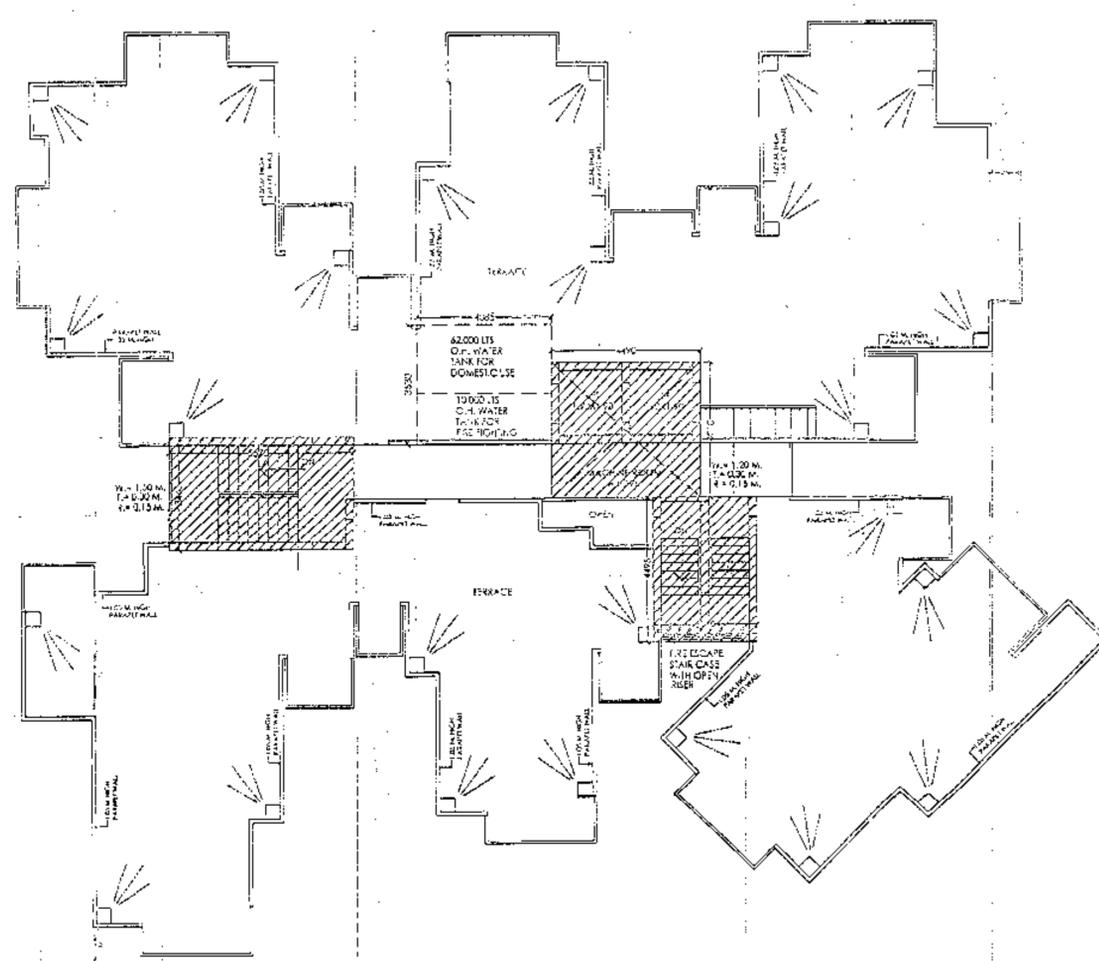


TERRACE FLOOR PLAN

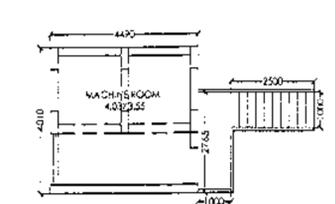

MACHINE ROOM FLOOR PLAN

AREA IN F.A.R.

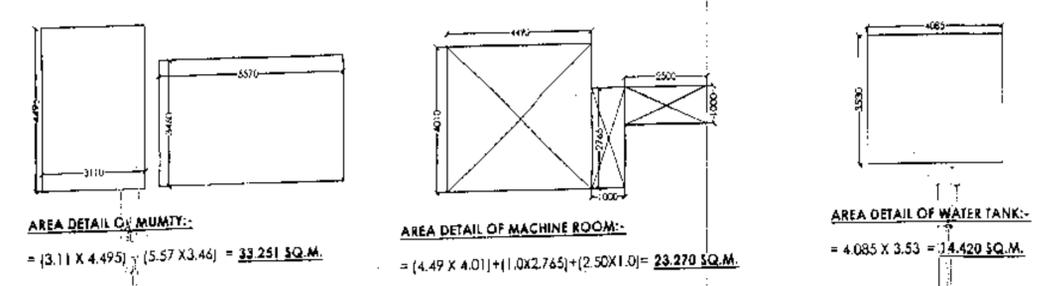

SIGNING AUTHORITY

Handwritten signature

ARCHITECTS SIGN

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B. ARCH. F.I.A., F.V.
ARCHITECT (A/75/1841)

SUBMISSION DRAWING

GROUP HOUSING FOR
JNC CONSTRUCTION (P) LTD.
PLOT NO.-1C, SECTOR-16 C AT
GREATER NOIDA. (U.P.)

DRG. TITLE

GROUND & TERRACE FLOOR PLAN (BLOCK-B* & B2)

SCALE: 1:100


DRG. NO.: 09

DATE: 18/05/2014

ARCHITECTS:

M.N. ANDLEY ARCH. F.I.A., F.V.


ANDLEYS ASSOCIATES PVT. LTD.
ARCHITECTS ENGINEERS PLANNERS
BY HOLDING SOCIETY N.D.S.E.I. NEW DELHI - 110049

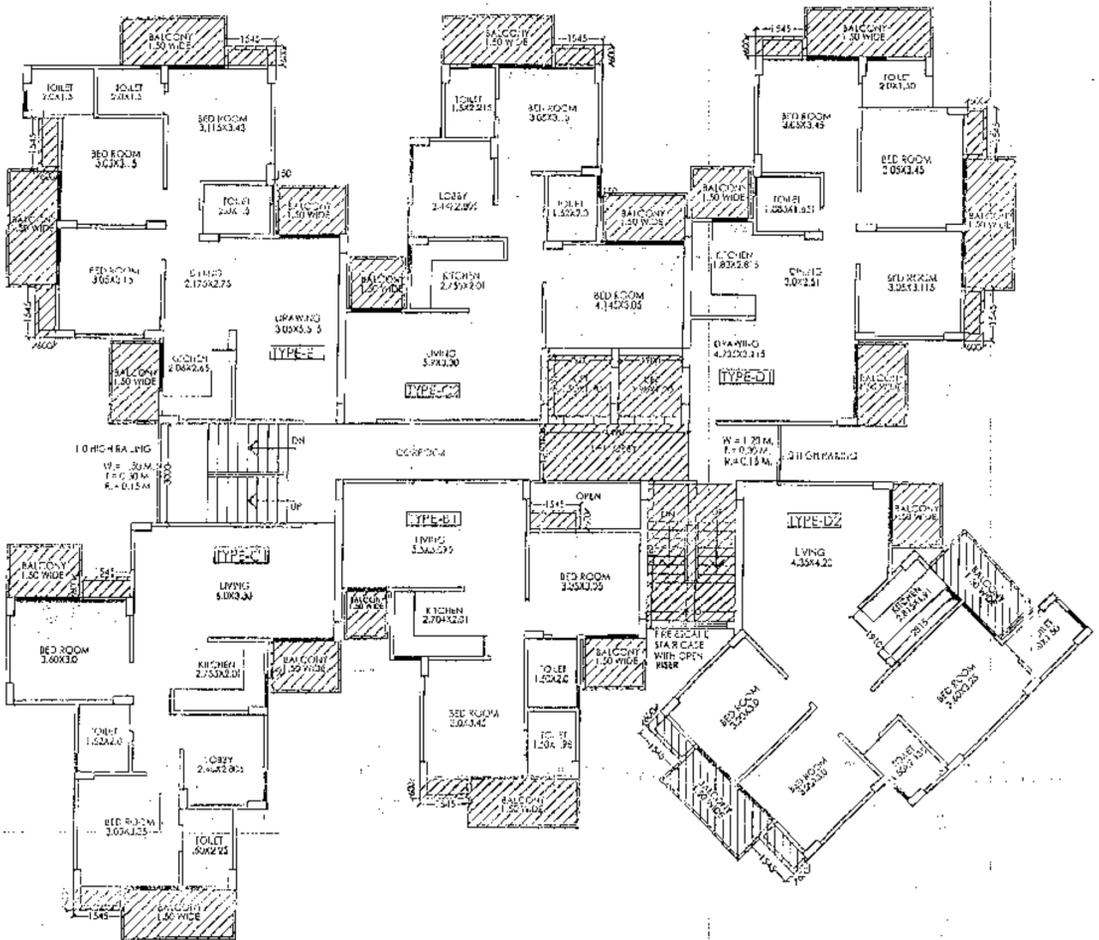

F.A.R. AREA:
COVERED AREA DETAIL ON GROUND FLOOR:-
 = (C1) x HB1 + (CIRCULATION AREA AT ONE FLOOR) + (LIFT WELL):-
 = 71.408 + 58.509 + 32.052 + 7.22
 = 168.989 SQ.M.
COVERED AREA DETAIL AT ONE FLOOR (1ST TO 19TH):-
 = (TYPE-E) + (TYPE-B1) + (TYPE-C1) + (TYPE-C2) + (TYPE-D1) + (TYPE-D2)
 + (CIRCULATION AREA AT ONE FLOOR):-
 = (77.249) + (58.309) + (71.408) + (73.025) + (74.281)
 + (76.451) + (32.052) = 442.773 SQ.M.

GROUND COVERAGE FOR ONE BLOCK:-
 = (TYPE-E) + (TYPE-B1) + (TYPE-C1) + (TYPE-C2) + (TYPE-D1) + (TYPE-D2)
 + (CIRCULATION AREA AT ONE FLOOR) + (LIFT WELL AREA) + (LIFT LOBBY)
 + (FIRE STAIRCASE) + (CUP BOARD) (E+B1+C1+C2+D1+D2):-
 = (77.249) + (58.309) + (71.408) + (73.025) + (74.281) + (76.451) + (32.052)
 + (7.22) + (7.408) + (11.911) + (2.781) + (1.854) + (0.927) + (2.781) + (1.854)
 = 501.367 SQ.M.

15% EXTRA F.A.R. AREA DETAIL ON ALL FLOOR OF BLOCK B & B2 :-
 = GROUND FLOOR + 1ST FLOOR TO 19TH FLOOR + MUMINTY +
 MACHINE ROOM + WATER TANK
 = 23.027 + (1.37 x 19) + 33.251 + 23.270 - 14.420
 = 489.998 SQ.M.

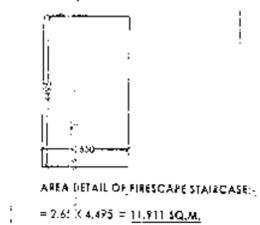

AREA DETAIL OF FIRE ESCAPE STAIRCASE:-
 = 2.65 X 4.495 = 11.911 SQ.M.

15% EXTRA F.A.R. AREA CALCULATION FOR BLOCK B1:-
AREA DETAIL OF FIRE ESCAPE STAIRCASE:-
 = 2.65 X 4.495 = 11.911 SQ.M.
AREA DETAIL OF MUMINTY:-
 = (3.11 X 4.495) + (5.57 X 3.46) = 33.251 SQ.M.
AREA DETAIL OF MACHINE ROOM:-
 = (4.49 X 4.01) - (1.0 X 2.785) + (2.50 X 1.01) = 23.270 SQ.M.
AREA DETAIL OF WATER TANK:-
 = 4.085 X 3.53 = 14.420 SQ.M.

CUPBOARD AREA DETAIL FOR ONE UNIT TYPE-E
 (1.545 X 0.6X3) = 2.781 SQ.M.
CUPBOARD AREA DETAIL FOR ONE UNIT TYPE-B1
 (1.545 X 0.60X2) = 1.854 SQ.M.
CUPBOARD AREA DETAIL FOR ONE UNIT TYPE-C1
 (1.545 X 0.60X2) = 1.854 SQ.M.
CUPBOARD AREA DETAIL FOR ONE UNIT TYPE-C2
 (1.545 X 0.6) = 0.927 SQ.M.
CUPBOARD AREA DETAIL FOR ONE UNIT TYPE-D1
 (1.545 X 0.60X3) = 2.781 SQ.M.
CUPBOARD AREA DETAIL FOR ONE UNIT TYPE-D2
 (1.545 X 0.6X2) = 1.854 SQ.M.


DETAIL OF LIFT WELL AREA:-
 (1.90 X 1.90X2) = 7.22 SQ.M.
DETAIL OF LIFT LOBBY AREA:-
 4.49 X 1.65 = 7.408 SQ.M.

15% EXTRA FAR AREA DETAIL ON GROUND FLOOR :-
 = FIRE ESCAPE STAIR + LIFT LOBBY + CUP BOARD (B1+C1):-
 = 11.911 + 7.408 + 1.854 + 1.854 = 23.027 SQ.M.


15% EXTRA FAR AREA DETAIL AT ONE FLOOR (1ST TO 19TH) :-
 = FIRE ESCAPE STAIR + CUP BOARD (E+B1+C1+C2+D1+D2) + LIFT LOBBY:-
 = (11.911 + 2.781) + 1.854 + 1.854 + 0.927 + 2.781 + 1.854 + 7.408 = 31.37 SQ.M.

SCHEDULE OF DOOR & WINDOWS


S.NO	TYPE	SIZE	CL. LVL.	CTL. LVL.
1	D	1.100 X 2.10	-	2.10 M.
2	D	0.90 X 2.10	-	2.10
3	D	0.80 X 2.50	-	2.50 ..
4	DW-2	1.250 X 2.50	-	2.50 ..
5	W	0.90 X 1.450	1.050	2.50 ..
6	W-1	0.45 X 1.450	1.050	2.50

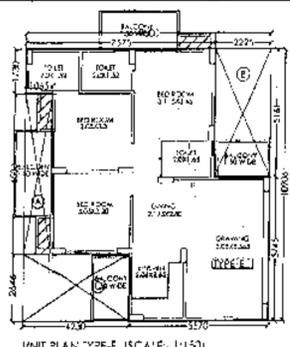


COVERED AREA DETAIL OF ONE UNIT TYPE-E
 = (9.80 X 10.906) - [(A) + (B) + (C)]
 = (106.878) - A(1.045 X 6.50) - B(2.275 X 1.61) + C(4.23 X 2.64)
 = (106.878) - A(6.954) - B(11.483) + C(11.192)
 = (106.878) - (29.629) = 77.249 SQ.M.

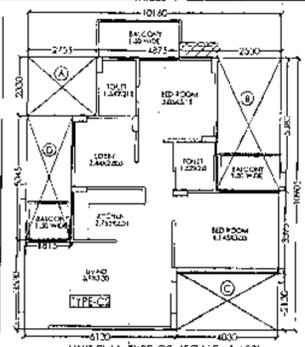


COVERED AREA DETAIL OF ONE UNIT TYPE-C2
 = (10.16 X 10.905) - [(A) + (B) + (C) + (D)]
 = (110.794) - A(2.755 X 2.33) - B(2.53 X 5.26) + C(4.03 X 2.13)
 + D(1.815 X 0.45)
 = (110.794) - A(6.419) - B(13.611) + C(8.583) + D(0.827)
 = (110.794) - (37.769) = 73.025 SQ.M.

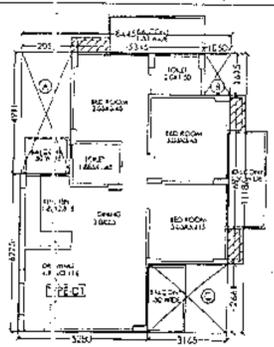


COVERED AREA DETAIL OF ONE UNIT TYPE-D1
 = (8.445 X 11.186) - [(A) + (B) + (C)]
 = (94.462) - A(2.05 X 4.91) - B(1.05 X 1.615) - C(3.165 X 2.66)
 = (94.462) - A(10.047) - B(1.695) - C(8.422)
 = (94.462) - (20.184) = 74.281 SQ.M.

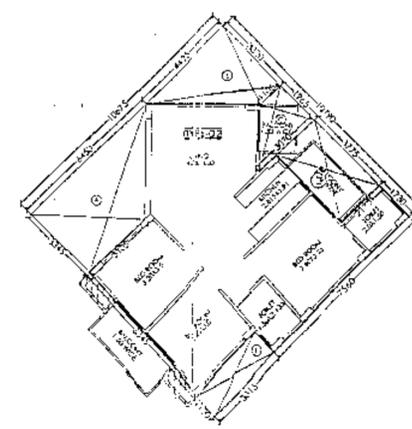


COVERED AREA DETAIL OF ONE UNIT TYPE-D2
 = (10.875 X 10.79) - [(A) + (B) + (C) + (D) + (E)]
 = (117.341) - A(0.5 X 16.45) - B(1.05 X 3.345) - C(0.5 X 4.42) - D(1.105 X 3.32)
 + E(0.5 X 1.105 + 3.07 X 1.965) + D(2.115 X 3.77)
 + C(3.315 X 1.13)
 = (117.341) - A(8.225) - B(3.527) - C(1.761) - D(3.661) + D(7.984) + E(3.646)
 = (117.341) - (14.091) = 103.250 SQ.M.

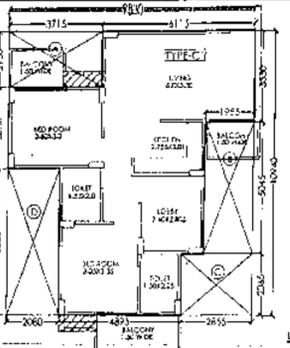

COVERED AREA DETAIL OF ONE UNIT TYPE-C1
 = (9.83 X 10.94) - [(A) + (B) + (C) + (D)]
 = (107.54) - A(3.715 X 2.13) - B(1.955 X 0.445) + C(2.855 X 2.35)
 + D(2.08 X 5.58)
 = (107.54) - A(7.912) - B(0.862) + C(6.752) + D(11.606)
 = (107.54) - (36.132) = 71.408 SQ.M.

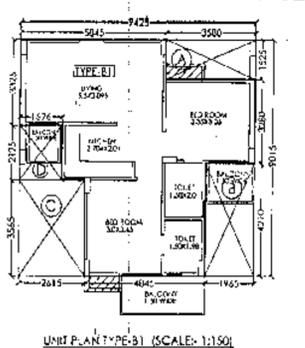

COVERED AREA DETAIL OF ONE UNIT TYPE-B1
 = (9.425 X 9.015) - [(A) + (B) + (C) + (D)]
 = (84.966) - A(3.58 X 1.525) - B(1.965 X 4.21) - C(2.615 X 3.365)
 + D(1.69 X 2.125)
 = (84.966) - A(5.459) - B(8.272) - C(8.822) - D(3.604)
 = (84.966) - (26.657) = 58.309 SQ.M.

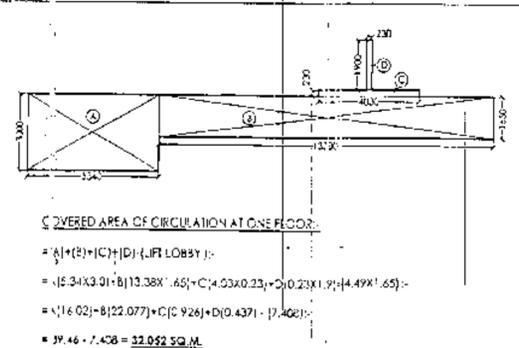

COVERED AREA OF CIRCULATION AT ONE FLOOR:-
 = (A) + (B) + (C) + (D) + (LIFT LOBBY):-
 = (1.815 X 0.45) + (1.038 X 1.45) + (0.53 X 0.23) + (0.23 X 1.91) + (4.49 X 1.65)
 = (1.602) + (1.22077) + (0.1219) + (0.437) + (7.408)
 = 9.767 + 7.408 = 17.175 SQ.M.

SIGNING AUTHORITY

Indu Rani

ARCHITECT'S SIGN

M. N. Andley
 M. N. ANDLEY
 B. ARCH. F.I.I.A., F.I.V.
 ARCHITECT CA/175/1841

SUBMISSION DRAWING

PROJECT:

GROUP HOUSING FOR JNC CONSTRUCTION (P) LTD. PLOT NO.-1C, SECTOR-16 C AT GREATER NOIDA. (U.P.)

ORG. TITLE:

TYPICAL FLOOR PLAN (BLOCK- B1 & B2)


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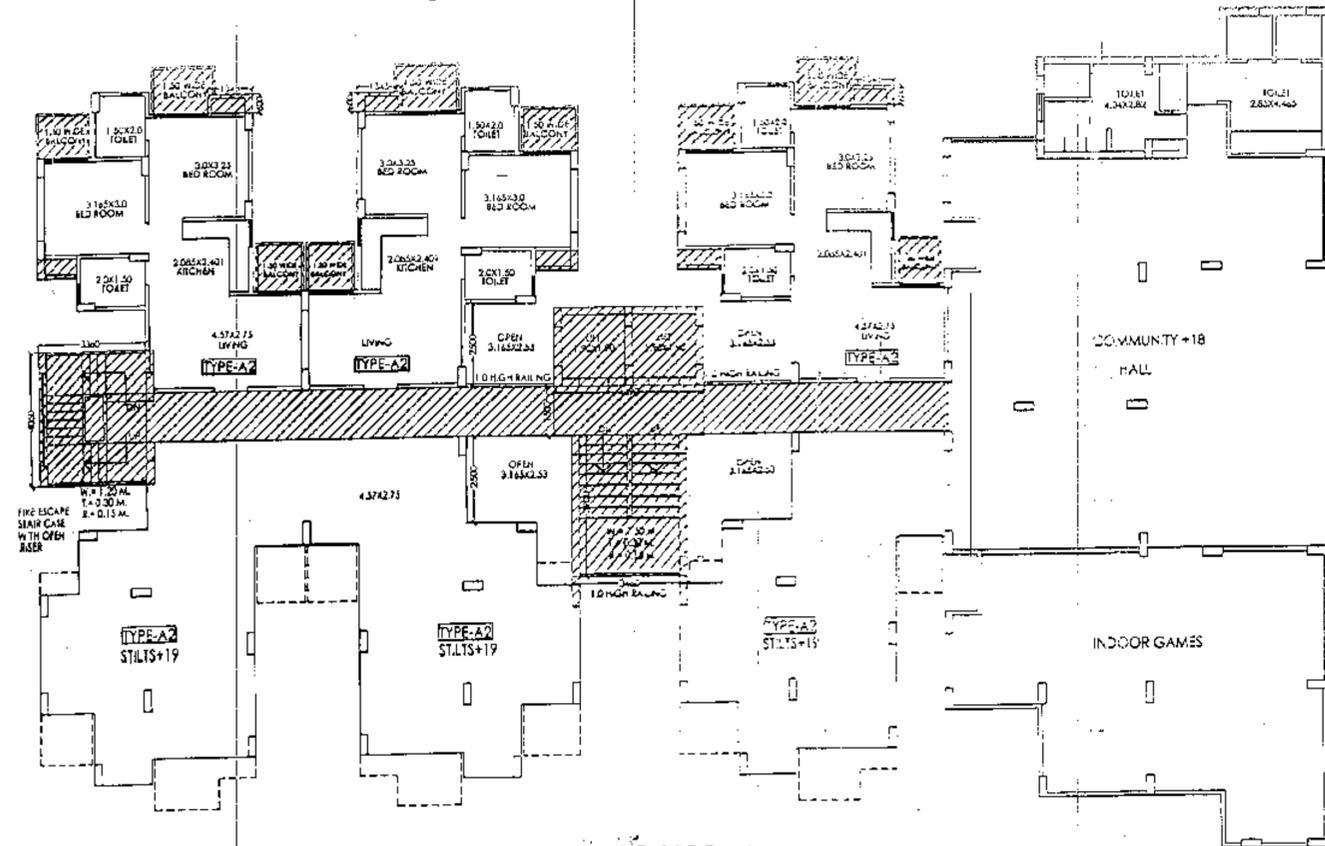
D.T. BY: DATE: 18/06/2014

ARCHITECTS:

M. N. ANDLEY B. ARCH. F.I.I.A., F.I.V.
ANDLEYS ASSOCIATES PVT. LTD.
 ARCHITECTS ENGINEERS PLANNERS
 57 HOUSING SOCIETY N.C.S.E.I. NEW DELHI - 110049



FIRST FLOOR PLAN

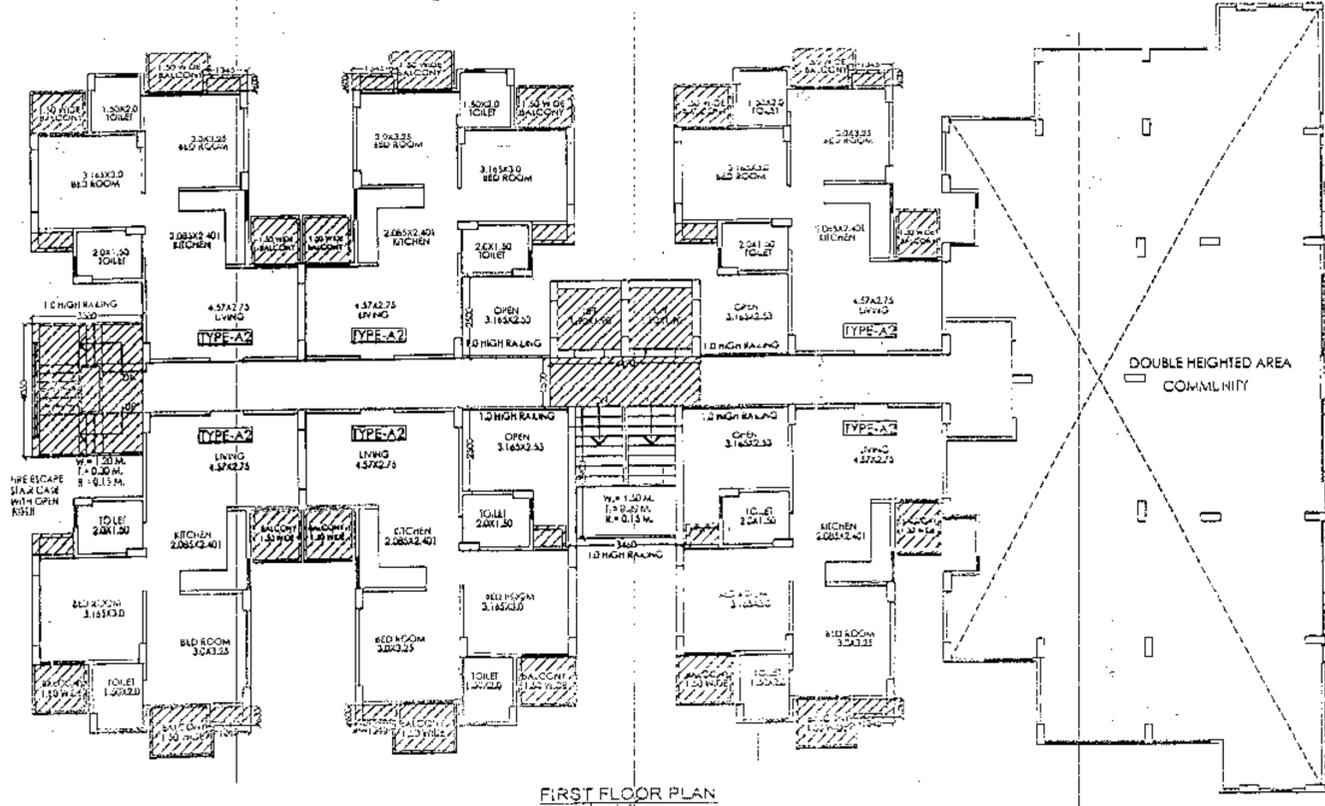

GROUND FLOOR PLAN

AREA IN F.A.R.

Greater Noida Development Authority
 APPROVED
 Date: 08/05/2014

SCHEDULE OF DOOR & WINDOWS

S.NO.	TYPE	CL. LVL.	LTL. LVL.
1	D-1	1.050	2.10 M.
2	D-1	0.90 X 2.10	2.10
3	D-1	1.65 X 2.60	2.50
4	D-1	1.250 X 2.50	2.50
5	W	0.90 X 1.450	1.050 2.50
6	W-1	0.45 X 1.450	1.050 2.50

ISSUING AUTHORITY

Indira Singh

ARCHITECT'S SIGN

M. N. Andley
 M. N. ANDLEY
 B. ARCH. (I.I.I.T.), F.I.V.
 ARCHITECT CA/75/1841

SUBMISSION DRAWING



PROJECT:-
 GROUP HOUSING FOR
 JNC CONSTRUCTION (P) LTD.
 PLOT NO.-1C, SECTOR-16 C AT
 GREATER NOIDA. (U.P.)

DRG. TITLE:-
 GROUND & FIRST FLOOR PLAN (BLOCK- A1 & A2)


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DATE:- 08/05/2014


ARCHITECTS:-
 M. N. ANDLEY B. ARCH. (I.I.I.T.), F.I.V.
 ANDLEYS ASSOCIATES PVT. LTD.
 ARCHITECTS ENGINEERS PLANNERS
 37 HOUSING SOCIETY N.D.S.E.I. NEW DELHI - 110049

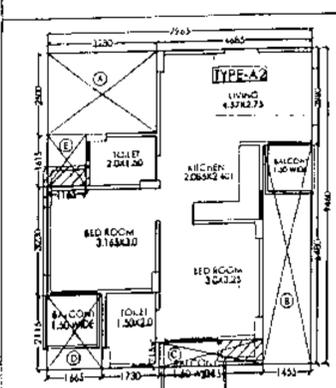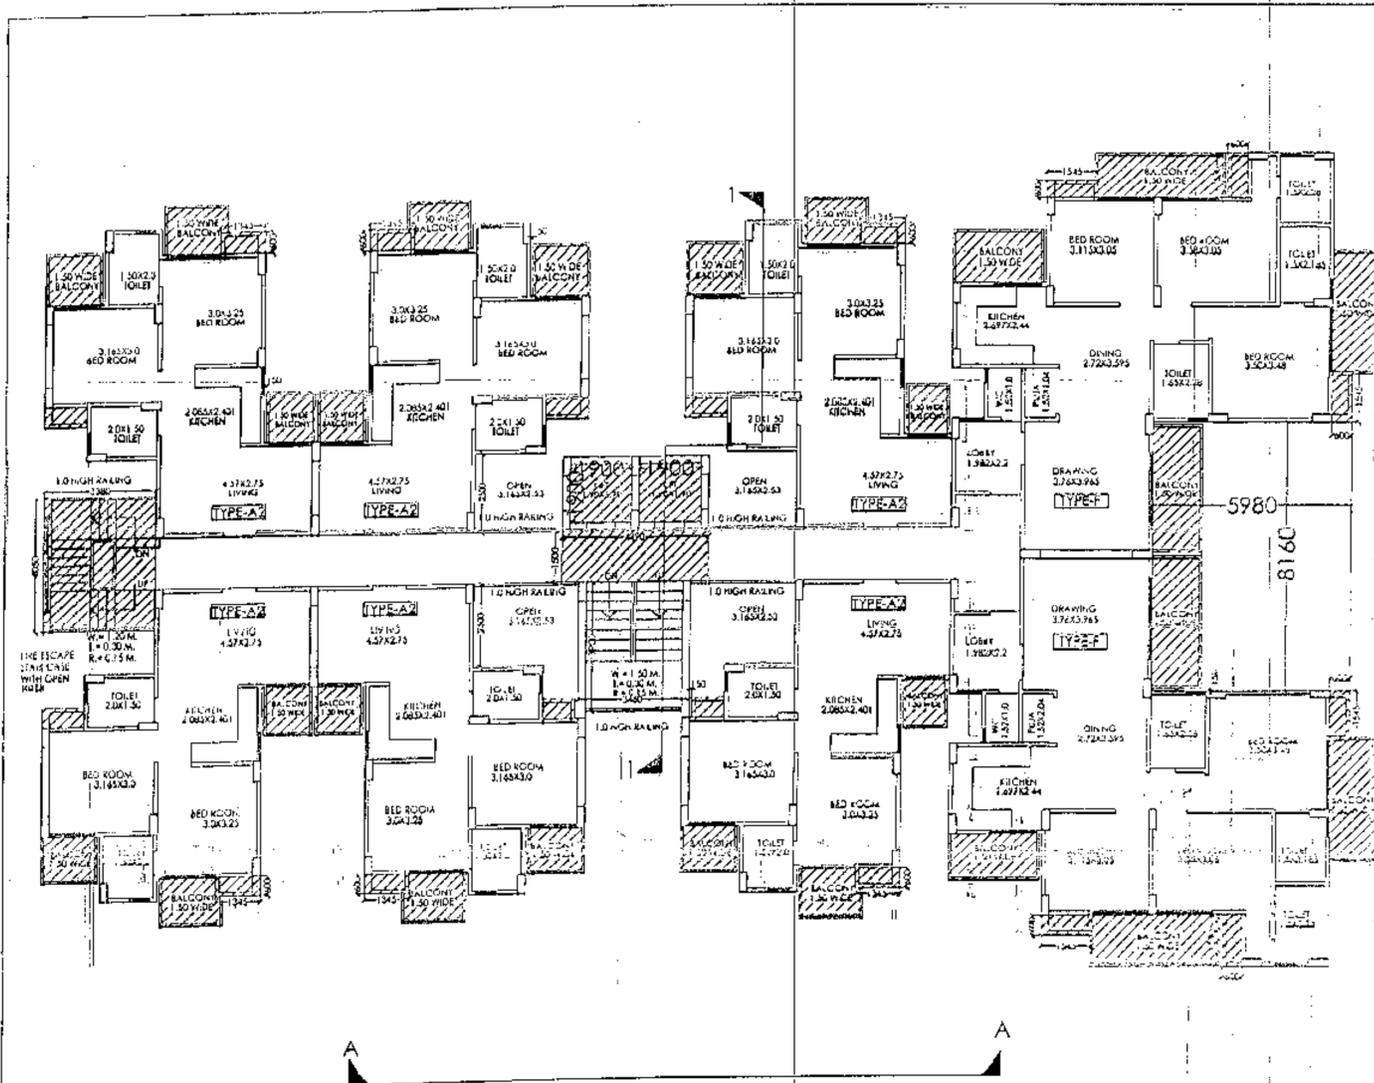

UNIT PLAN TYPE-A2 (SCALE: 1:100)
COVERED AREA DETAIL OF ONE UNIT TYPE-A2
 = (7.965 X 9.46) - [(A)+(B)+(C)+(D)+(E)]
 = (75.348) - A(3.28 X 2.50) + B(1.455 X 6.48) + C(3.115 X 0.715)
 + D(1.665 X 2.115) + E(1.165 X 1.615)
 = (75.348) - A(8.2) + B(9.428) + C(2.227) + D(3.521) + E(1.881)
 = (75.348) - (25.257) = **50.091 SQ.M.**

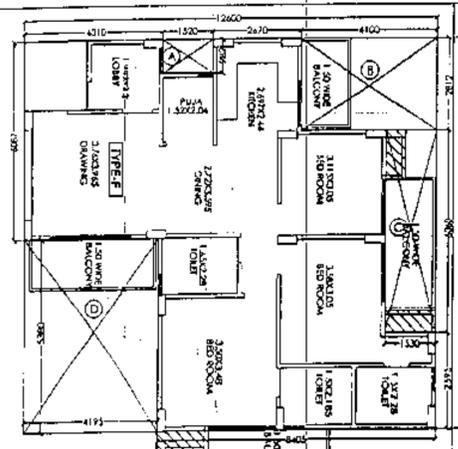

UNIT PLAN TYPE-F (SCALE: 1:150)
COVERED AREA DETAIL OF ONE UNIT TYPE-F
 = (12.60 X 11.467) - [(A)+(B)+(C)+(D)]
 = (144.484) - A(1.52 X 0.532) + B(4.10 X 2.812) + C(1.53 X 6.04) + D(1.95 X 3.36)
 = (144.484) - A(0.809) + B(11.529) + C(9.271) + D(6.569)
 = (144.484) - (14.661) = **129.823 SQ.M.**

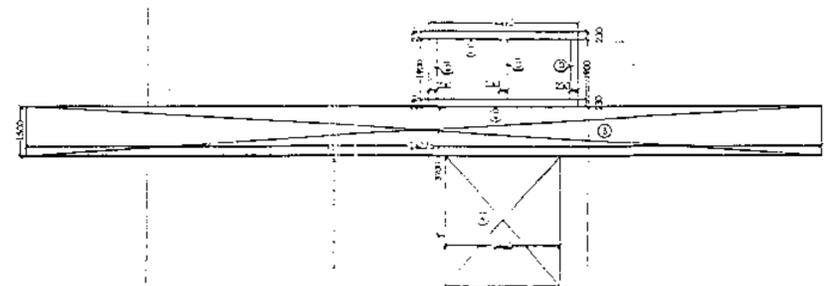

CIRCULATION AREA AT ONE FLOOR (SCALE: 1:100)
COVERED AREA OF CIRCULATION AT ONE FLOOR:-
 = (A)+(B)+(C)+(D)-(LIFT LOBBY):-
 = A(3.46 X 3.90) + B(24.075 X 1.50) + C(4.49 X 0.6 X 2) + D(0.22 X 1.5 X 2) + (4.49 X 1.5)
 = A(13.494) + B(36.112) + C(5.388) + D(0.66) + (6.735)
 = 52.982 - 6.735 = **46.247 SQ.M.**

F.A.R. AREA:-
COVERED AREA DETAIL ON GROUND FLOOR:-
 = (A2X3) + (CIRCULATION AREA AT ONE FLOOR) + (LIFT WELLS):-
 = (50.091 X 3) + (46.247) + (7.22) = 150.273 + 46.247 + 7.22
 = **203.74 SQ.M.**
COVERED AREA DETAIL ON FIRST FLOOR:-
 = (LOBBY AREA = TYPE-FX2)
 + (TYPE-A2X6) + (CIRCULATION AREA AT ONE FLOOR):-
 = (99.623 X 2) + (50.091 X 6) + (46.247)
 = (199.246) + (300.546) + (46.247) = **546.039 SQ.M.**
COVERED AREA DETAIL AT ONE FLOOR (2ND TO 19TH):-
 = (TYPE-FX2) + (TYPE-A2X6) + (CIRCULATION AREA AT ONE FLOOR):-
 = (99.623 X 2) + (50.091 X 6) + (46.247)
 = (199.246) + (300.546) + (46.247) = **546.039 SQ.M.**
GROUND COVERAGE FOR ONE BLOCK:-
 = (TYPE-FX2) + (TYPE-A2X6) + (CIRCULATION AREA AT ONE FLOOR)
 + (LIFT WELL AREA) + (UP LOBBY) + (FIRE STAIRCASE) + (CUPBOARD) + (A2X6) + (FX2)
 + (COMMUNITY):-
 = (99.623 X 2) + (50.091 X 6) + (46.247) + (1.90 X 1.90 X 2) + (6.735) + (13.689)
 = (199.246) + (300.546) + (46.247) + (7.22) + (13.689) = **637.473 SQ.M.**
DETAIL OF LIFT WELL AREA:-
 (1.90 X 1.90 X 2) = **7.22 SQ.M.**

15% EXTRA F.A.R. AREA CALCULATION FOR BLOCK A1:-
AREA DETAIL OF FIRESCAPE STAIRCASE:-
 = 4.05 X 3.38 = **13.689 SQ.M.**
AREA DETAIL OF MUMTY:-
 = (4.05 X 3.38) + (3.46 X 3.9) = **27.183 SQ.M.**
AREA DETAIL OF MACHINE ROOM:-
 = (4.49 X 3.86) + (3.46 X 3.90) = **30.825 SQ.M.**
AREA DETAIL OF WATER TANK:-
 = 4.175 X 2.98 = **12.442 SQ.M.**
CUPBOARD AREA DETAIL FOR ONE UNIT TYPE-F
 (1.545 X 0.6 X 2) + (1.53 X 6) = **2.772 SQ.M.**
CUPBOARD AREA DETAIL FOR ONE UNIT TYPE-A2
 (1.345 X 0.6) + (1.28 X 0.60) = **1.575 SQ.M.**
DETAIL OF LIFT LOBBY AREA:-
 4.49 X 1.5 = **6.735 SQ.M.**
15% EXTRA FAR AREA DETAIL ON GROUND FLOOR:-
 = (FIRESCAPE STAIR + LIFT LOBBY + CUP BOARD) (A2X3):-
 = 13.689 + 6.735 + (1.575 X 3) = **25.149 SQ.M.**
15% EXTRA FAR AREA DETAIL ON 1ST FLOOR:-
 = (FIRESCAPE STAIR + CUP BOARD) (A2X6) + (LIFT LOBBY):-
 = 13.689 + (1.575 X 6) + 6.735 = **28.874 SQ.M.**
15% EXTRA FAR AREA DETAIL ON ONE FLOOR (2ND TO 19TH):-
 = (FIRESCAPE STAIR + CUP BOARD) (A2X6) + (LIFT LOBBY):-
 = 13.689 + (1.575 X 6) + 6.735 = **35.418 SQ.M.**
15% EXTRA FAR AREA DETAIL ON ALL FLOORS OF BLOCK A1:-
 = GROUND FLOOR + 1ST FLOOR + 2ND TO 19TH FLOOR + MUMTY
 + MACHINE ROOM + WATER TANK
 = 25.149 + 28.874 + (35.418 X 18) + 27.183 + 30.825 + 12.442
 = **761.997 SQ.M.**

Greater Noida District Dev. Authority
 Greater Noida, U.P. 201304
 SCHEDULE OF DOOR & WINDOWS

S. NO.	TYPE	SIZE	MTL. LV.	LTL. LV.
1	DOOR	1.00 X 2.10	2.10 M.	
2	DOOR	1.00 X 2.10	2.10	
3	DOOR	1.680 X 2.50	2.50	
4	DOOR	1.250 X 2.50	2.50	
5	W	0.90 X 1.450	1.050	2.50
6	W-1	0.45 X 1.450	1.050	2.50

SIGNING AUTHORITY

Jitendra Ranji

ARCHITECT'S SIGN

M. N. Andley

M. N. ANDLEY
 8 ARCH. P.L.L.A. F.I.V.
 ARCHITECT CA/73/1261

SUBMISSION DRAWING







PROJECT:-
GROUP HOUSING FOR JNC CONSTRUCTION (P) LTD. PLOT NO.-1C, SECTOR-16 C AT GREATER NOIDA. (U.P.)

DRG. TITLE:-
TYPICAL FLOOR PLAN (BLOCK-A1 & A2)

SCALE:- 1:50

DATE:- 18/05/2014

ARCHITECTS:-
 M.N. ANDLEY BARCH. P.L.L.A. F.I.V.
ANDLEYS ASSOCIATES PVT. LTD.
 ARCHITECTS ENGINEERS PLANNERS
 OF HOUSING SOCIETY N.D.S.E. NEW DELHI - 110049

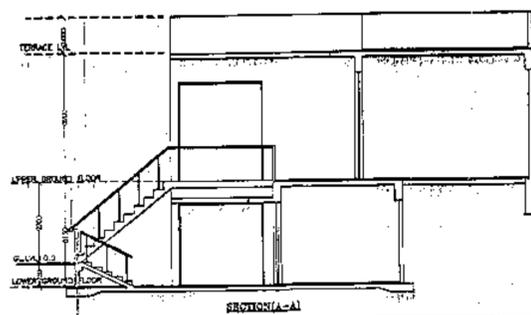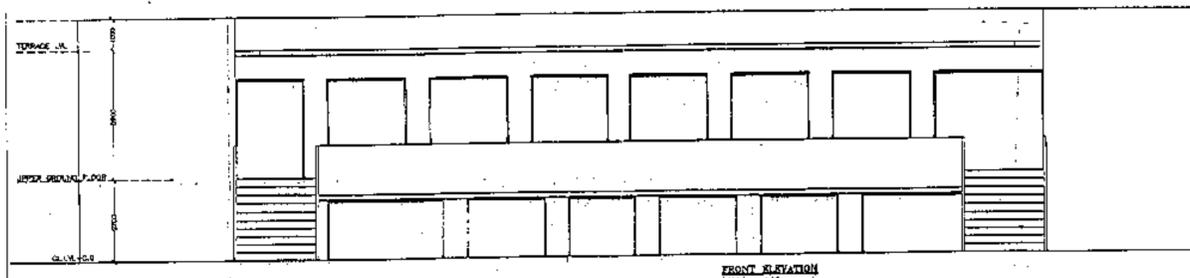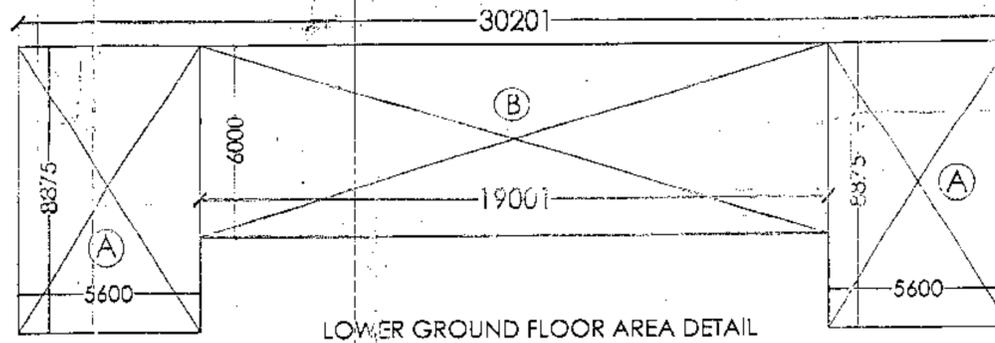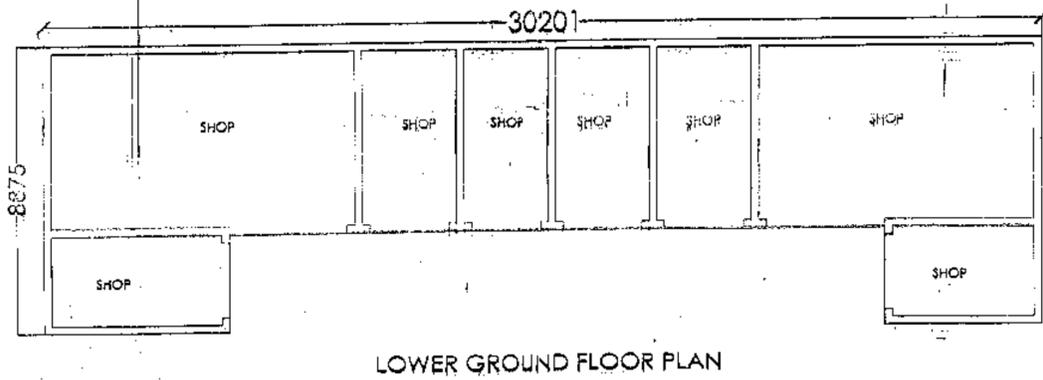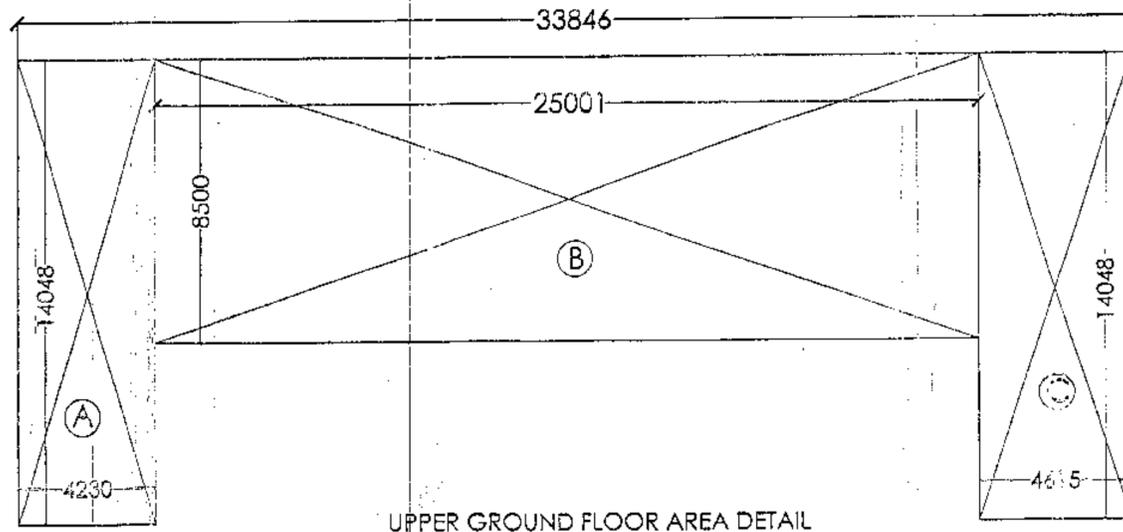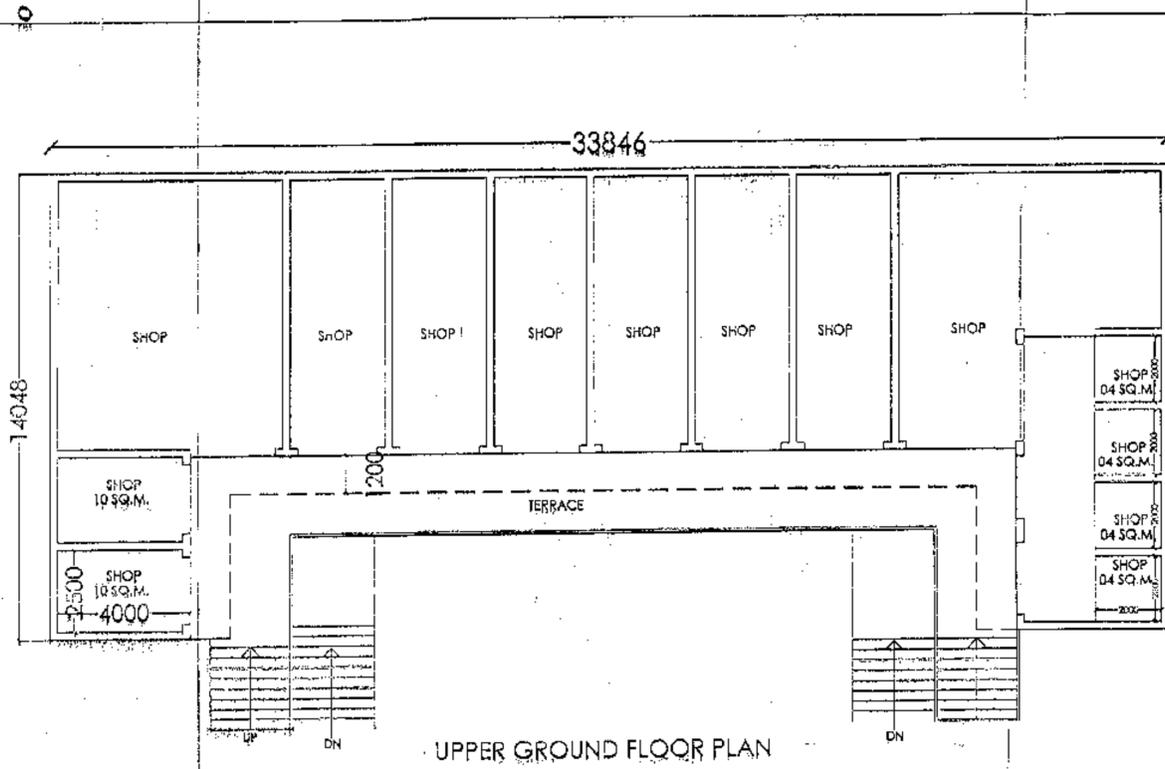

COVERED AREA DETAIL OF COMMERCIAL AT UPPER GROUND

FLOOR:-
 = [(A)+(B)+(C)]
 = [(4.23x14.048)+(25.001x8.50)+(4.615x14.048)]
 = [(59.423)+(212.508)+(64.831)]
 = 336.762 SQ.M.

COVERED AREA DETAIL OF COMMERCIAL AT LOWER GROUND

FLOOR:-
 = [(Ax2)+(B)]
 = [5.60x8.875x2)+(19.001x6.0)]
 = [(99.40)+(114.006)]
 = 213.406 SQ.M.

TOTAL FAR AREA COVERED FOR COMMERCIAL-

= 336.762 + 213.406 SQ.M.
 = 550.168 SQ.M.

Checked by	Approved by
Drawn by	Checked by
Project Manager	Project Engineer
Client Name	Client Address

SIGNING AUTHORITY

Johnston Pugh

ARCHITECT'S SIGN

M. N. Andley
 M. N. ANDLEY
 B. ARCH. F.I.I.A., F.I.M.
 ARCHITECT CA/76/1841

SUBMISSION DRAWING

PROJECT:-
**GROUP HOUSING FOR
 JNC CONSTRUCTION (P) LTD.
 PLOT NO.-1C, SECTOR-16 C AT
 GREATER NOIDA. (U.P.)**

DRG. FILE:-
 FLOOR PLANS, ELEVATION & SECTION (COMMERCIAL)

SCALE: 1:100
 DRG. NO.: 17

CITY:-
 DATE: 18/05/2014

ARCHITECTS:-
 M. N. ANDLEY B. ARCH. F.I.I.A., F.I.M.
ANDLEYS ASSOCIATES PVT. LTD.
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 39 HOUSING SOCIETY D.S.E.-1 NEW DELHI - 110049