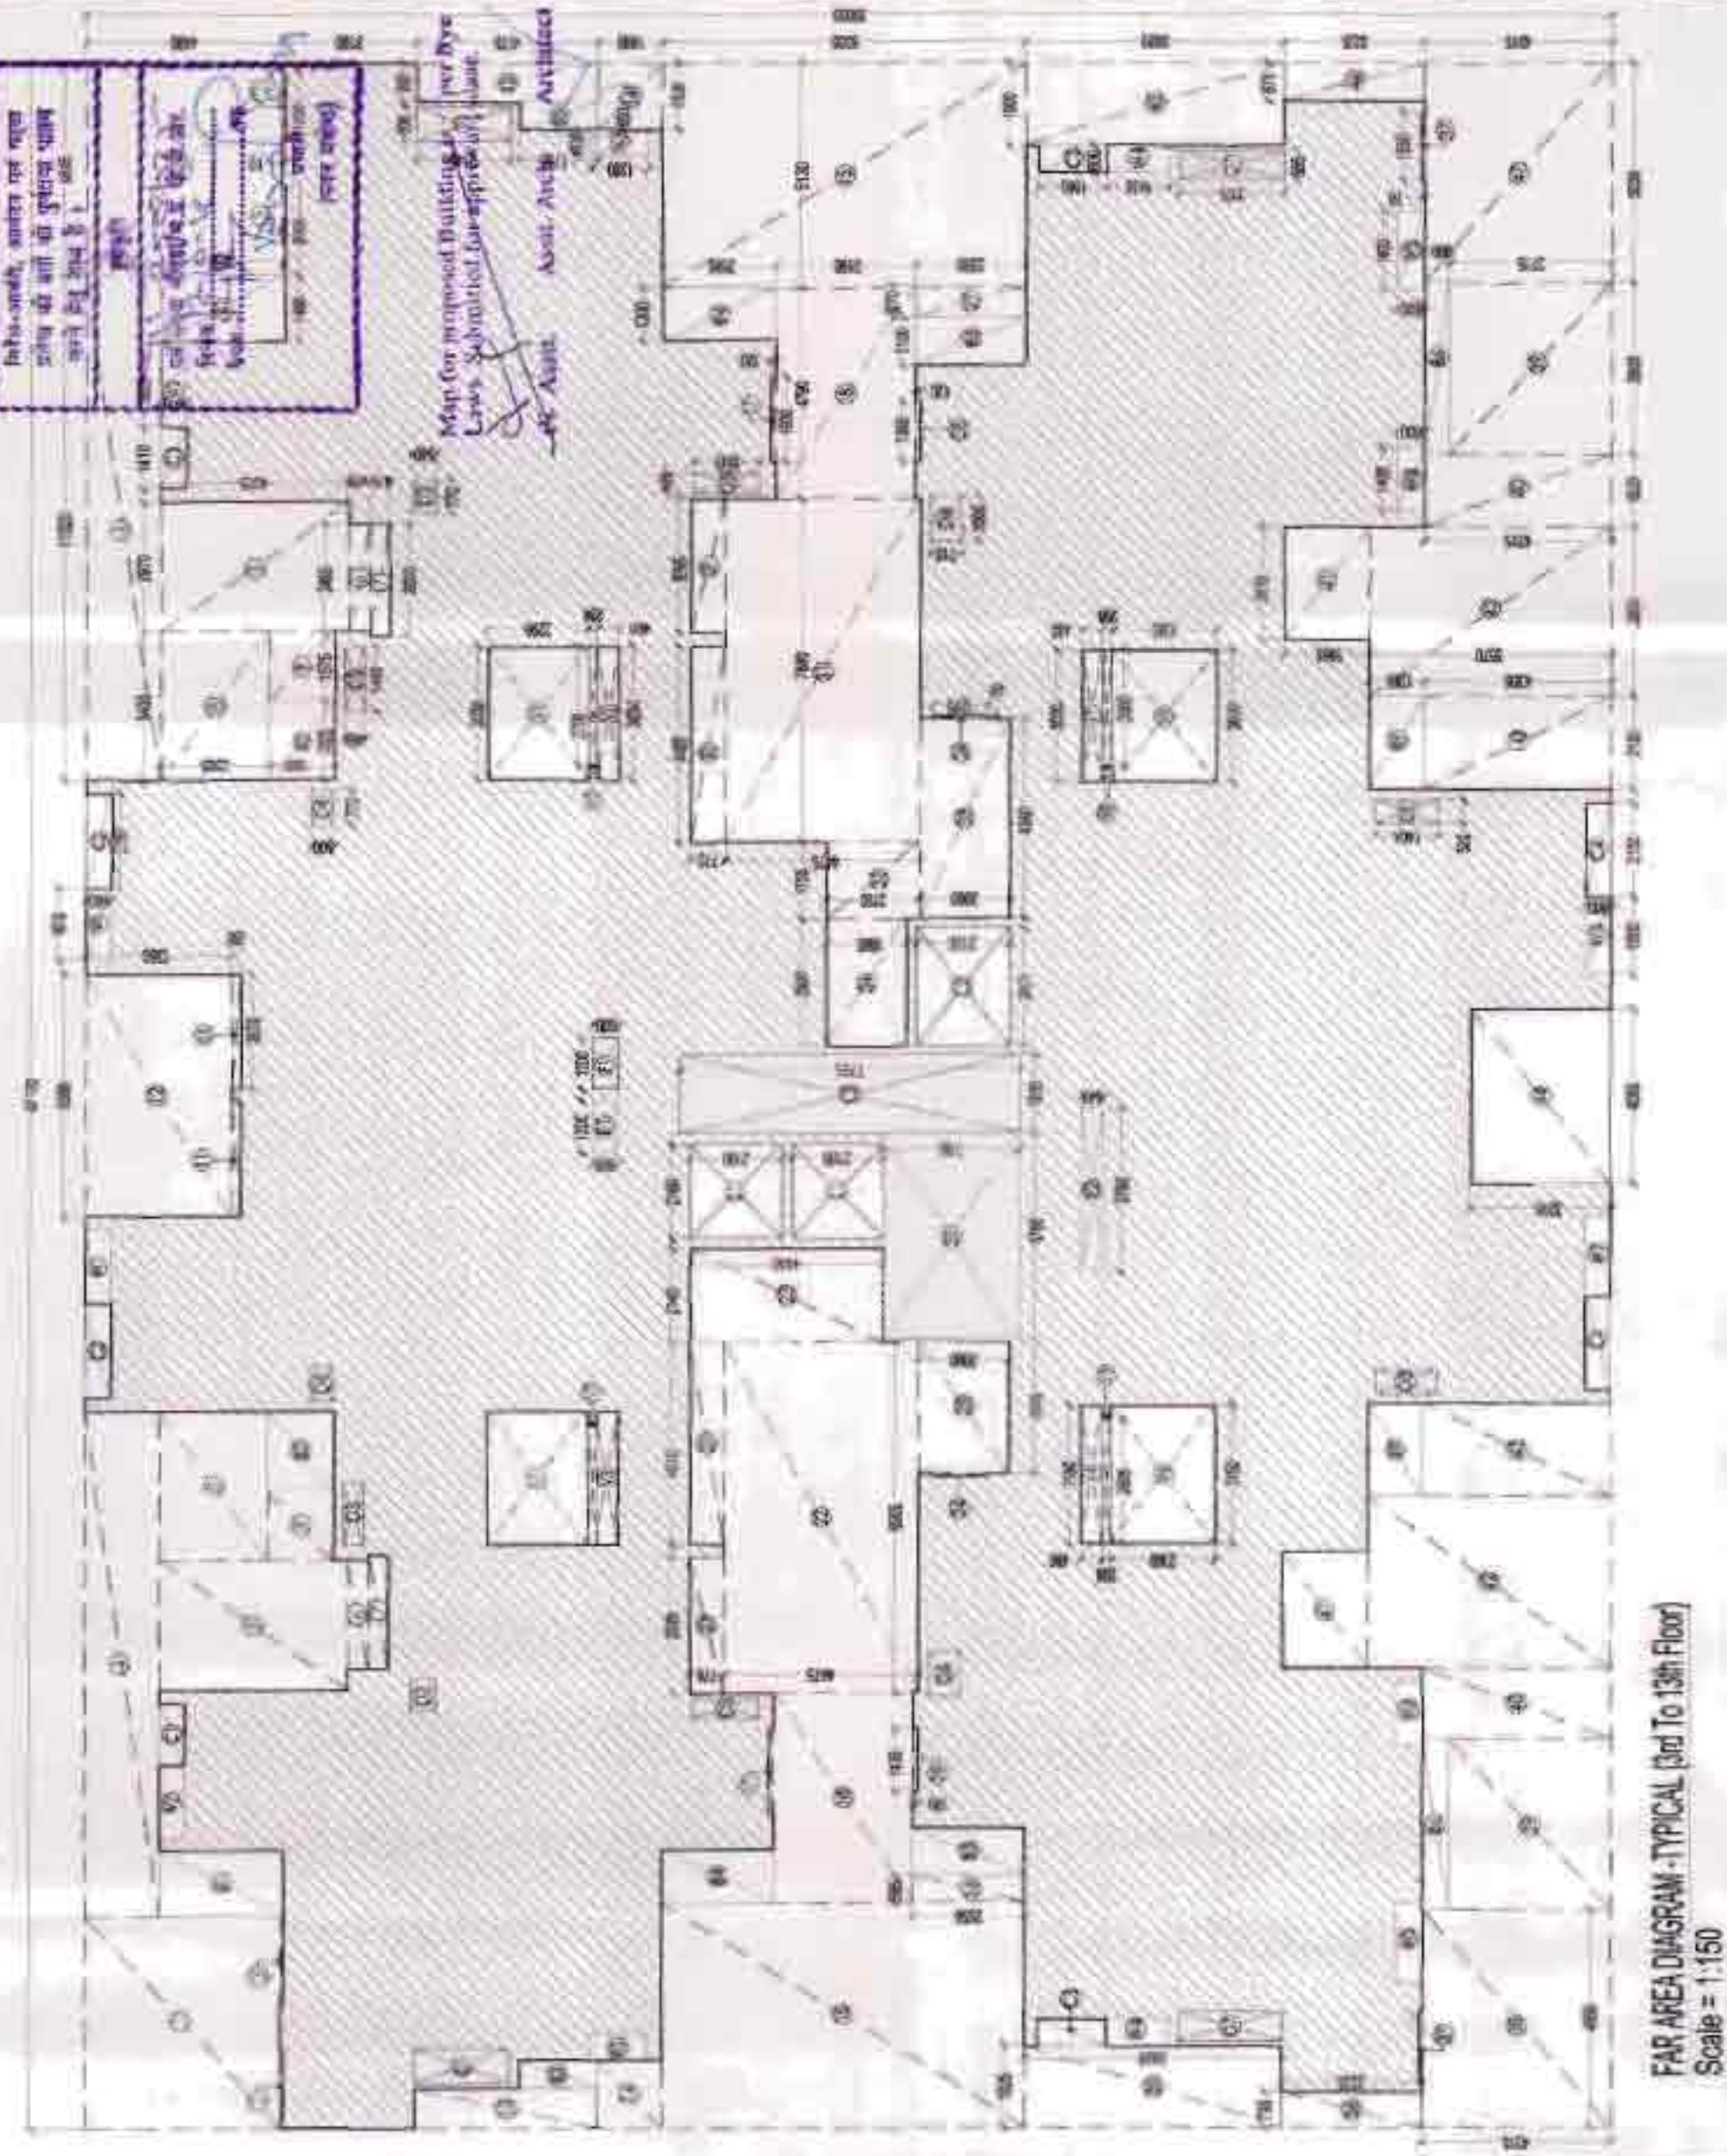
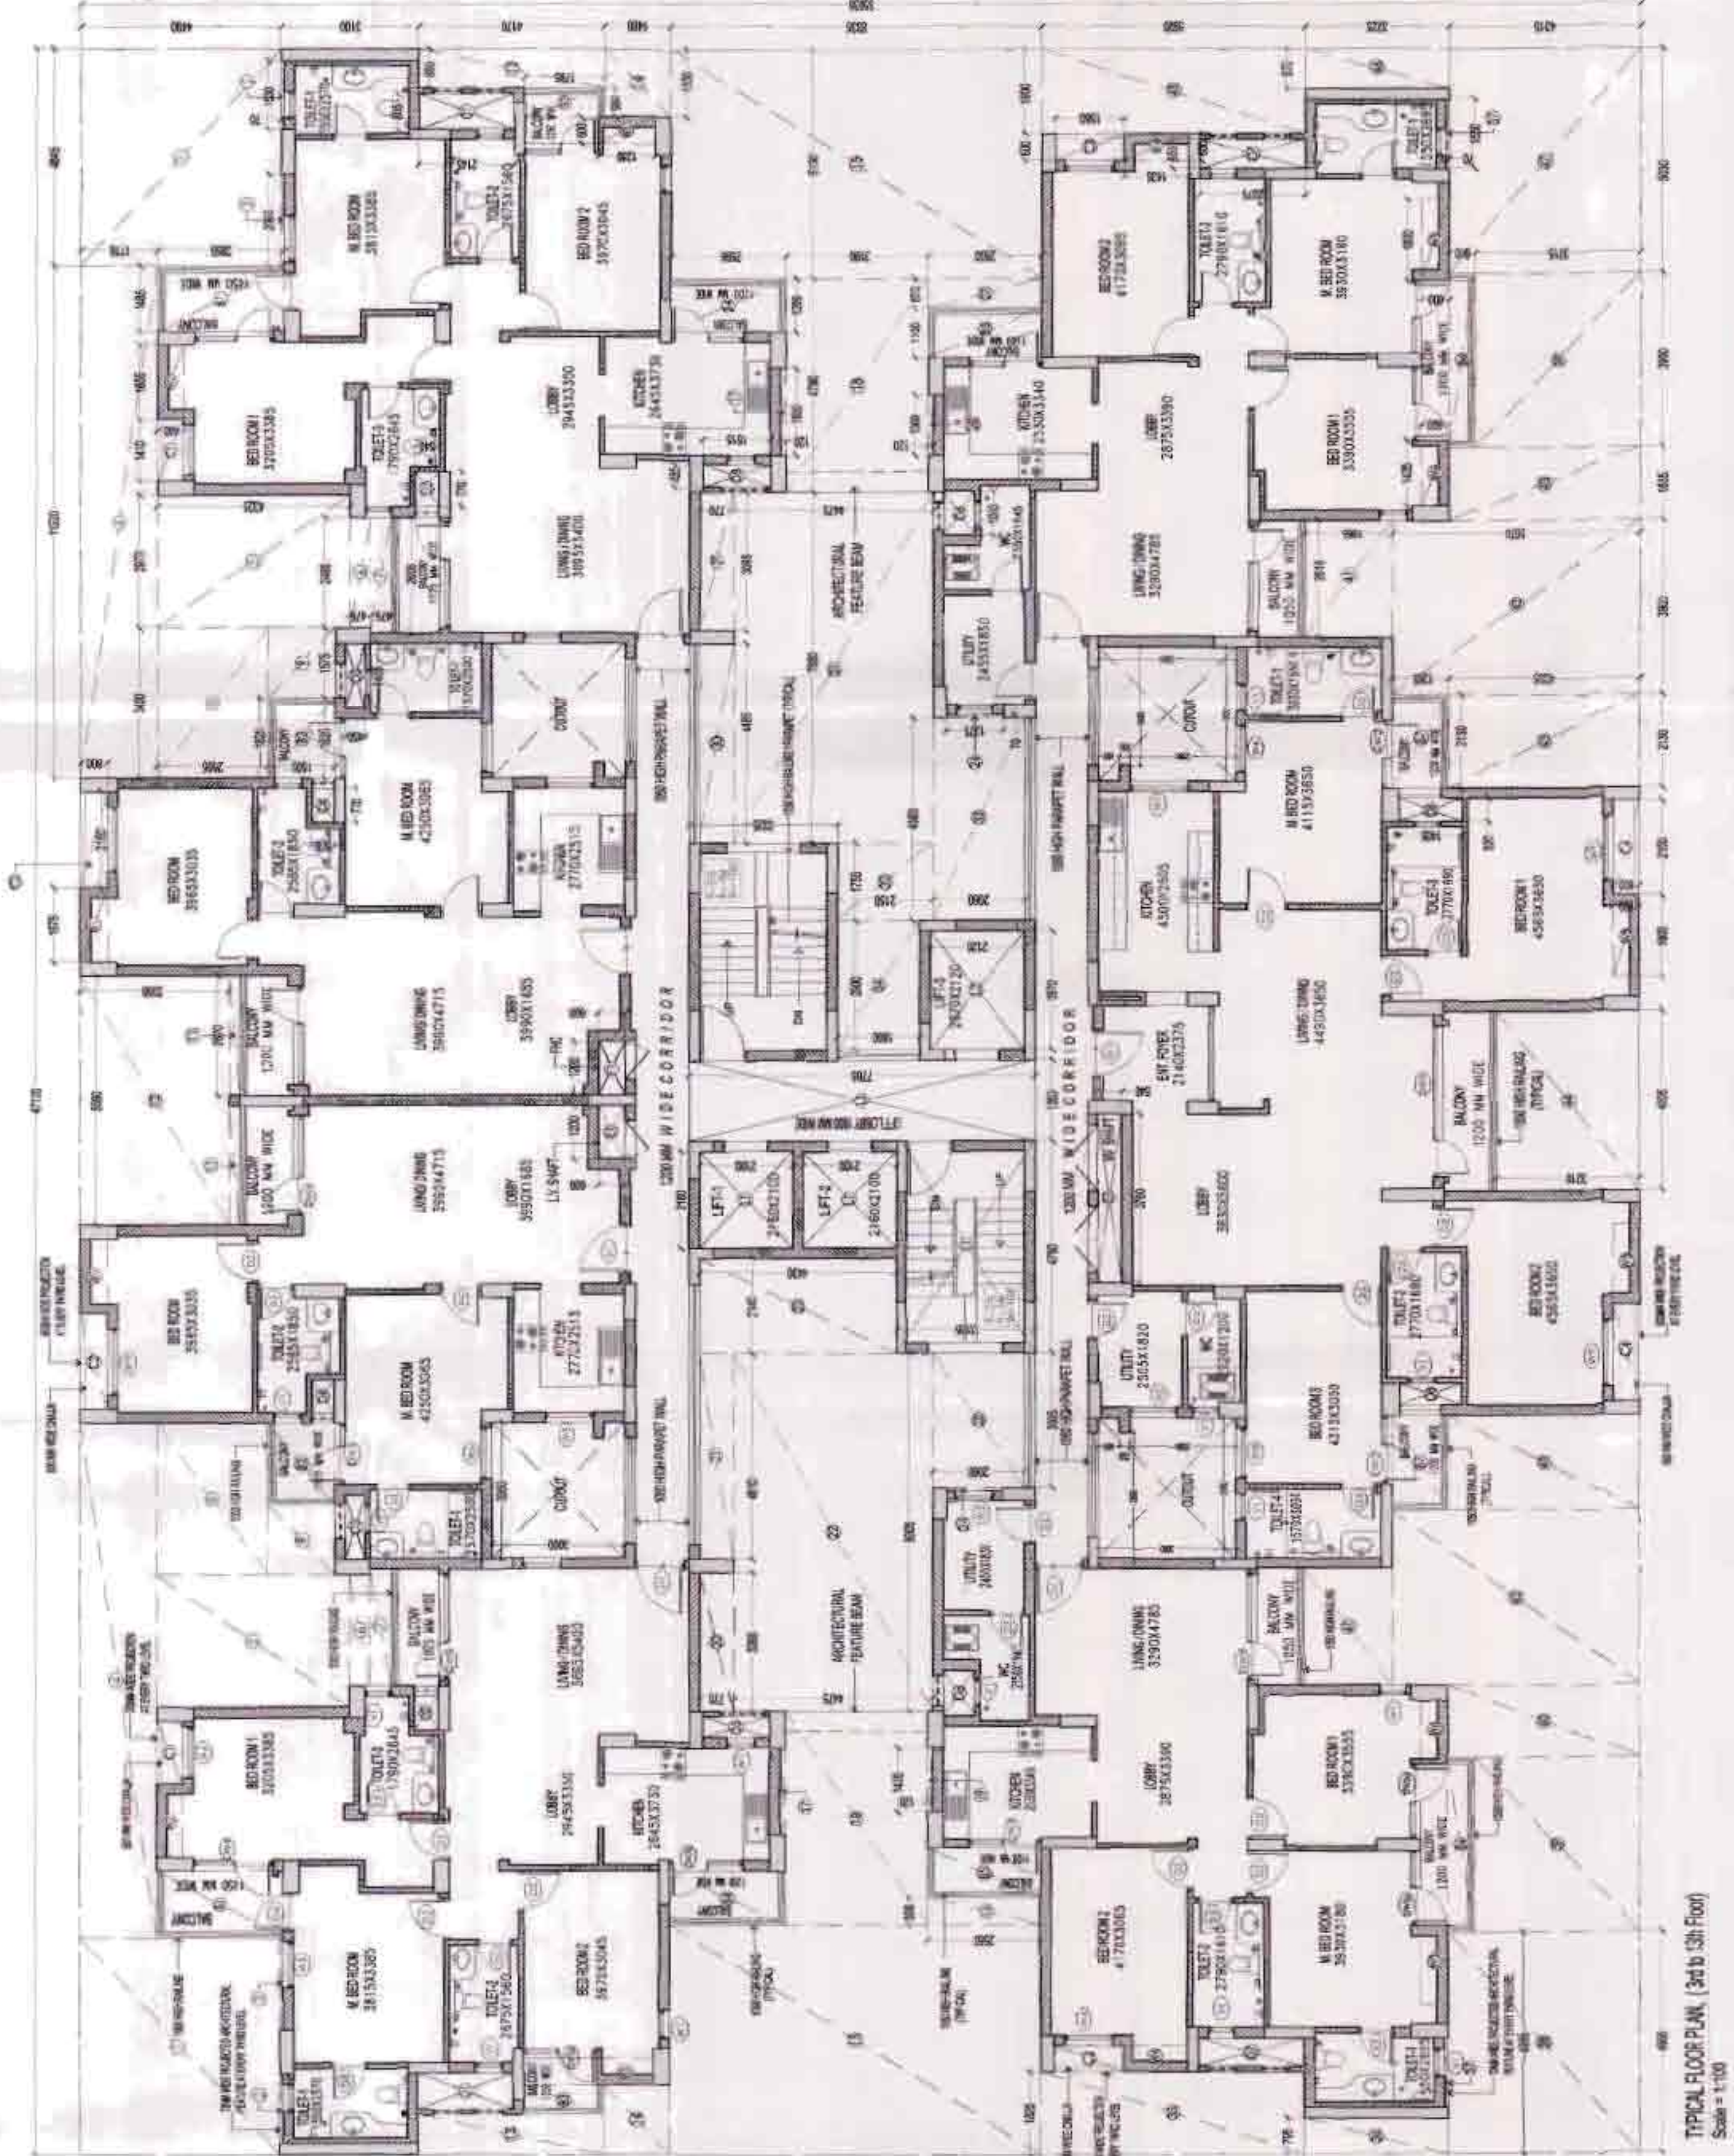


Case No.	Age		Sex		Race		Religion		Marital Status		Occupation		Education		Income		Assets		Liabilities		Net Worth	
	Year	Month	Male	Female	White	Black	Other	Protestant	Catholic	Jewish	Other	Employed	Unemployed	High School	College	Graduate	Annual	Monthly	Real Estate	Personal	Auto	Other
1	1950	1	Male		White			Protestant		Married	Employed		High School				\$10,000	\$833	\$50,000	\$10,000	\$40,000	
2	1950	2	Female		White			Catholic		Married	Unemployed		High School				\$5,000	\$417	\$25,000	\$5,000	\$20,000	
3	1950	3	Male		White			Protestant		Married	Employed		High School				\$15,000	\$1,250	\$75,000	\$15,000	\$60,000	
4	1950	4	Female		White			Catholic		Married	Unemployed		High School				\$8,000	\$667	\$40,000	\$8,000	\$32,000	
5	1950	5	Male		White			Protestant		Married	Employed		High School				\$12,000	\$1,000	\$60,000	\$12,000	\$48,000	
6	1950	6	Female		White			Catholic		Married	Unemployed		High School				\$6,000	\$500	\$30,000	\$6,000	\$24,000	
7	1950	7	Male		White			Protestant		Married	Employed		High School				\$18,000	\$1,500	\$90,000	\$18,000	\$72,000	
8	1950	8	Female		White			Catholic		Married	Unemployed		High School				\$9,000	\$750	\$45,000	\$9,000	\$36,000	
9	1950	9	Male		White			Protestant		Married	Employed		High School				\$14,000	\$1,167	\$70,000	\$14,000	\$56,000	
10	1950	10	Female		White			Catholic		Married	Unemployed		High School				\$7,000	\$583	\$35,000	\$7,000	\$28,000	

[illegible]


FAR AREA DIAGRAM - TYPICAL (3rd To 13th Floor)
Scale = 1:150

Scale = 1:150

TYPICAL FLOOR PLAN, (3rd to 13th Floor)
Scale = 1/100

Scale = 1:100

[illegible]

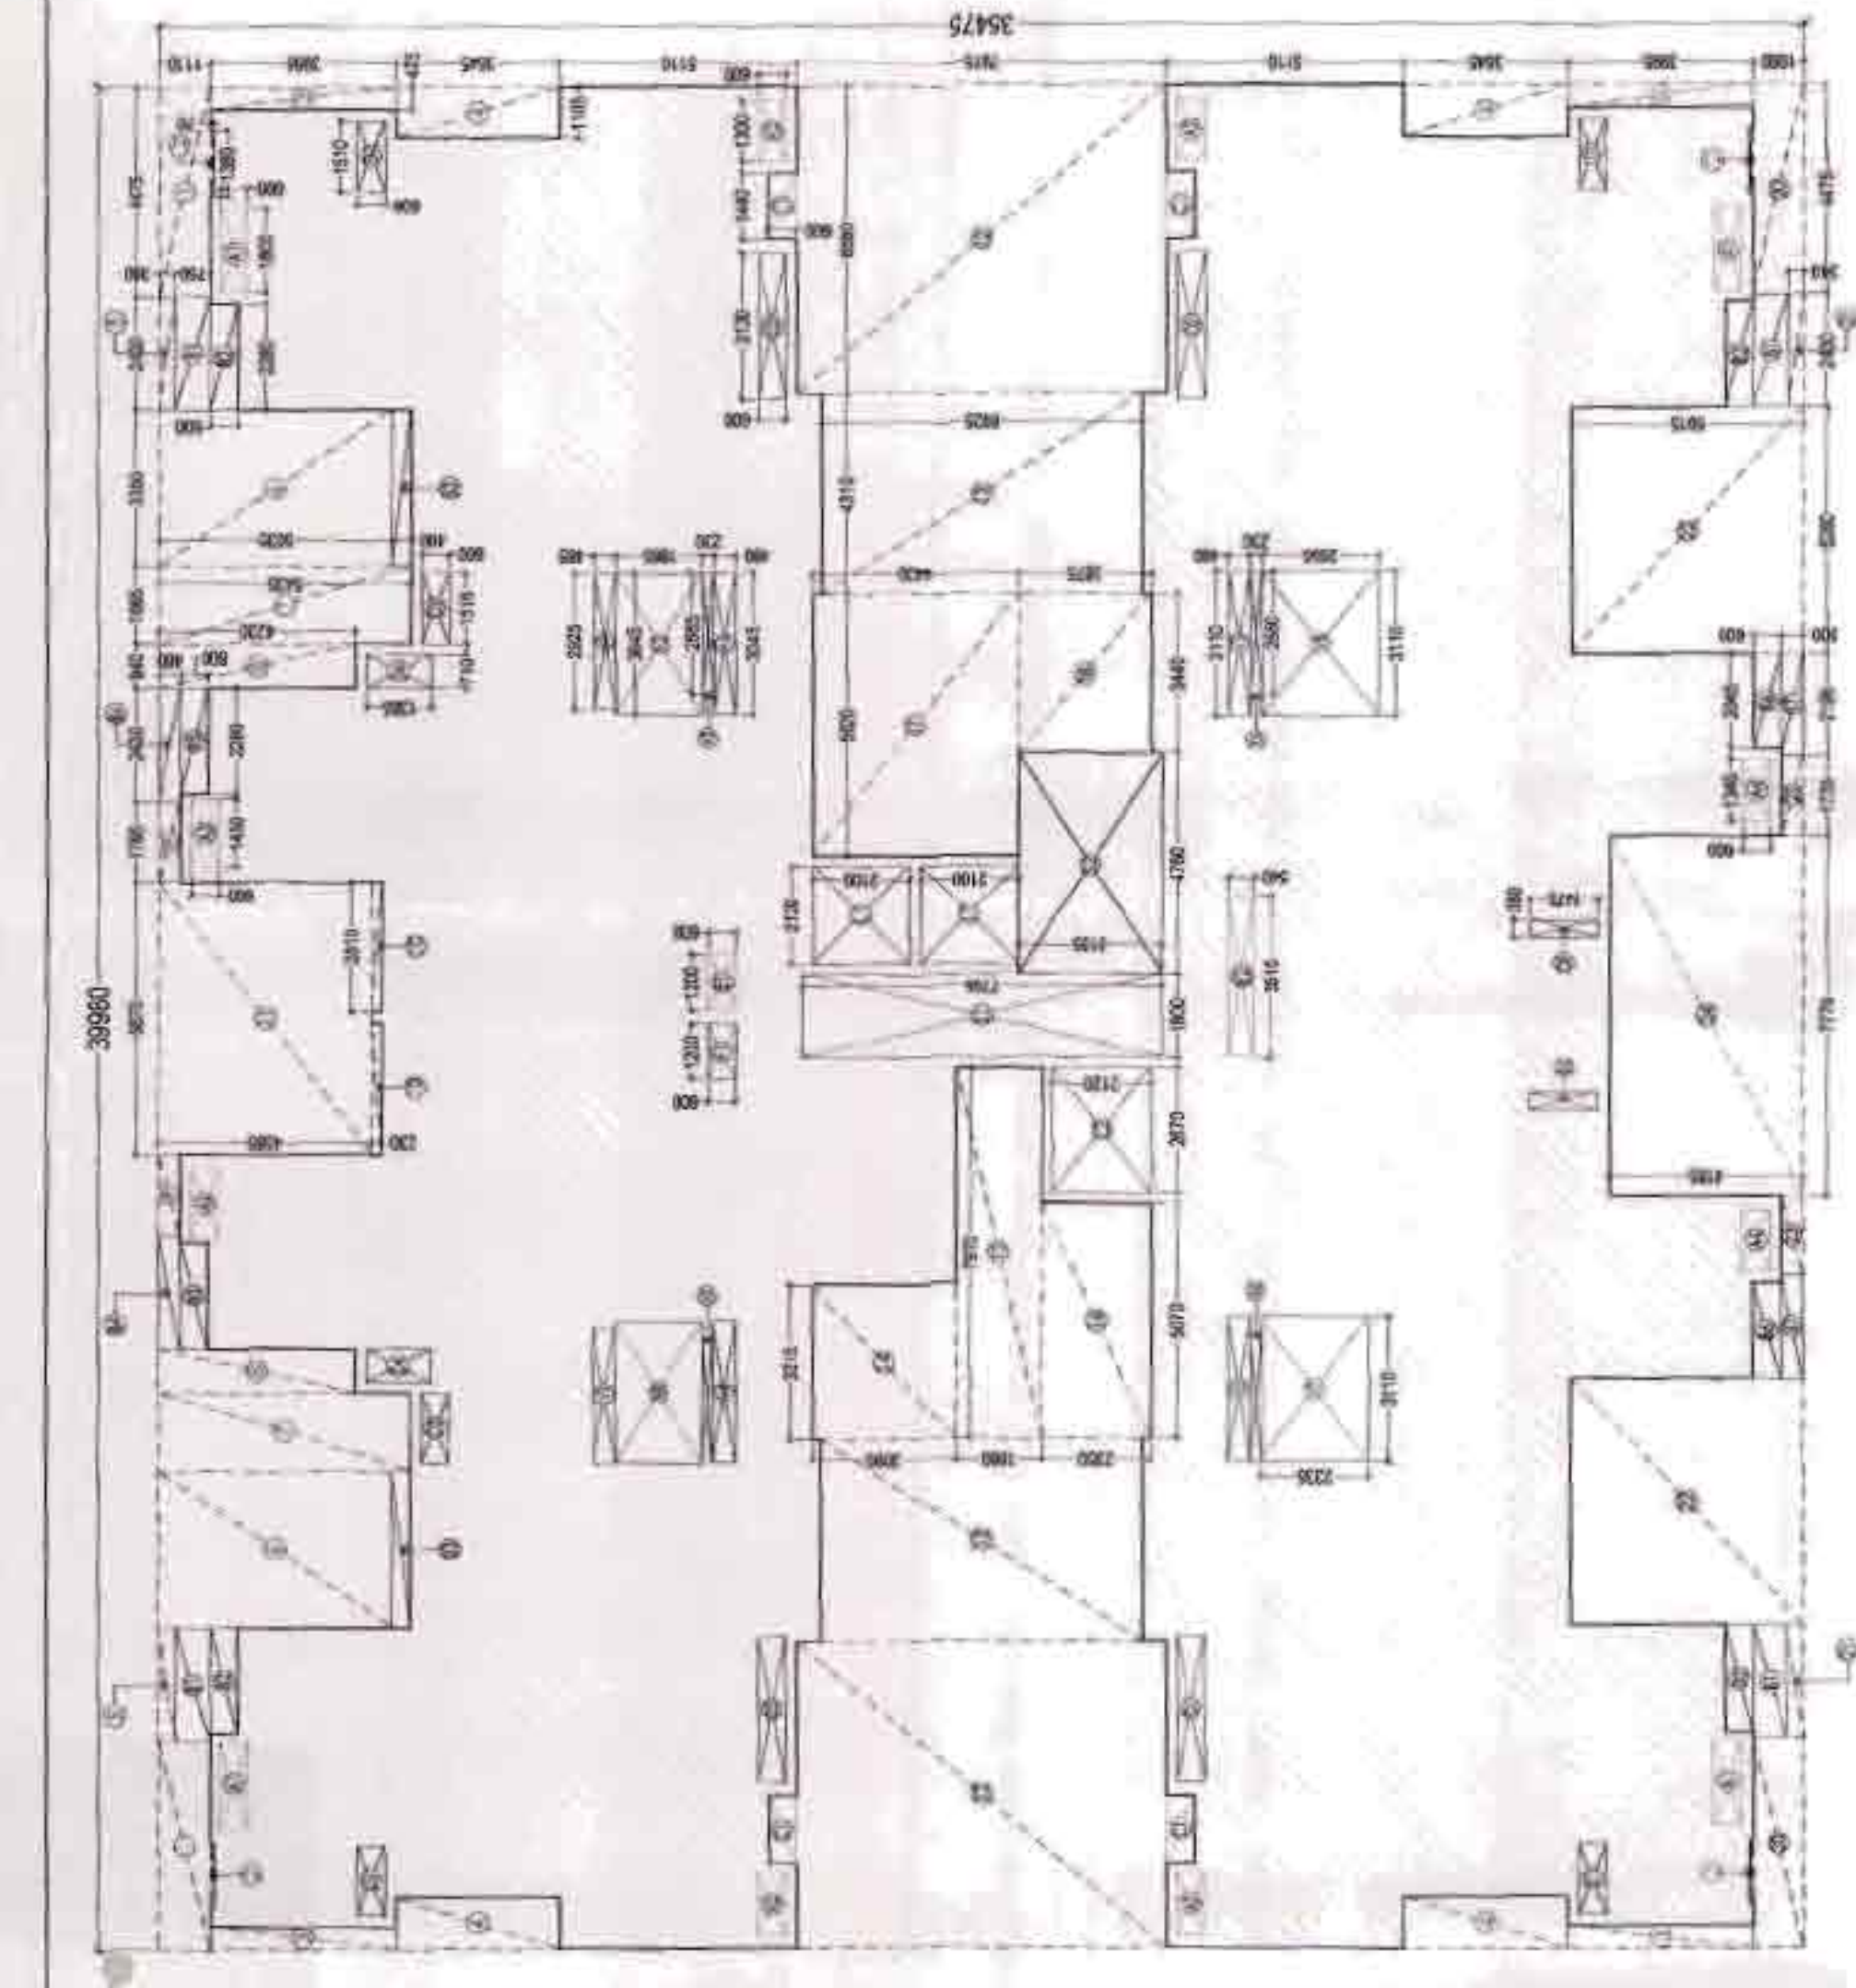

FAR AREA DIAGRAM-TYPICAL (3rd to 14th Floor)
Scale = 1:150

FAR AREA-TYPICAL FLOOR

(All Distances are in Meter & Areas in Sqm)

ADDITIONS (A)

1

LENGTH (X)

33.980

WIDTH (Y)

35.475

NOS (Z)

1.0

AREA=XYXZ

1418.291

TOTAL ADDITIONS (A)

= 1418.291

SUBTRACTIONS

OPEN AREAS (B)

TYPE	LENGTH	WIDTH	NOS	AREA	TYPE	LENGTH	WIDTH	NOS	AREA
D1	1.725	0.500	2	1.725	D1	1.150	0.600	4	3.24
D2	1.770	4.185	1	7.385	D2	3.130	0.600	4	7.512
D3	1.470	0.600	4	3.465	D3	1.515	0.600	2	1.918
D4	1.105	3.435	4	15.098	D4	0.710	1.385	2	1.967
D5	2.430	0.300	2	1.458	D5	0.380	1.475	2	1.121
D6	3.360	0.035	2	0.228	D6	1.200	0.600	1	0.720
D7	1.665	5.435	2	18.099	D7	3.515	0.540	1	1.898
D8	0.940	4.230	2	7.952	D8	1.200	0.600	1	0.720
D9	1.765	0.460	2	1.624	D9	1.800	0.785	1	13.977
D10	2.810	0.230	2	1.262	D10	4.760	3.105	1	14.780
D11	5.870	4.965	1	29.144	D11	1.800	0.600	4	4.320
D12	8.590	7.775	2	104.951	D12	2.430	0.750	4	7.296
D13	4.310	6.025	2	52.654	D13	2.280	0.620	4	5.412
D14	3.315	3.960	1	10.360	D14	3.350	0.400	2	2.680
D15	1.770	1.965	1	3.475	D15	2.430	0.460	2	2.216
D16	5.070	2.500	1	12.675	D16	2.280	0.670	2	3.116
D17	3.830	4.430	1	16.977	D17	2.045	0.600	2	2.454
D18	2.440	2.875	1	7.006	D18	2.195	0.550	2	2.415
D19	4.475	1.000	2	8.950	D19	2.120	2.100	2	8.904
D20	2.440	0.540	2	2.622	D20	2.270	2.120	1	4.812
D21	2.440	0.540	2	2.622	D21	2.270	2.120	1	4.812
D22	2.330	3.015	2	14.001	D22	2.270	2.120	1	4.812
Total (B) =				540.772	Total (D) =				58.931

SUMMARY

TOTAL FAR AREA AT TYPICAL FLOOR = ADDITIONS (A) - OPEN AREAS (B) - SERVICE AREA (D) = 818.588 Sqm

SERVICE AREA (Additional 15% of FAR) AT TYPICAL FLOOR = 58.931 Sqm

OPENING SCHEDULE			
NO	WIDTH (in mm)	HEIGHT (in mm)	CLL (in mm)
D1	1085	2500	2400
D2	840	2150	2150
D3	840	2150	2150
D4	840	2150	2150
D5	840	2150	2150
D6	840	2150	2150
D7	1020	2150	2150
D8	1500	2150	2150
D9	1830	2100	2000
D10	2350	2100	2000
D11	1700	2100	2000
D12	2485	2100	2000
D13	2585	2100	2000
D14	3240	2100	2000
D15	3240	2100	2000
D16	3240	2100	2000
D17	3240	2100	2000
D18	3240	2100	2000
D19	3240	2100	2000
D20	3240	2100	2000
D21	3240	2100	2000
D22	3240	2100	2000
D23	3240	2100	2000
D24	3240	2100	2000
D25	3240	2100	2000
D26	3240	2100	2000
D27	3240	2100	2000
D28	3240	2100	2000
D29	3240	2100	2000
D30	3240	2100	2000
D31	3240	2100	2000
D32	3240	2100	2000
D33	3240	2100	2000
D34	3240	2100	2000
D35	3240	2100	2000
D36	3240	2100	2000
D37	3240	2100	2000
D38	3240	2100	2000
D39	3240	2100	2000
D40	3240	2100	2000
D41	3240	2100	2000
D42	3240	2100	2000
D43	3240	2100	2000
D44	3240	2100	2000
D45	3240	2100	2000
D46	3240	2100	2000
D47	3240	2100	2000
D48	3240	2100	2000
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D74	3240	2100	2000
D75	3240	2100	2000
D76	3240	2100	2000
D77	3240	2100	2000
D78	3240	2100	2000
D79	3240	2100	2000
D80	3240	2100	2000
D81	3240	2100	2000
D82	3240	2100	2000
D83	3240	2100	2000
D84	3240	2100	2000
D85	3240	2100	2000
D86	3240	2100	2000
D87	3240	2100	2000
D88	3240	2100	2000
D89	3240	2100	2000
D90	3240	2100	2000
D91	3240	2100	2000
D92	3240	2100	2000
D93	3240	2100	2000
D94	3240	2100	2000
D95	3240	2100	2000
D96	3240	2100	2000
D97	3240	2100	2000
D98	3240	2100	2000
D99	3240	2100	2000
D100	3240	2100	2000

MASTER PLAN - 3D View of the entire project site showing the location of the building and surrounding infrastructure.

KEY PLAN - 2D View of the building footprint and its location within the site boundaries.

ARCHITECTS:
GAN P. MAHUR & ASSOCIATES PVT. LTD.
ARCHITECTS, ENGINEERS & PLANNERS
C-35 EAST OF MAIN RD, NEW DELHI-110045
PH: 011-46999999 FAX: 011-46999912
Email: ganp.mahur@gmail.com

ARCHITECT SIGNATURE:

CLIENT:
M/S. JAYPEE INFRASTRUCTURE LTD.
SECTOR - 128, NOIDA, U. P.

OWNER SIGNATURE:

JOB TITLE:
SUBMISSION DRAWING

PROJECT:
POCKET B-45, JAYPEE GREEN, SEC-134, NOIDA, (U. P.)

DRAWING TITLE:
TYPICAL FLOOR PLAN (3rd to 14th Floor)
TOWER KD - 3

DATE: 20-08-2021

CHECKED BY: HANSHU

DESIGN NO.: JPD/2021-08/03/08

NOIDA AUTHORITY:

SCALE: 1:100 (1:50)

DRAWING NO.: JPD/2021-08/03/08

DATE: 20-08-2021

CHECKED BY: HANSHU

DESIGN NO.: JPD/2021-08/03/08


NOIDA AUTHORITY:

ARCHITECT: GAN P. MAHUR

ARCHITECT SIGNATURE:

(2) सभी से अधिकतम 3D में प्रदर्शित
की गई है। इसका अर्थ है कि यह
अंतिम रूप में प्रदर्शित नहीं किया गया है।

Key Plan

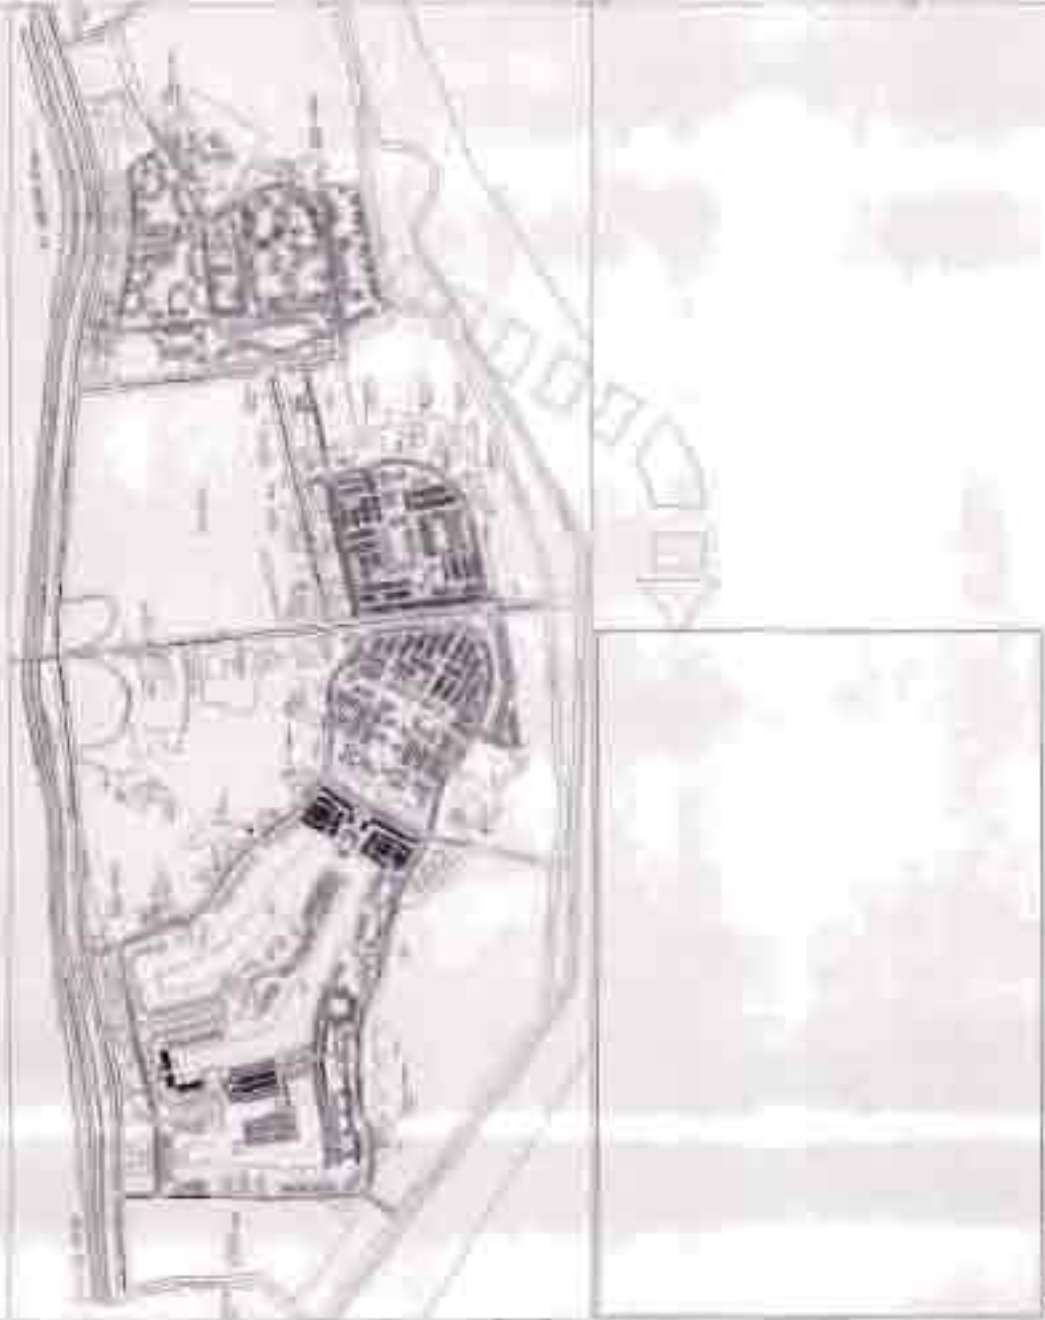

Notes

NO.	DESCRIPTION	REVISION
1	As per the approved plan	1
2	As per the approved plan	2
3	As per the approved plan	3
4	As per the approved plan	4
5	As per the approved plan	5
6	As per the approved plan	6
7	As per the approved plan	7
8	As per the approved plan	8
9	As per the approved plan	9
10	As per the approved plan	10
11	As per the approved plan	11
12	As per the approved plan	12

Drawing Title
CLUSTER B - 45, PH-1 TYPE KI 01
THIRD FLOOR PLAN
TYPICAL FOR 7TH, 11TH, 15TH & 19TH

Job Title

BUILDING SUBMISSION
CLUSTER B - 45

Project

JAYPEE GREENS NOIDA
PART SECTOR-129
NOIDA, U. P.

Architects & Town Planners

ARCOP ASSOCIATES Pvt. Ltd.
E-106, G.K. ENCLAVE Part-I
New Delhi-110 049
Ph. : 011-26242050 Fax : 011-26238035

Architect's Signature

Building Submittal, Noida,
U.P. 201305

Owners' Signature

Clients
JAYPEE INFRA TECH LTD.

Job No.

2006/17

Scale

1:100

Date

DEC 2011

Drawn by

SHIVIKA

Checked by


SHIVIKA

Revision No.

BS B-45/007

Noida Authority :

Associate Architect/Chief Architect

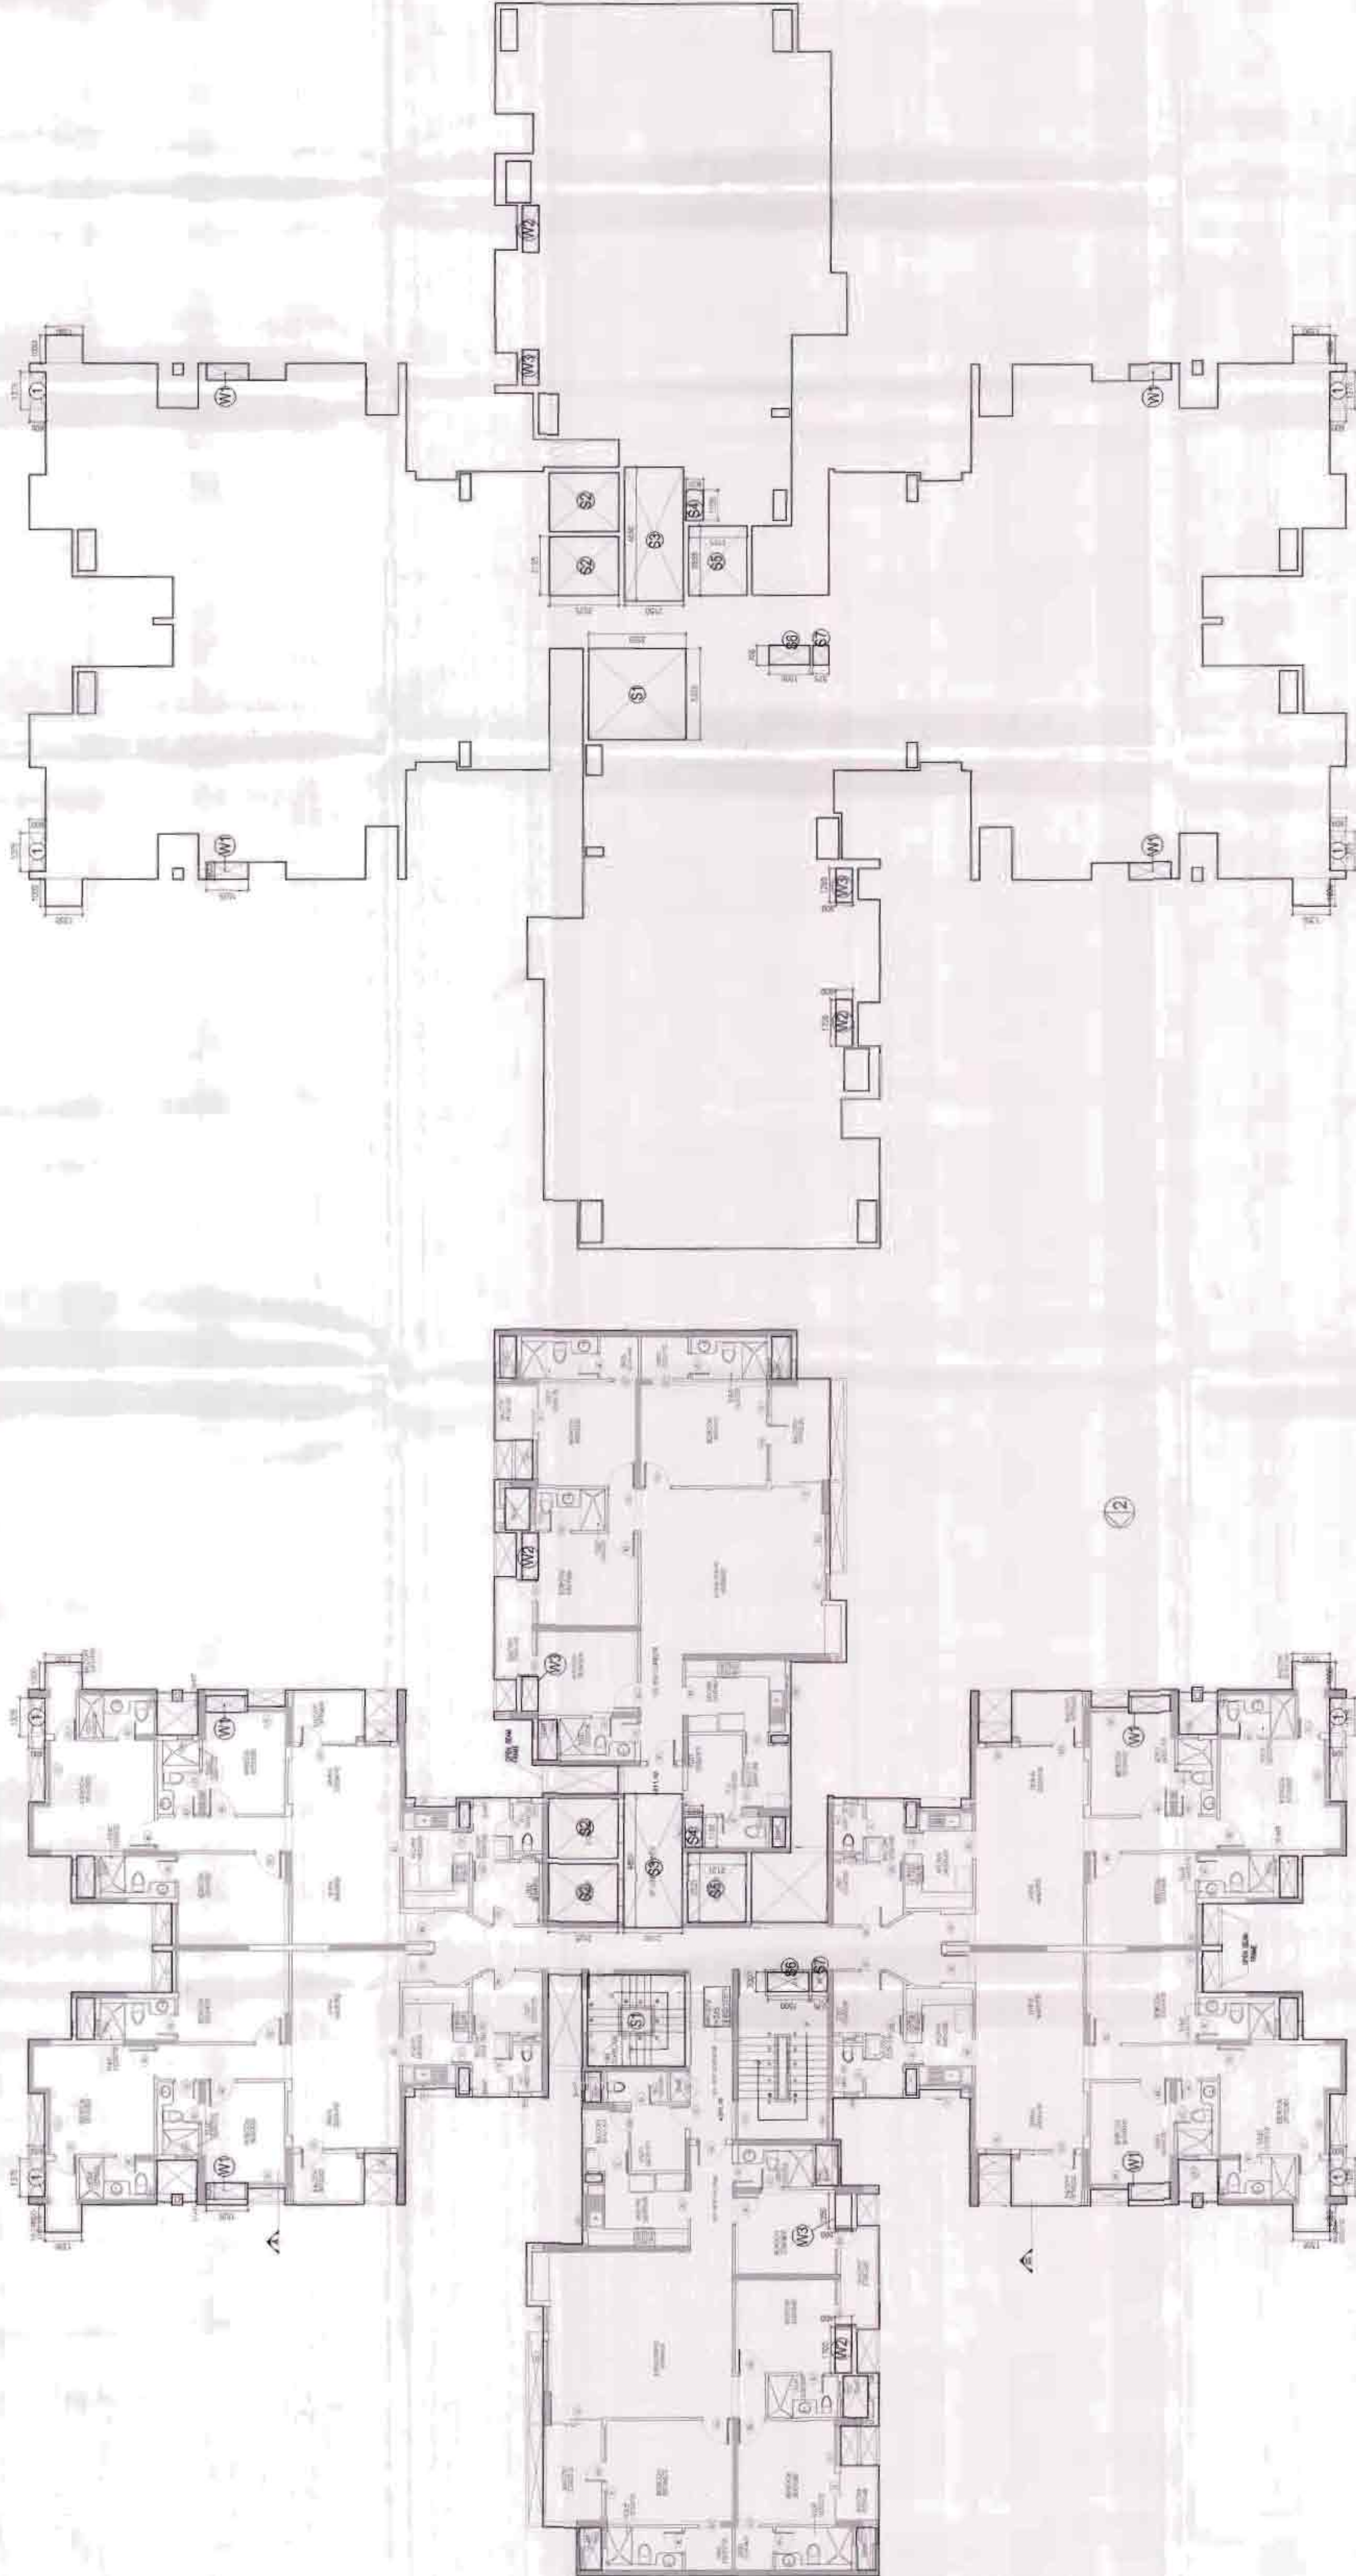


THIRD FLOOR PLAN
(TYPICAL FOR 7th, 11th, 15th & 19th FLOOR)

THIRD FLOOR AREA DIAGRAM

15% OF F.A.R AREA ON 3RD FLOOR					
S.NO.	NO.s	Corr.	Length	Breadth	Area
ADDITION					
S1	1	1	3325	3550	11,804
S2	2	1	2125	2525	10,731
S3	1	1	4850	2150	10,428
S4	1	1	1100	625	0,688
S5	1	1	2525	2125	5,366
S6	1	1	700	1500	1,050
S7	1	1	700	575	0,403
W1	4	1	1525	600	3,660
W2	2	1	1700	600	2,040
W3	2	1	1250	600	1,500
TOTAL ADDITION					47,668
TOTAL 15% OF F.A.R AREA ON 3RD FLOOR					47,668

F.A.R AREA ON 3RD FLOOR				
S.NO.	NO.s	Corr.	Length	Area
AREA ON FOURTH FLOOR				935.07
SUBTRACTION				
1	4	1	1375	3.3
TOTAL SUBTRACTION				931.770
TOTAL F.A.R AREA ON 3RD FLOOR				931.770

Key Plan

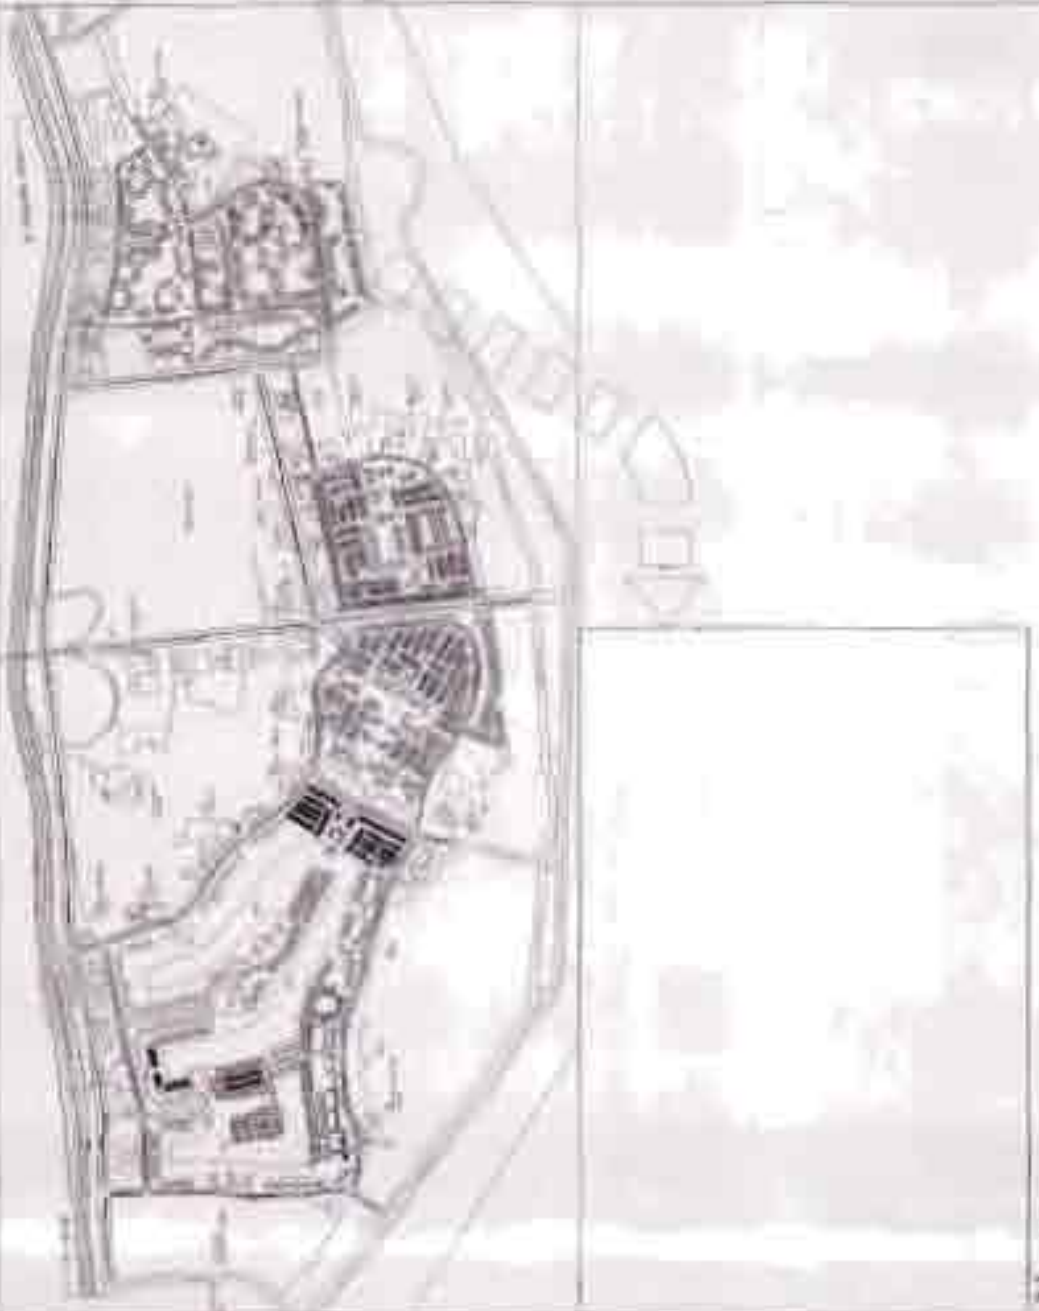

Notes

Sl. No.	Remarks	Remarks	Remarks
1	100% F.A.R. ON 3RD FLOOR	100% F.A.R. ON 3RD FLOOR	100% F.A.R. ON 3RD FLOOR
2	100% F.A.R. ON 3RD FLOOR	100% F.A.R. ON 3RD FLOOR	100% F.A.R. ON 3RD FLOOR
3	100% F.A.R. ON 3RD FLOOR	100% F.A.R. ON 3RD FLOOR	100% F.A.R. ON 3RD FLOOR
4	100% F.A.R. ON 3RD FLOOR	100% F.A.R. ON 3RD FLOOR	100% F.A.R. ON 3RD FLOOR
5	100% F.A.R. ON 3RD FLOOR	100% F.A.R. ON 3RD FLOOR	100% F.A.R. ON 3RD FLOOR
6	100% F.A.R. ON 3RD FLOOR	100% F.A.R. ON 3RD FLOOR	100% F.A.R. ON 3RD FLOOR
7	100% F.A.R. ON 3RD FLOOR	100% F.A.R. ON 3RD FLOOR	100% F.A.R. ON 3RD FLOOR
8	100% F.A.R. ON 3RD FLOOR	100% F.A.R. ON 3RD FLOOR	100% F.A.R. ON 3RD FLOOR
9	100% F.A.R. ON 3RD FLOOR	100% F.A.R. ON 3RD FLOOR	100% F.A.R. ON 3RD FLOOR
10	100% F.A.R. ON 3RD FLOOR	100% F.A.R. ON 3RD FLOOR	100% F.A.R. ON 3RD FLOOR
11	100% F.A.R. ON 3RD FLOOR	100% F.A.R. ON 3RD FLOOR	100% F.A.R. ON 3RD FLOOR
12	100% F.A.R. ON 3RD FLOOR	100% F.A.R. ON 3RD FLOOR	100% F.A.R. ON 3RD FLOOR
13	100% F.A.R. ON 3RD FLOOR	100% F.A.R. ON 3RD FLOOR	100% F.A.R. ON 3RD FLOOR

Drawing Title

CLUSTER B - 45, PH-1 TYPE KI 02
3RD FLOOR PLAN
TYPICAL FOR 7TH, 11TH, 15TH, 19TH FLOOR
3RD FLOOR AREA DIAGRAM

Job Title

BUILDING SUBMISSION
CLUSTER B - 45

Project

JAYPEE GREENS NOIDA
PART SECTOR-129
NOIDA, U. P.

Architects & Town Planners

ARCOP ASSOCIATES Pvt. Ltd.
E-106, G.K. ENCLAVE Part-I
New Delhi-110 049
Ph. : 011-26242050 Fax : 011-26238035

Architect's Signature

[Signature]

Owners' Signature

[Signature]

Clients

JAYPEE INFRA TECH LTD.

Job No.

2006/17

Scale

1:100

Date

DEC. 2011

Checked by

SHIVIKA

Dealt by

NOIDA A.U.

Drawing No.

BS/BS/014


Revision

Revision No. 01


Associate Architect

Architect

Chief Architect

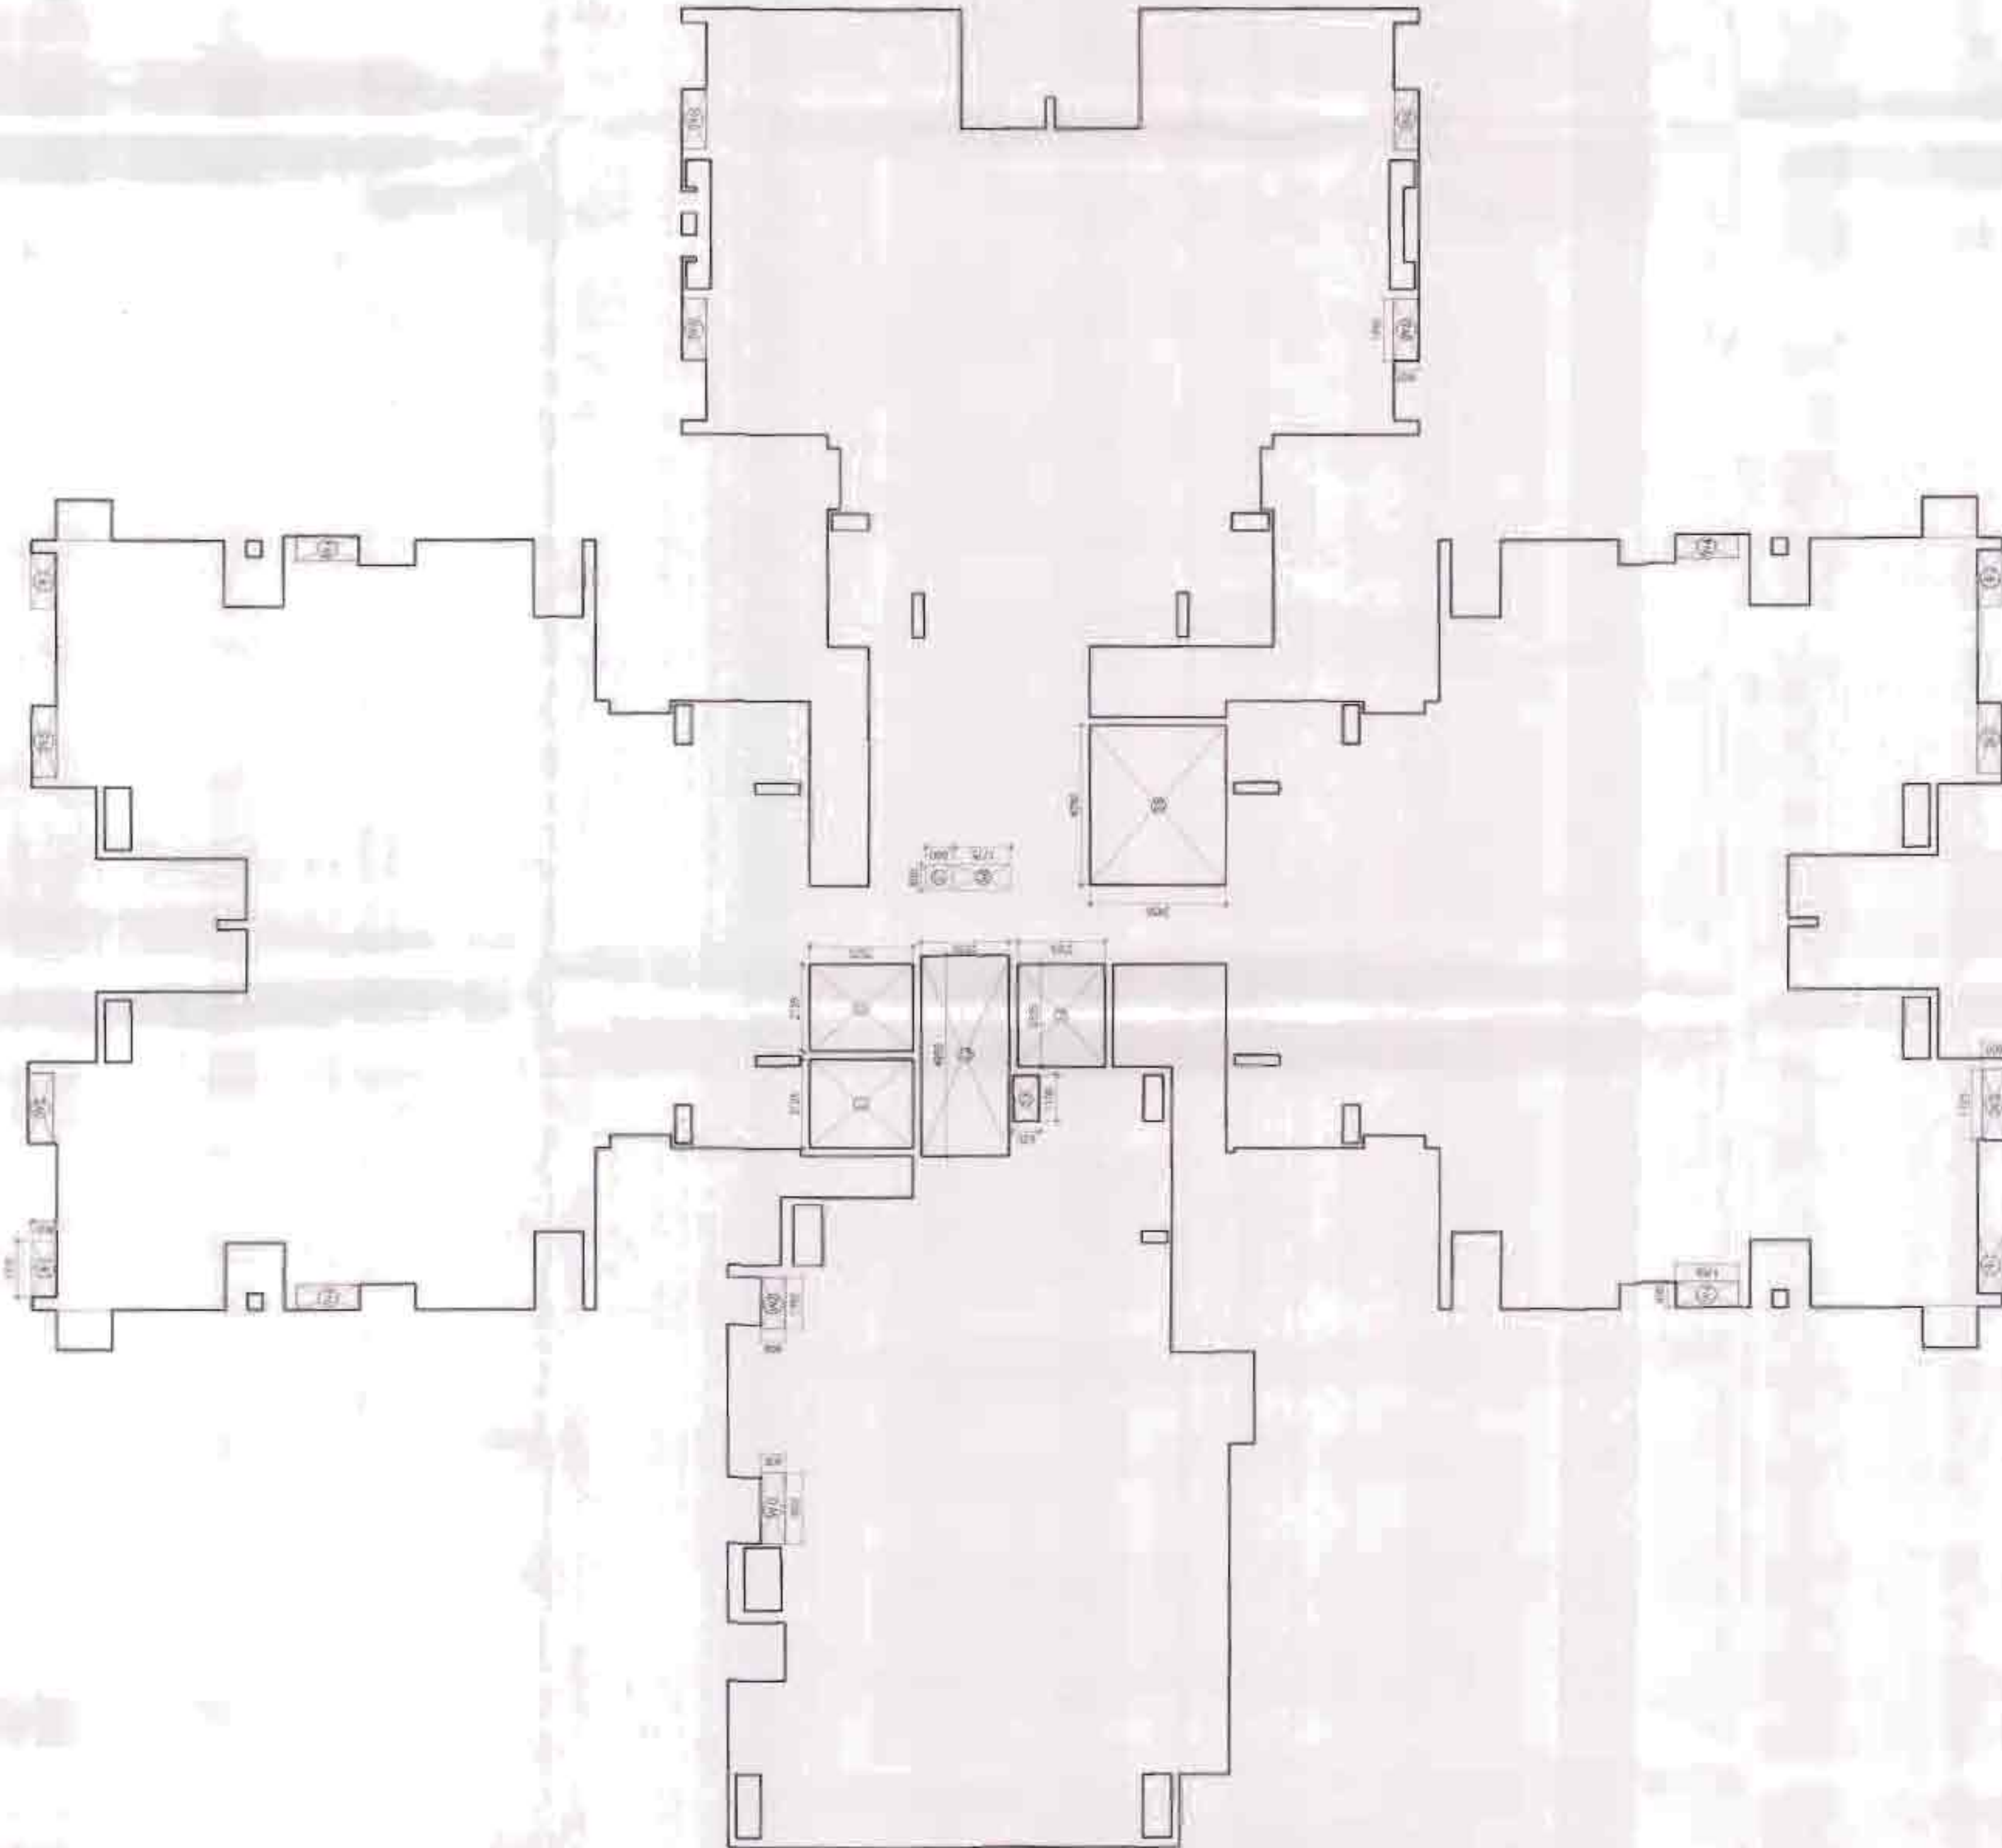

3RD FLOOR AREA DIAGRAM

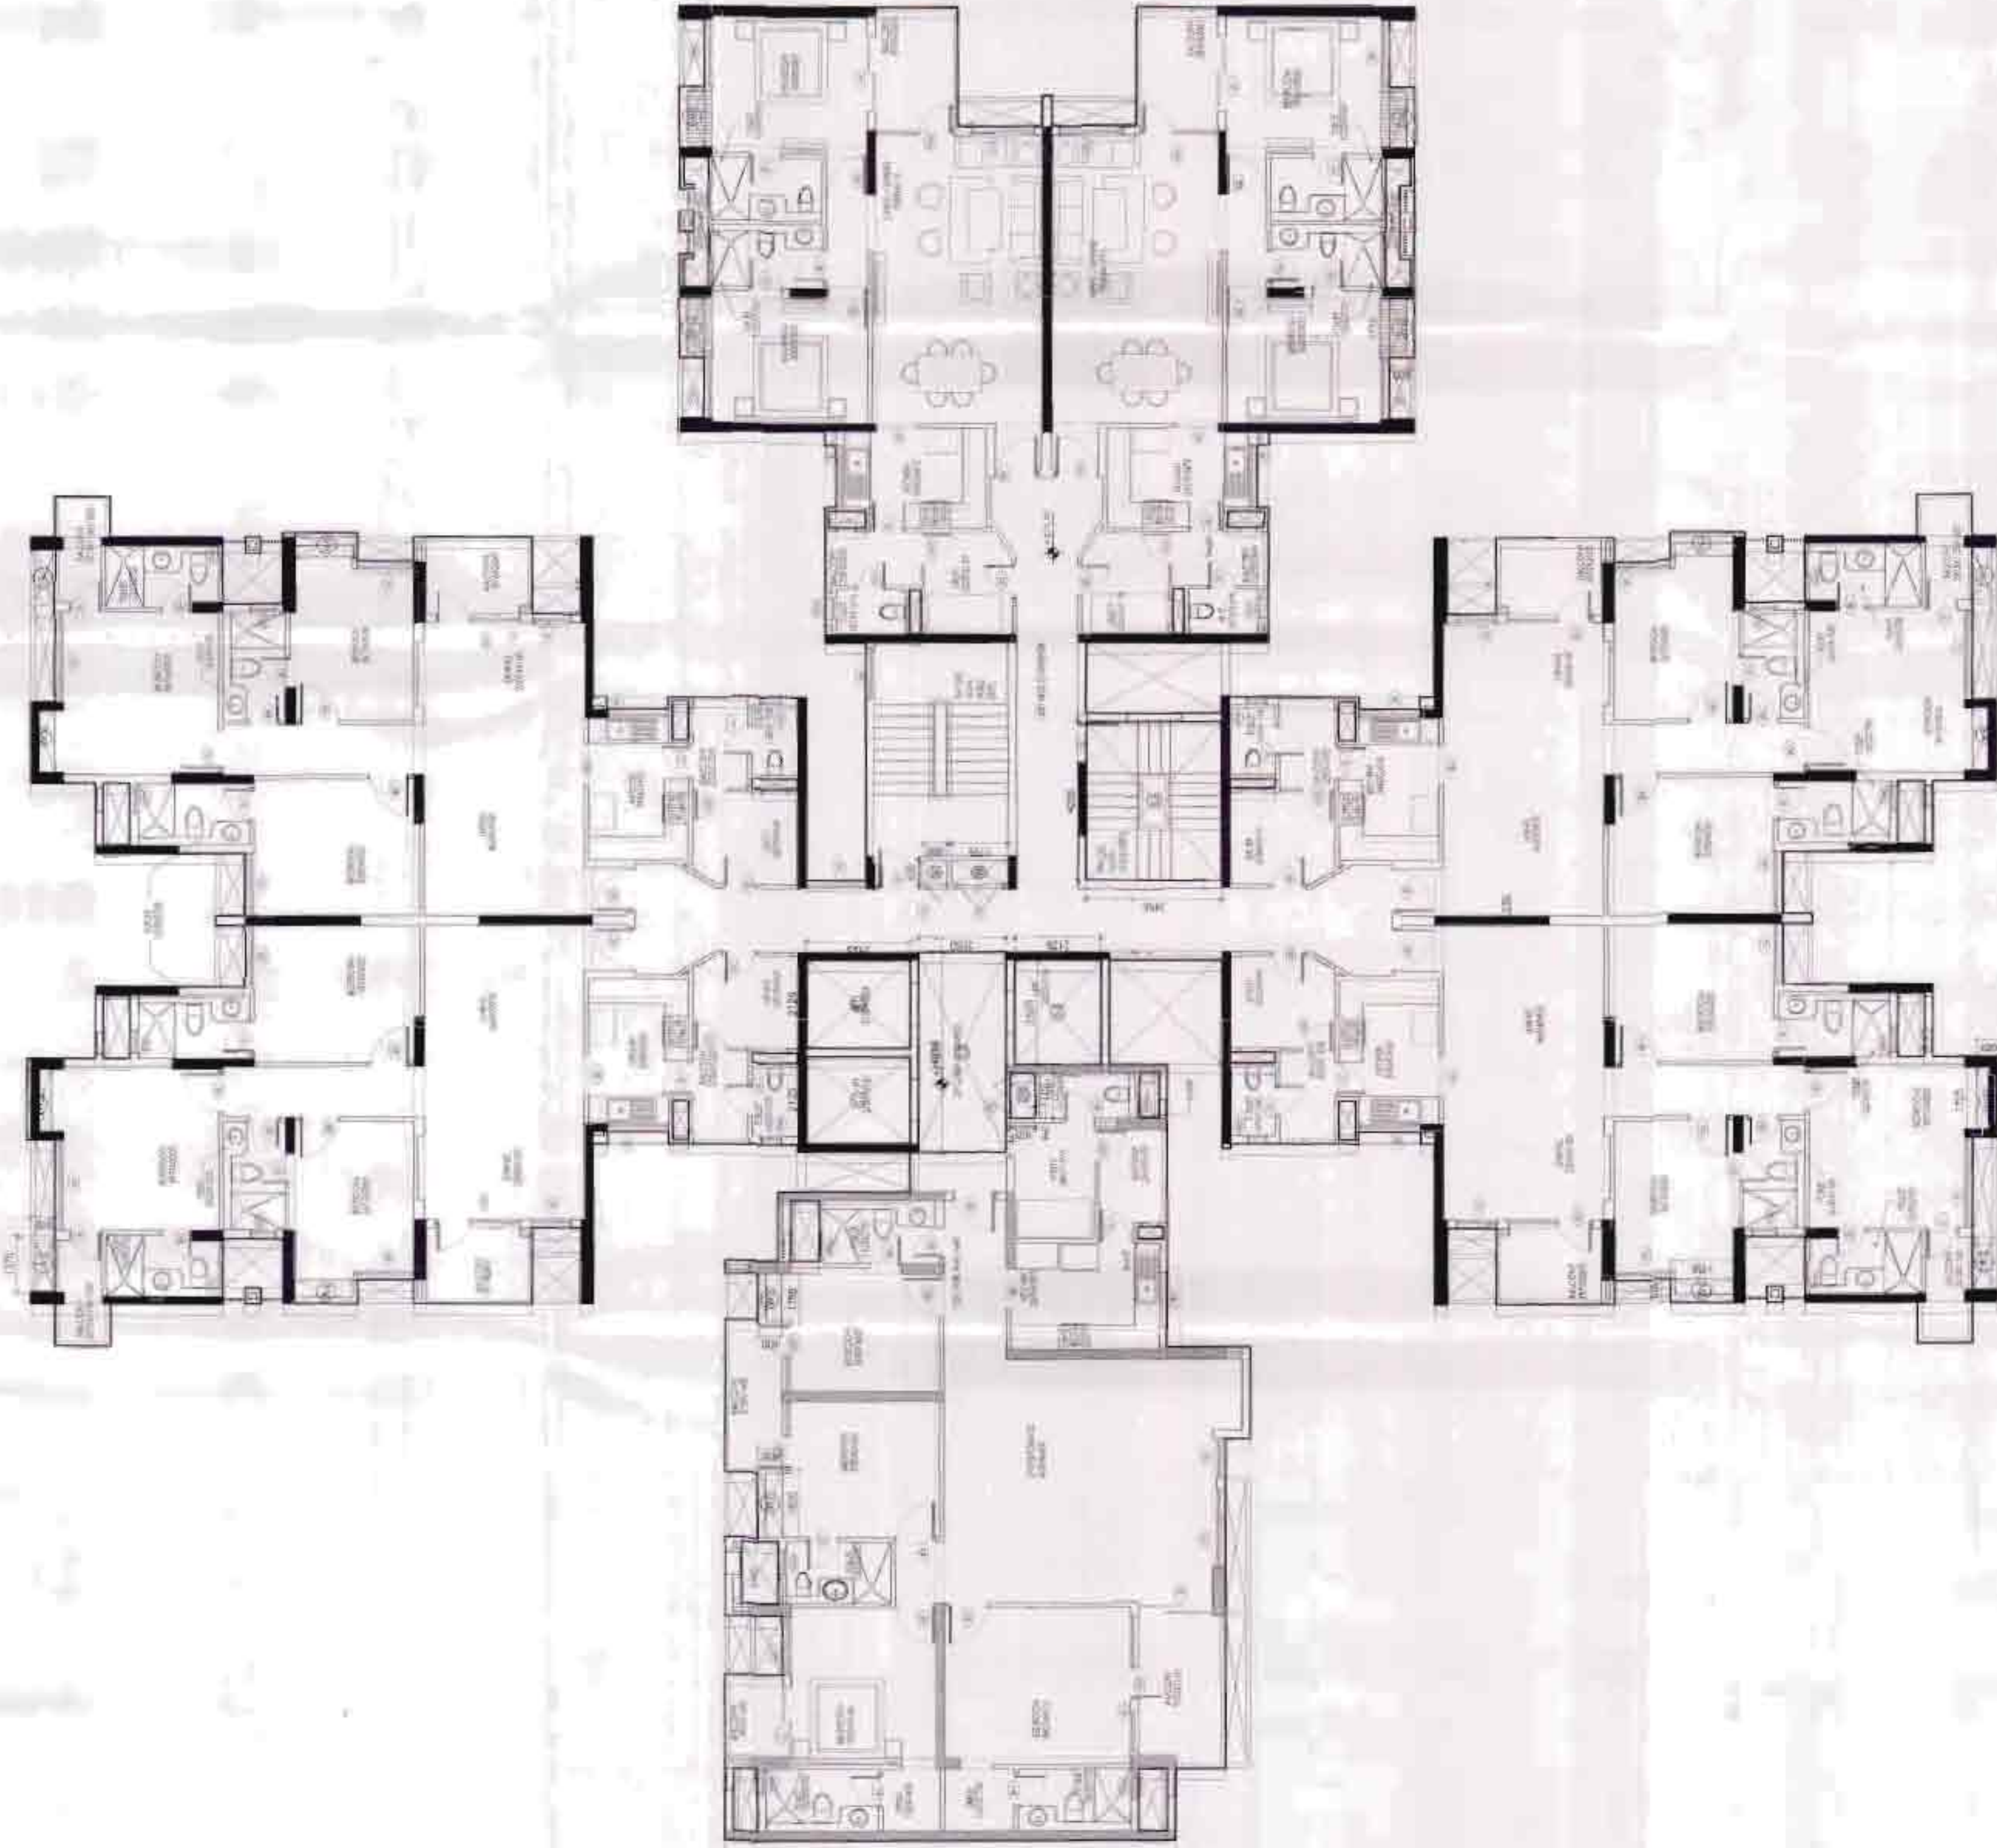


3RD FLOOR PLAN
(TYPICAL FOR 7TH, 11TH, 15TH, 19TH FLOOR)


S. NO.	NO. S	Coff.	Length	Breadth	Area
ADDITION					
S1	2	1	2125	2525	10.731
S2	1	1	4950	2550	12.623
S3	1	1	1100	625	0.688
S4	1	1	2525	2125	5.366
S5	1	1	4250	3450	14.663
S6	1	1	600	1775	1.065
S7	1	1	1800	600	0.360
W1	1	1	1750	600	1.050
W2	1	1	1750	600	1.050
W3	4	1	1725	600	4.140
W4	4	1	1725	600	4.140
W5	4	1	1725	600	4.140
W6	4	1	1725	600	4.140
TOTAL ADDITION					60.164
TOTAL 15% OF F.A.R. AREA ON 3RD FLOOR					60.164

S. NO.	NO. S	Coff.	Length	Breadth	Area
AREA ON FOURTH FLOOR					958.738
SUBTRACTION					3.300
1	4	1	1375	600	3.300
TOTAL SUBTRACTION					955.438
TOTAL F.A.R. AREA ON 3RD FLOOR					955.438

Key Plan

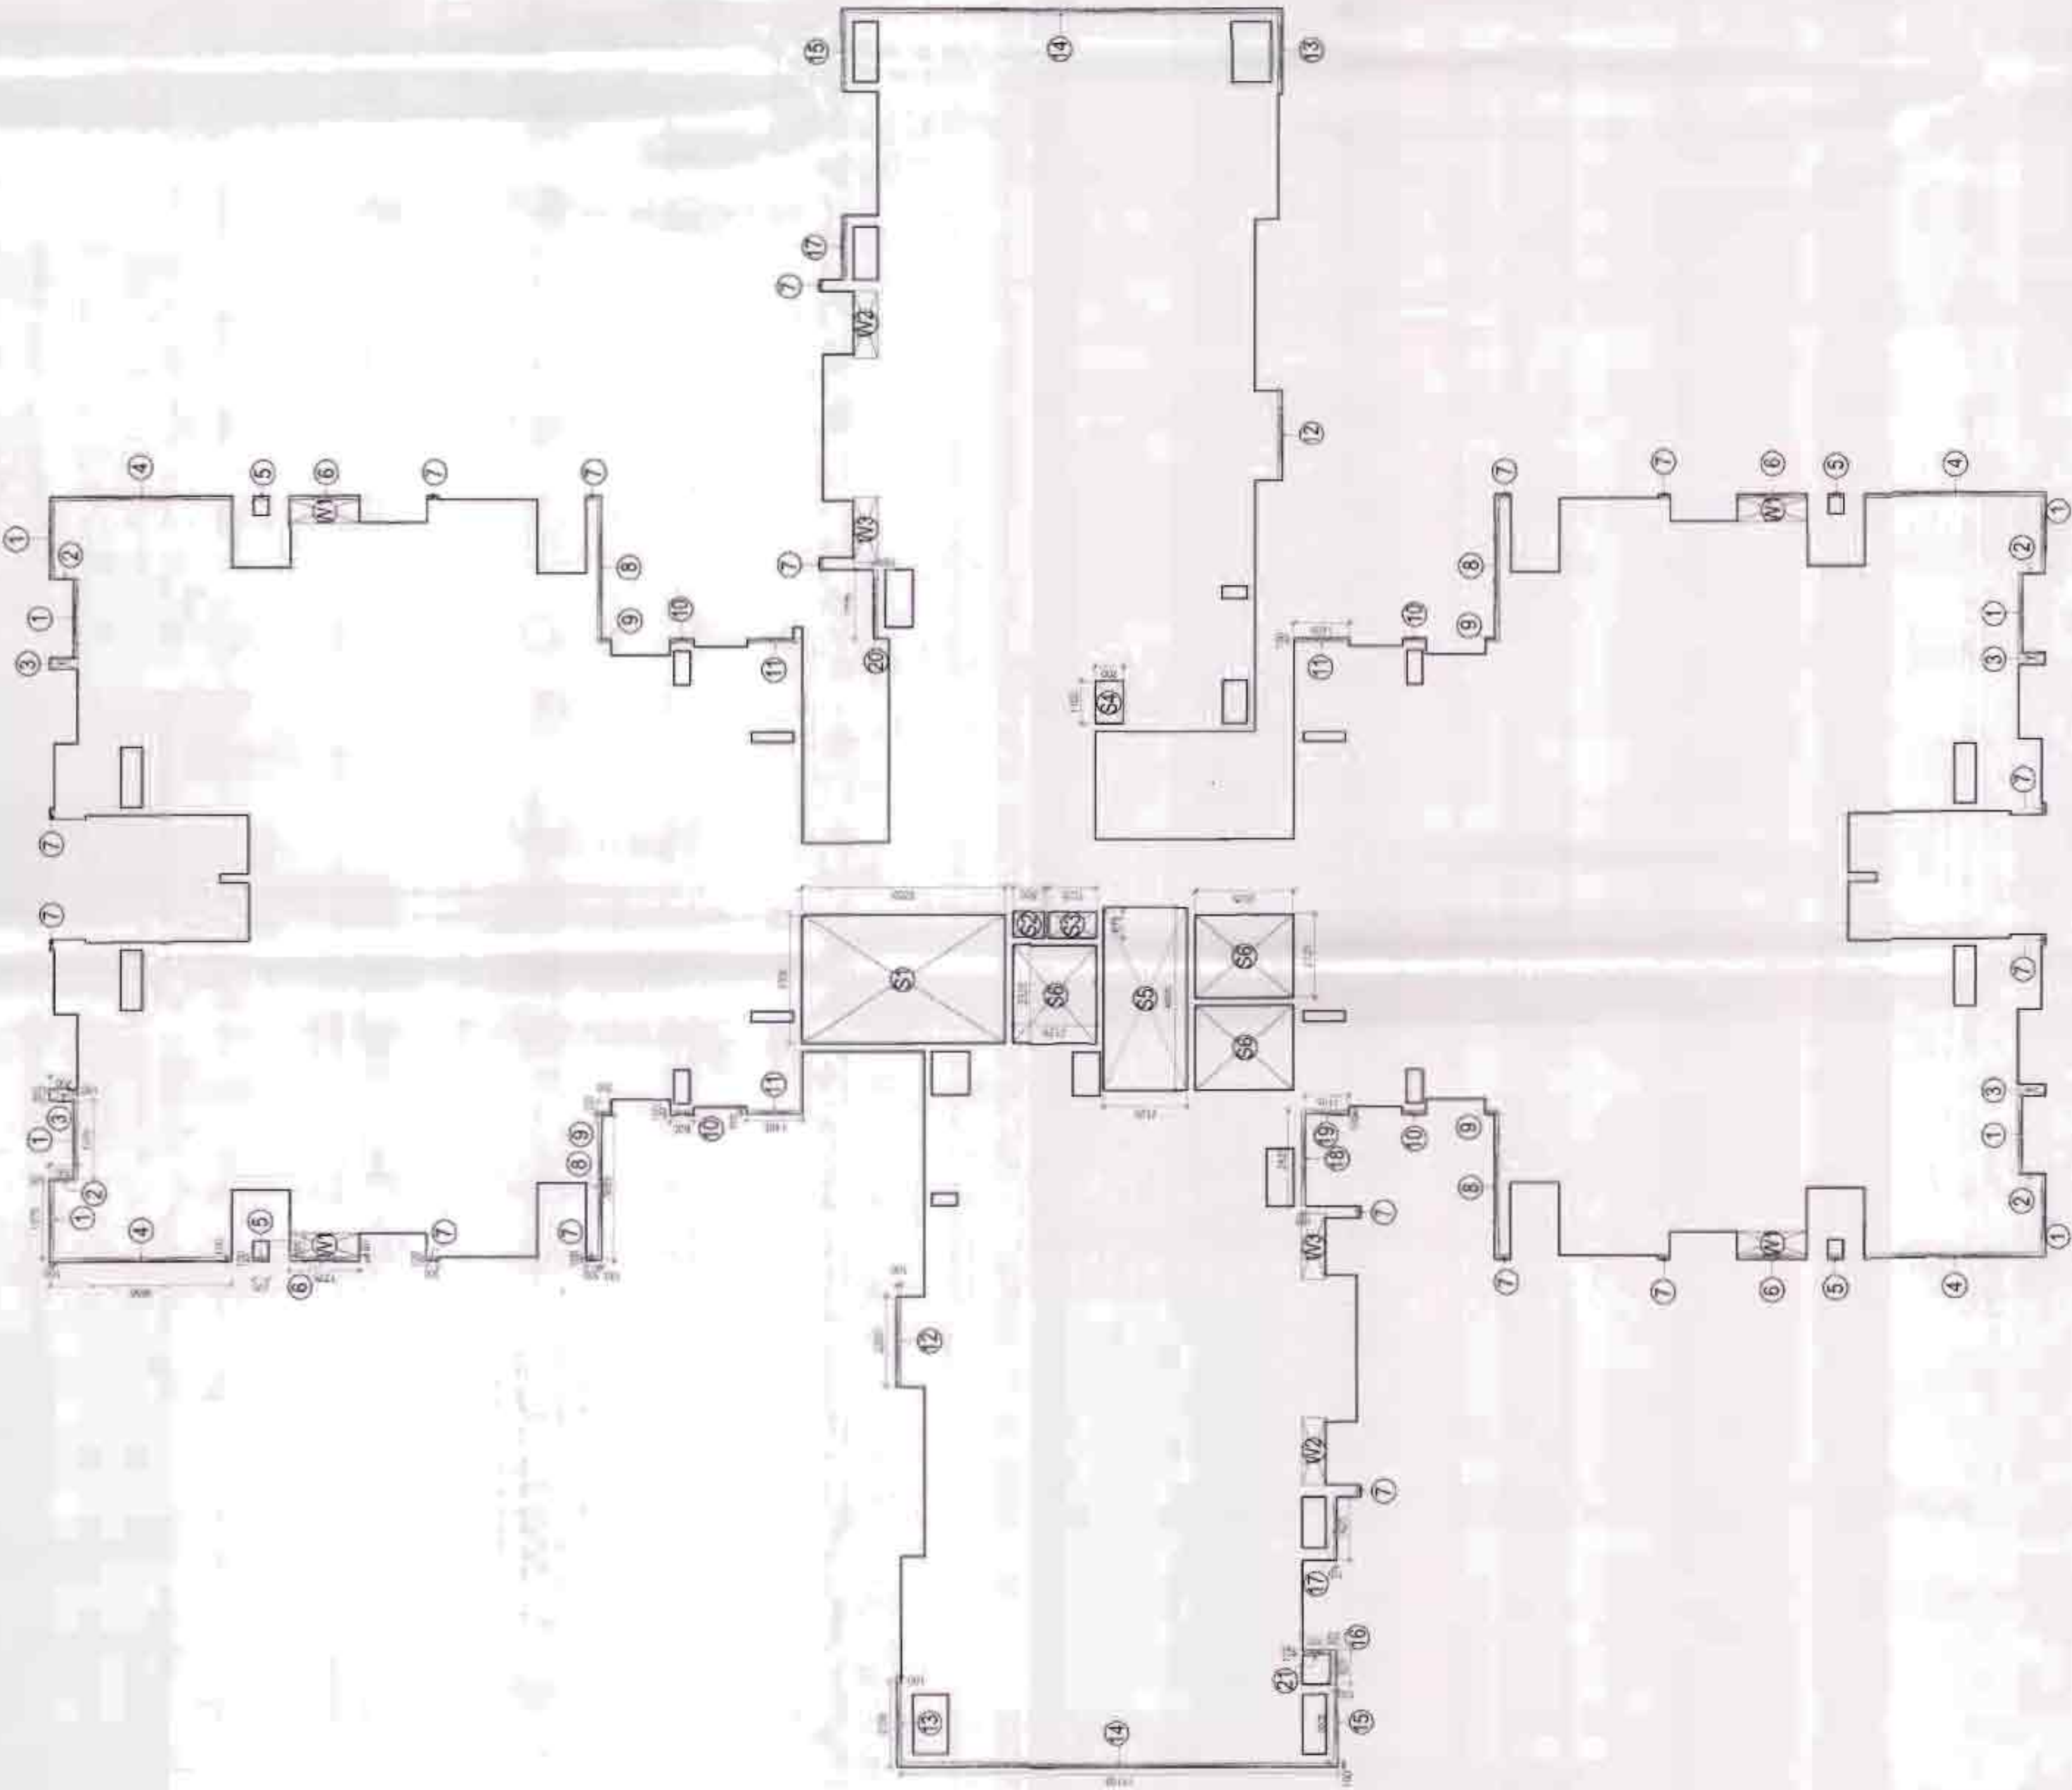

THIRD FLOOR AREA DIAGRAM
TYPICAL FOR 4TH TO 19TH FLOOR

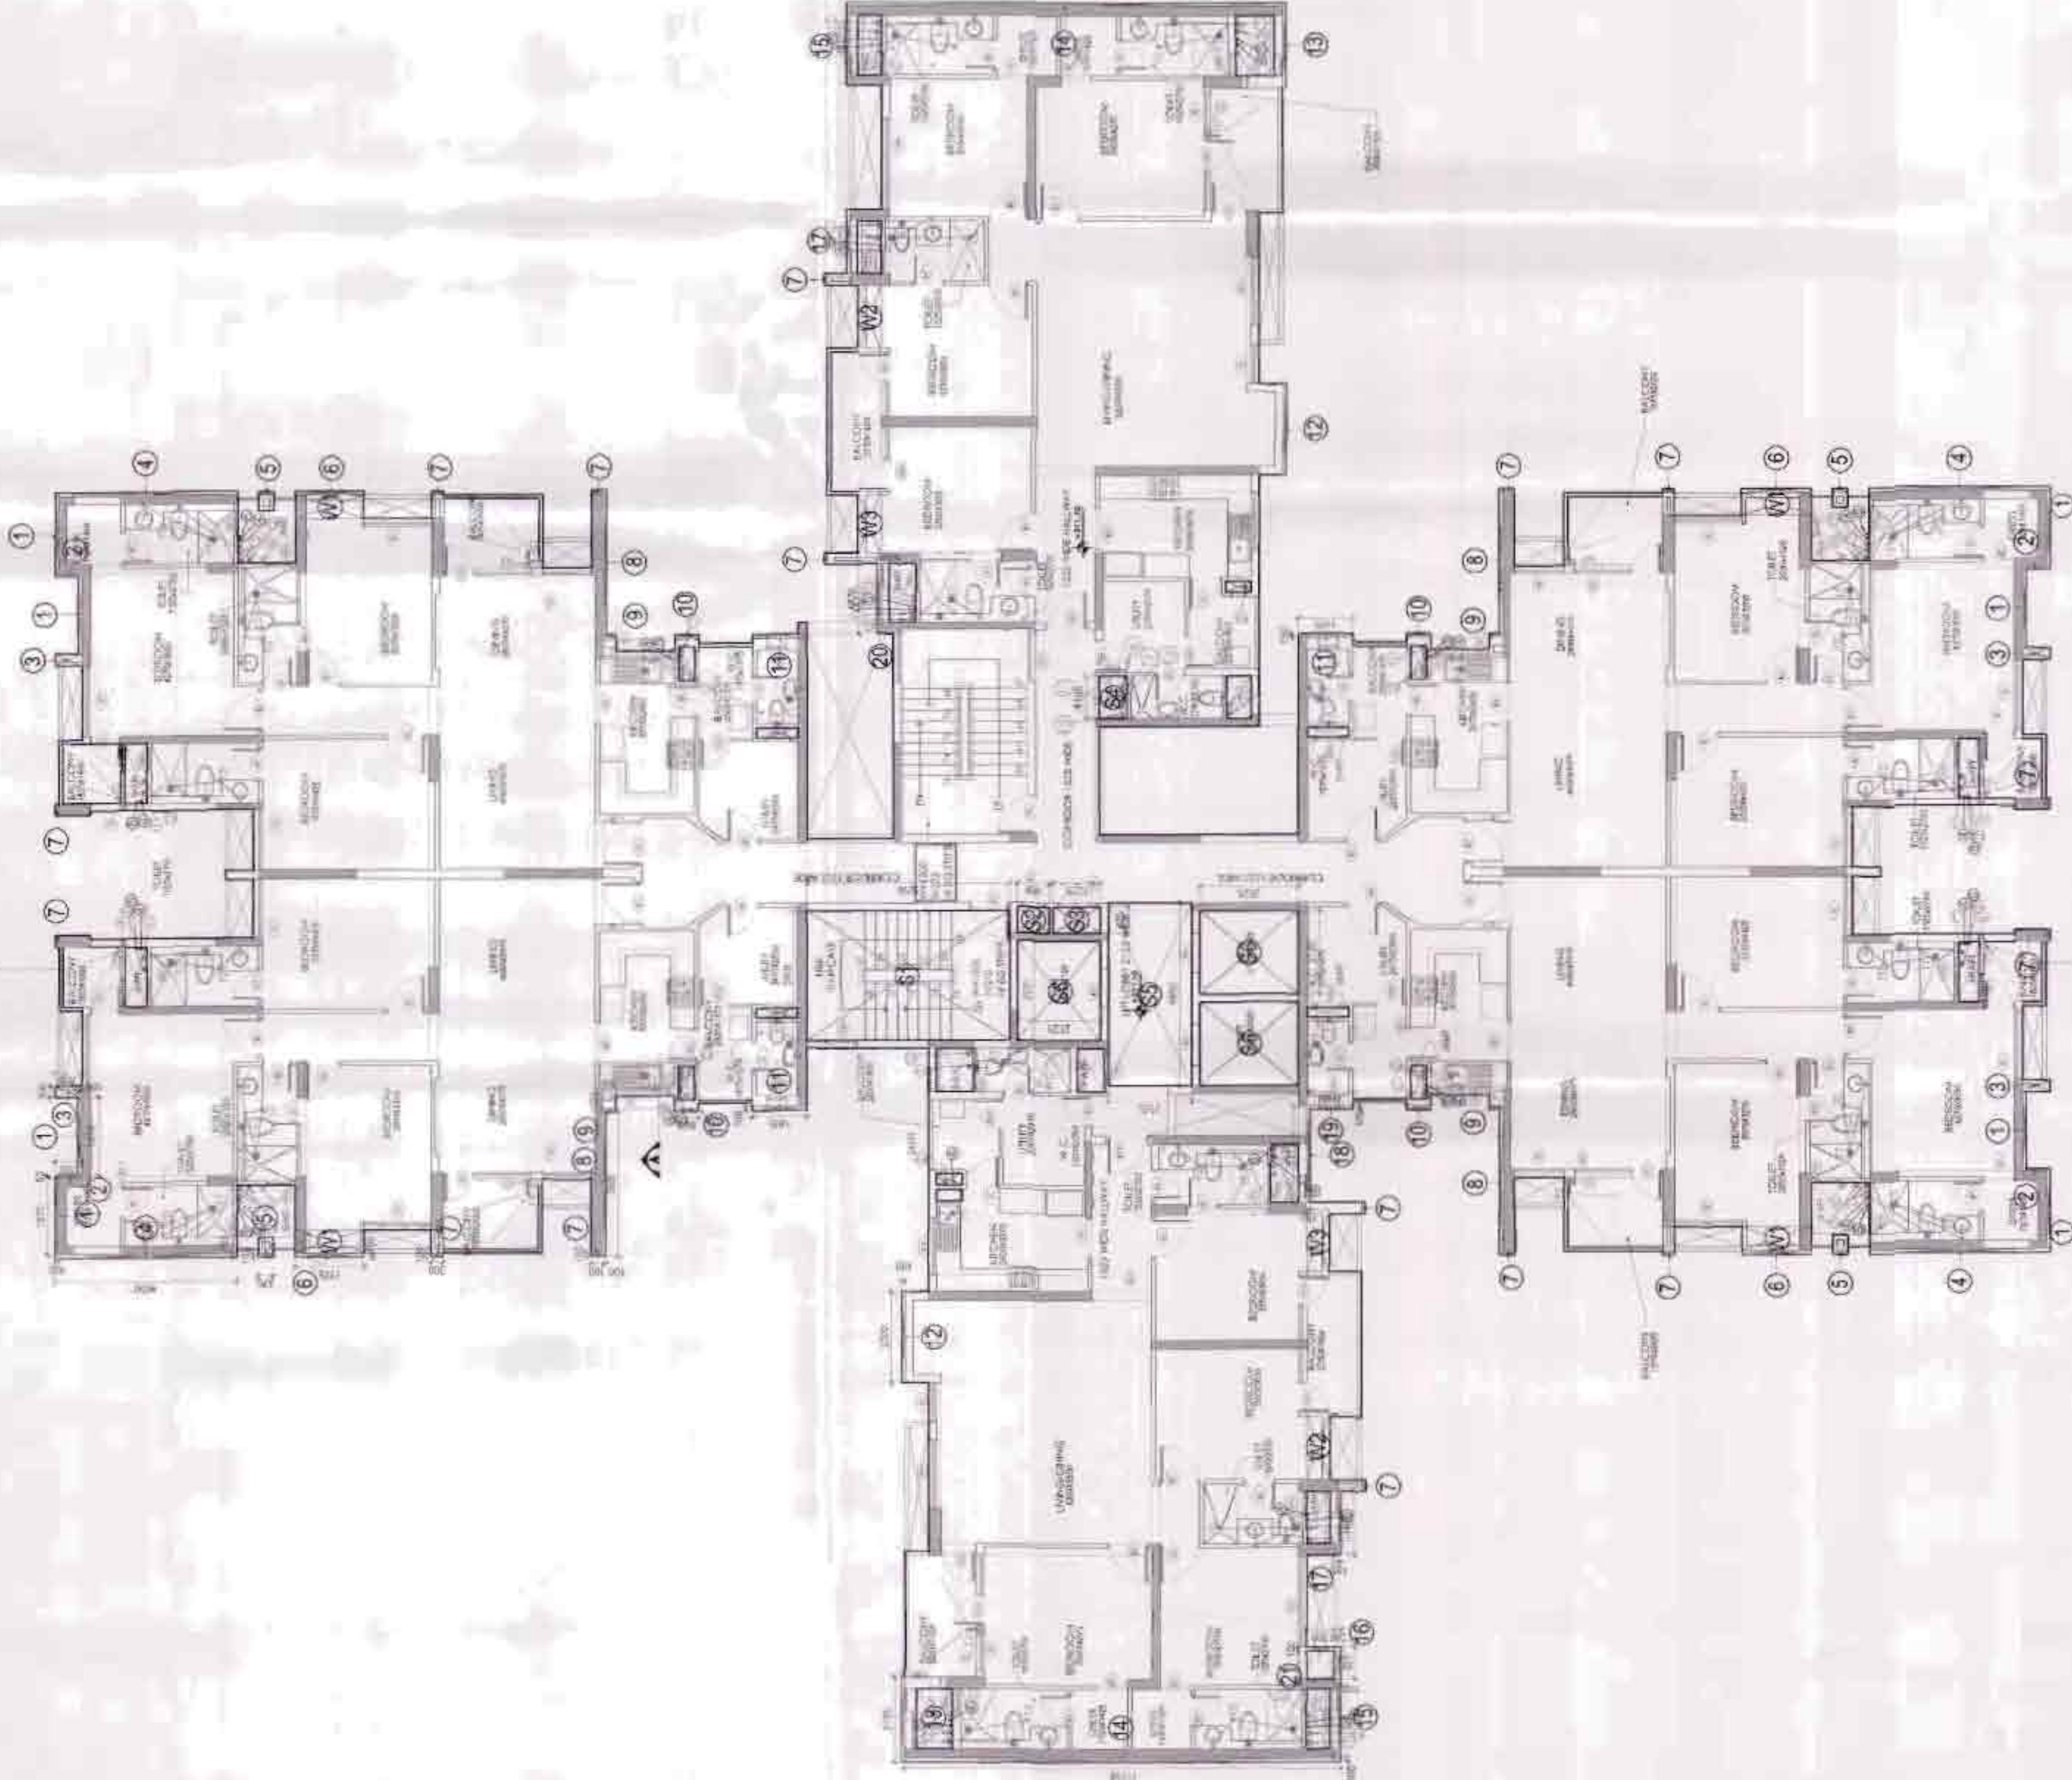

THIRD FLOOR PLAN
(TYPICAL FLOOR FOR 4TH TO 19TH FLOOR)

TYPICAL TOWER KNG-1					F.A.R. AREA ON THIRD FLOOR					999.58		
TOTAL F.A.R. ON FIRST FLOOR												
DEDUCTION AREA (B)												
Sr.No.	No.	Coff.	Breadth mm.	Length mm.	Area Sqmttr.							
1	8	1	1975	100	1.98							
2	4	1	50	700	0.14							
3	4	1	300	700	0.84							
4	4	1	100	4650	1.86							
5	4	1	100	375	0.15							
6	4	1	100	1775	0.71							
7	16	1	100	300	0.48							
8	4	1	3685	100	1.47							
9	4	1	100	350	0.14							
10	4	1	100	600	0.24							
11	3	1	100	1405	0.42							
12	2	1	2300	100	0.46							
13	2	1	2155	100	0.43							
14	2	1	11150	100	2.23							
15	2	1	2005	100	0.40							
16	1	1	825	200	0.17							
17	2	1	1625	100	0.33							
18	1	1	2425	100	0.24							
19	1	1	1105	100	0.11							
20	1	1	1775	100	0.18							
21	1	1	100	700	0.07							
TOTAL DEDUCTION					(B)	(C)	12.65					
TOTAL F.A.R. AREA (A + B + C)					966.73							