
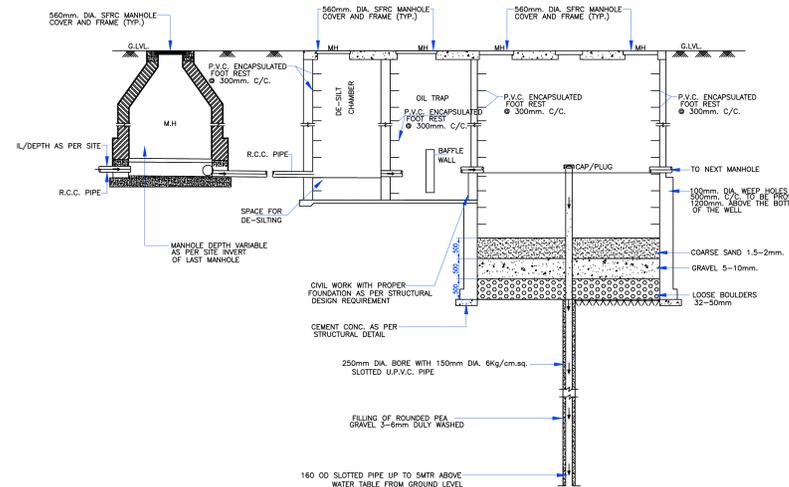
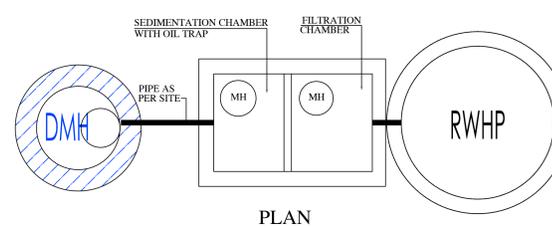


# EXTERNAL STORM WATER LAYOUT

LEGEND	
	STORM WATER LINE
	DRAINAGE MANHOLE
	CATCH BASIN
	RAIN WATER HARVESTING PIT
GL.	GROUND LEVEL
CL.	CONNECTION LEVEL
IL.	INVERT LEVEL

PIPE SIZE IN DIA(φ)	SLOPE
250	1:300
300	1:350
350	1:400

LEGEND	
	100φ BY PASS SEWER LINE
	SOIL PIPE
	WASTE PIPE
COP	CLEAN OUT PLUG

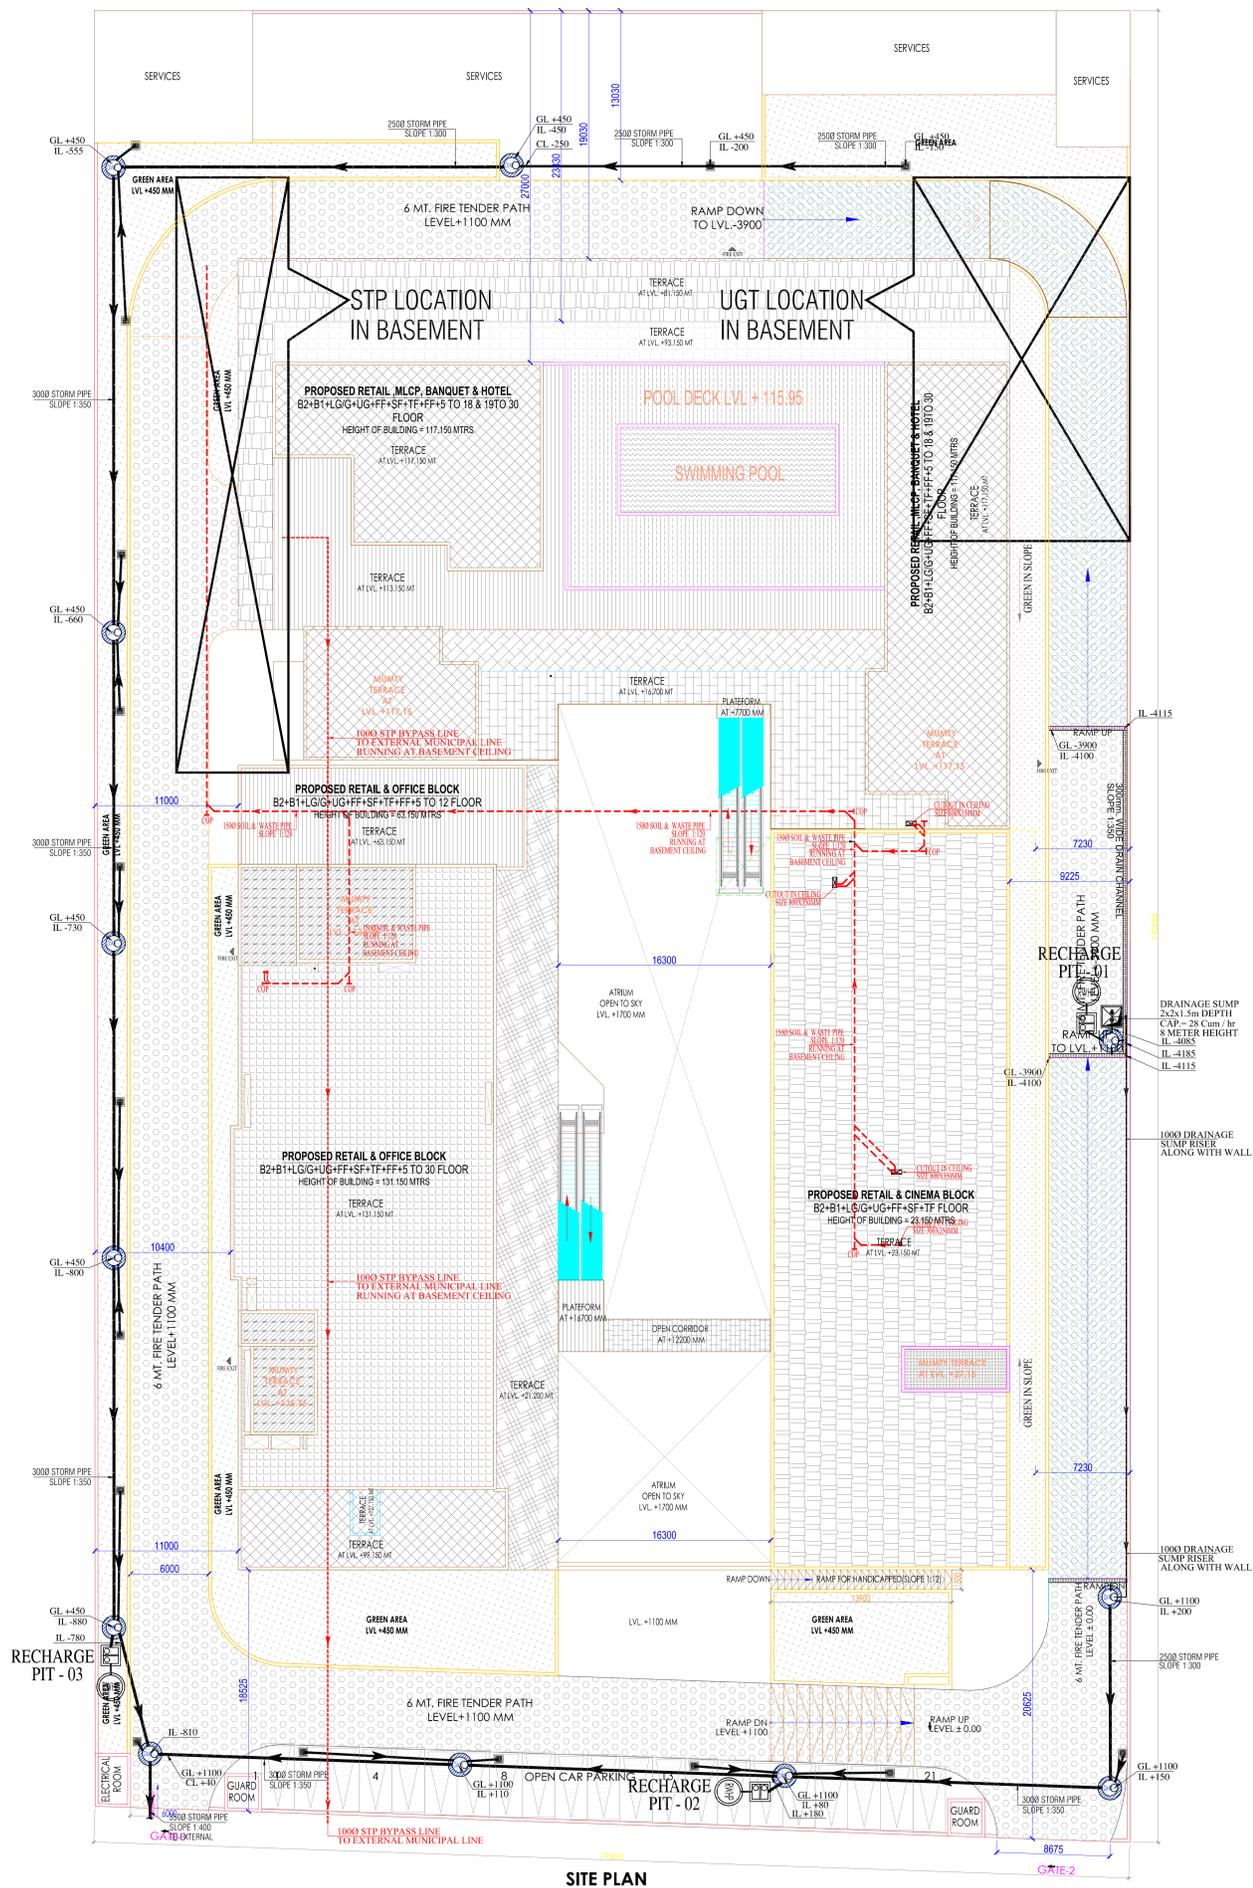

TYPICAL DETAIL OF RAIN WATER HARVESTING SYSTEM

- NOTES:
- ALL LIFTS SHALL HAVE 100% POWER BACK-UP.
  - ALL ELECTRICAL INSTALLATIONS SHALL BE AS PER PROVISION OF NBC.
  - FIRE-FIGHTING / SAFETY PROVISIONS SHALL BE AS PER RELEVANT NBC PROVISIONS.
  - BASEMENT AREA SHALL HAVE MECHANICALLY VENTILATED AS PER RELEVANT CODE.
  - ALL TOILETS ARE VENTILATED AS PER HARYANA BUILDING CODE 2017.
  - BUILDING WILL BE DESIGNED (STRUCTURES) AS PER RELEVANT I.S. CODES FOR EARTHQUAKE RESISTANCE.
  - ALL HIGH RISE BUILDING ARE INTERCONNECTED THROUGH CORRIDOR / BRIDGES.
  - SOLAR PANELS OF REQUIRED CAPACITY SHALL BE PROVIDED ON ROOF TOP AS PER HARYANA ZONING NORMS.
  - ONE EXTERNAL WALL TOWARDS BALCONY SIDE IN ANY ONE OF THE ROOMS IN RESIDENTIAL APARTMENT SHOULD BE IN 1 HR. FIRE RATED WITH PROVISION OF SPRINKLER ON INTERNAL SIDE OF THE SAME WALL.

KEY PLAN



CLIENT:-

M/S GRANITE HILLS PROPERTIES PVT LTD  
C-23 GREATER KAILASH ENCLAVE  
PART 1, NEW DELHI-110048

PROJECT:-

REVISED OF COMMERCIAL  
COMPLEX DOWNTOWN  
AT PLOT NO. C 1/B  
SECTOR - 98, NOIDA (U.P.)

PRINCIPAL ARCHITECT:

**ACPL** ISO 9001:2008  
ACPL Design Ltd  
www.acplnoida.com  
E: contact@acplnoida.com  
F: +91 11 24643458

OWNER/AUTH. SIGNATURE

ARCHITECT'S SIGNATURE

DRAWING TITLE

SITE PLAN

SEWERAGE & DRAINAGE SCHEME

DRAWING NO. PL-01

SCALE: 1:250