




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LIG TOWER
GROUND FLOOR ELECTRICAL PLAN

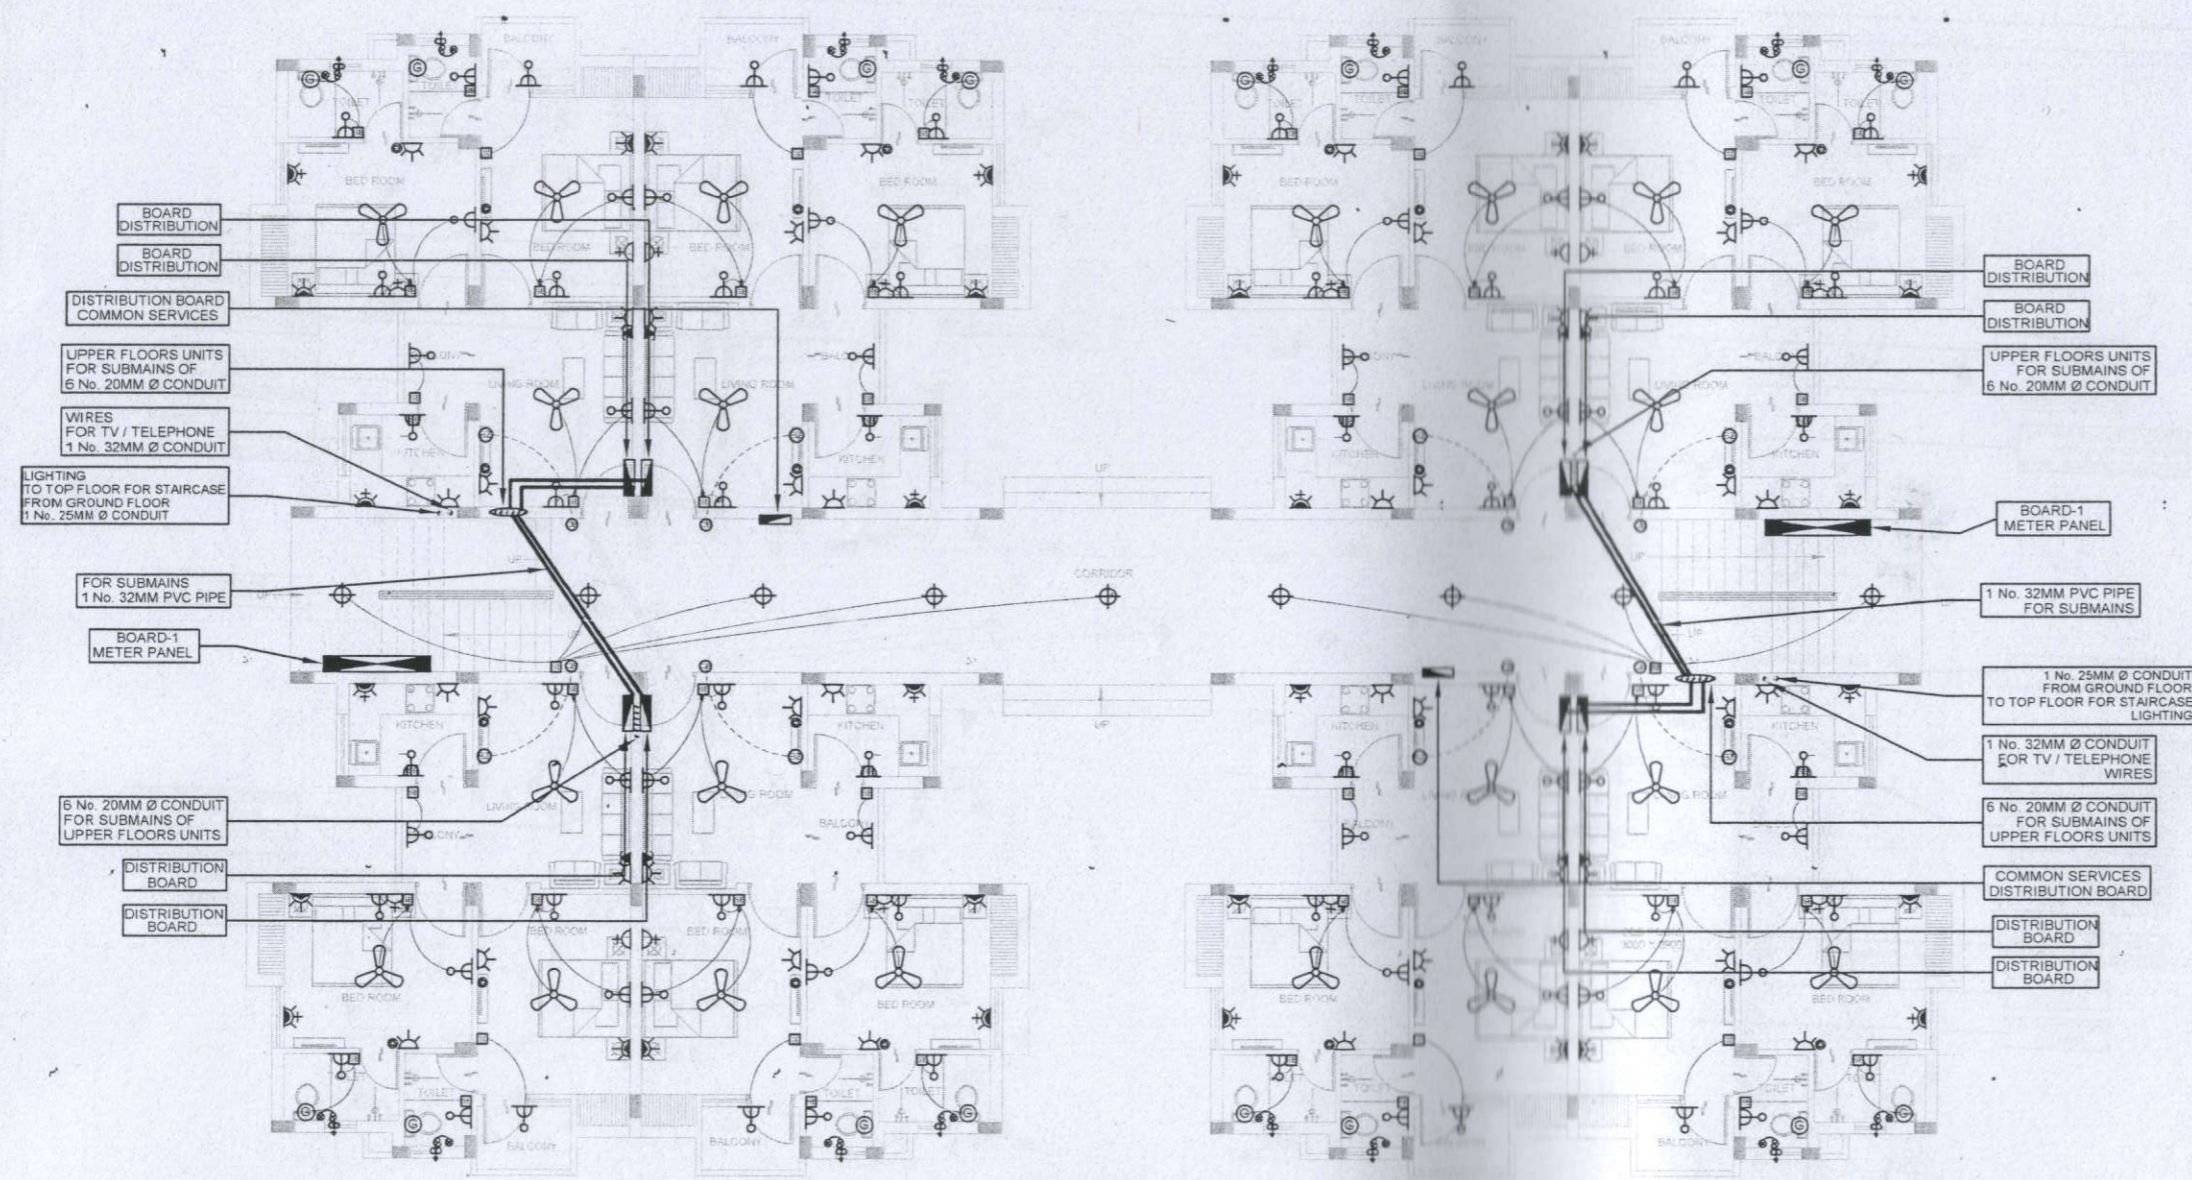

TYPICAL UNIT ELECTRICAL PLAN
(LIG)

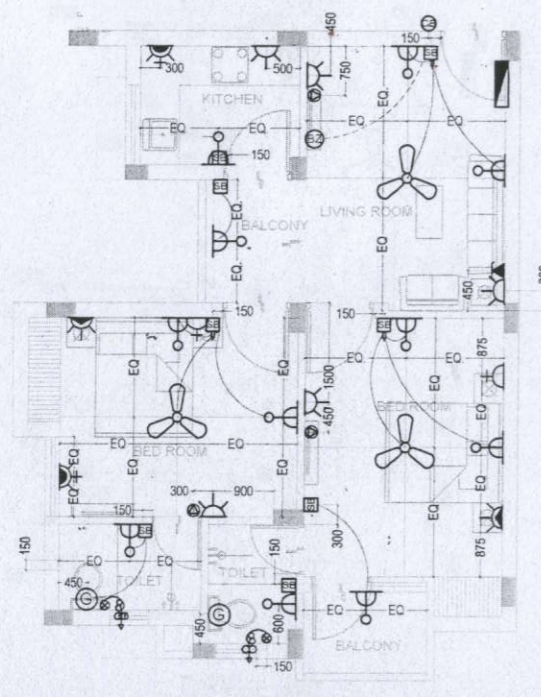


GROUND FLOOR STAIRCASE
LOBBY ELECTRICAL PLAN (LIG)

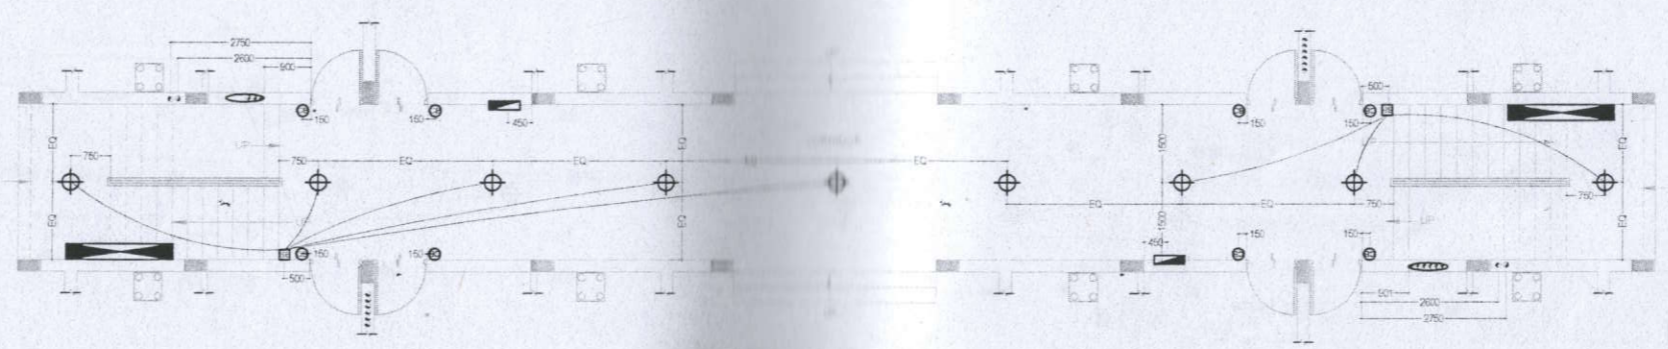- NOTES
1. ALL DESIGN DRAWINGS AND SAMPLES ARE PROPERTY OF ARCHITECT.
 2. ALL INFORMATION CONTAINED HERE IN IS FOR DESIGN PURPOSES ONLY.
 3. ALL DIMENSIONS ARE TO BE READ AND NOT MEASURED FROM THE DRAWING.
 4. ALL DIMENSIONS ARE TO BE VERIFIED & CONFIRMED BY CONTRACTOR ON SITE PRIOR TO COMMENCEMENT OF WORK. ANY DISCREPANCIES IN MEASUREMENTS AT SITE DURING LAYOUT TO BE NOTIFIED TO THE ARCHITECT IMMEDIATELY.
 5. ALL DISCREPANCIES ARE TO BE REFERRED TO THE ARCHITECT FOR CLARIFICATION PRIOR TO EXECUTION.
 6. NO STRUCTURAL CHANGES TO BE CARRIED OUT WITHOUT PRIOR CONSENT FROM STRUCTURAL CONSULTANT & STATUTORY AUTHORITIES.
 7. THIS DRAWING SHOULD BE READ IN CONJUNCTION WITH ALL RELEVANT STRUCTURAL, ARCHITECTURAL SERVICES & LANDSCAPE DWGS.
 8. FURNITURE/ FIXTURES SHOWN ARE INDICATIVE ONLY. PLEASE REFER RESPECTIVE DETAIL DRAWINGS & SCHEDULES.
 9. FOR DETAILS REFER RELEVANT LARGE SCALE DETAIL DRAWINGS AS INDICATED.

LEGEND - (electrical)

NO	SYMBOL	DESCRIPTION	POSITION
1	(Symbol)	LIGHT POINT	250
2	(Symbol)	1.5 AMP 150V MULTIPLE SOCKET OUTLET	200
3	(Symbol)	3 AMP MULTIPLE SOCKET OUTLET	200
4	(Symbol)	5 AMP MULTIPLE SOCKET OUTLET	200
5	(Symbol)	7.5 AMP MULTIPLE SOCKET OUTLET	200
6	(Symbol)	10 AMP MULTIPLE SOCKET OUTLET	200
7	(Symbol)	FAN POINT	200
8	(Symbol)	SWITCH BOARD	1500
9	(Symbol)	INDICATES POSITIONING OF LIGHTS FROM SWITCH BOARD	
10	(Symbol)	CABLE TIE	1200
11	(Symbol)	MURDER	3000
12	(Symbol)	DIFFERENTIAL BOARD	1500
13	(Symbol)	1.5 AMP CONDUIT FROM METER PANEL BOARD TO DISTRIBUTION BOARD	
14	(Symbol)	TRAIL BULB	1000
15	(Symbol)	FAN REGULATOR	1100mm
16	(Symbol)	CEILING ROSE FOR EXHAUST FAN (SWITCH SEPARATE)	2200mm
17	(Symbol)	TV SOCKET	750mm
18	(Symbol)	TELEPHONE POINT	750mm
19	(Symbol)	GIRDER	2250 mm

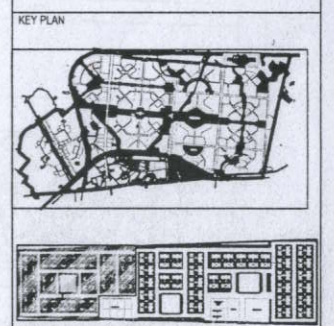

STRUCTURE CONSULTANT:

MEP CONSULTANT:

LANDSCAPE CONSULTANT:

ARCHITECT:
architect's avenue
D-2/122, Sambhav Tower, Vibhuti Khand,
Gomti Nagar, Lucknow, U.P.


PROJECT TITLE:
AFFORDABLE PM HOUSING, SECTOR-13,
VRINDAVAN YOJNA, LUCKNOW

DRAWING TITLE:
LIG TOWER
GROUND FLOOR ELECTRICAL PLAN


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DATE: 12.04.2018
DRAWING NO: PMH/SEC-13 / LIG&EWS HOISING /LIG_EL_01

REVISION:
A3 R1




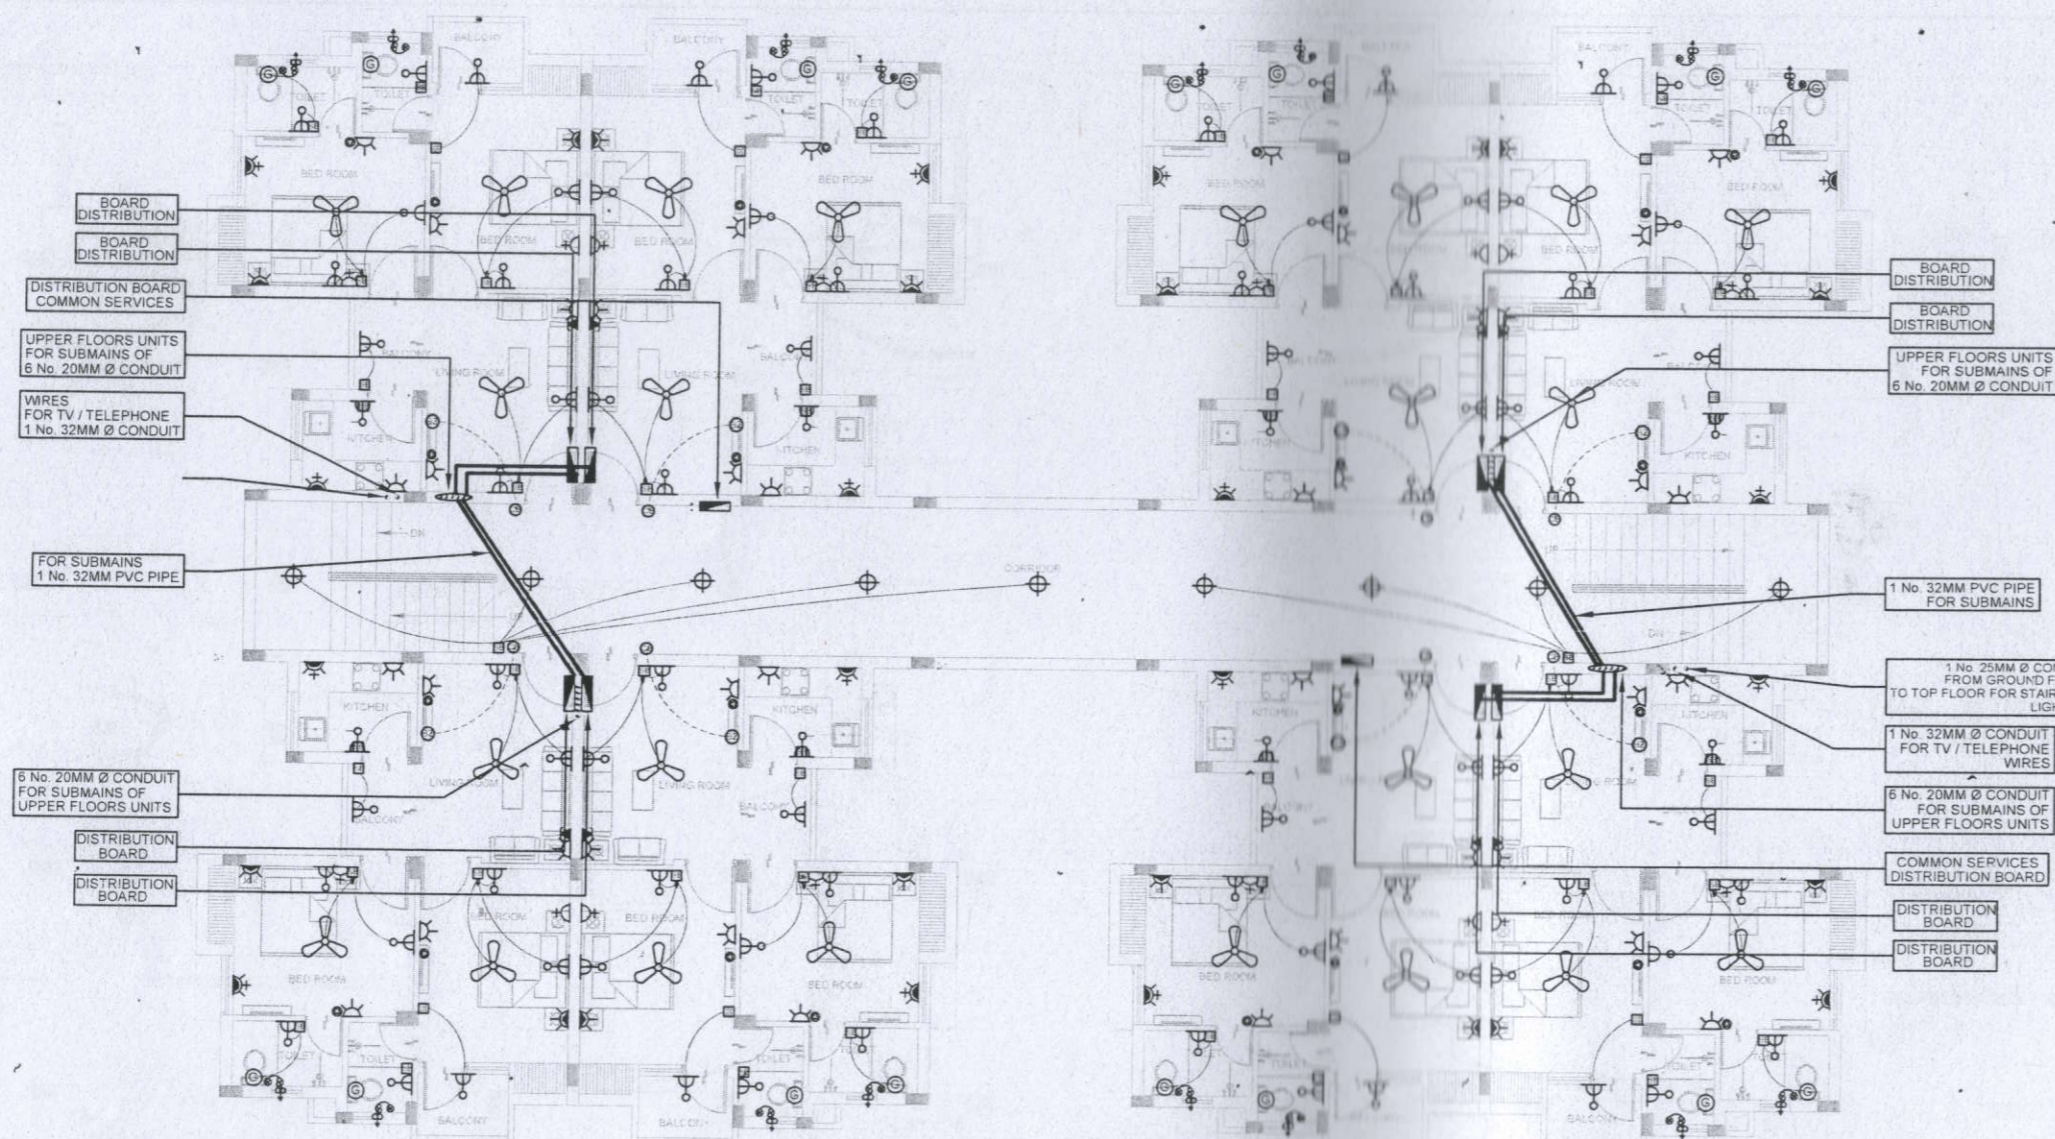

LIG TOWER
1st. TO 3rd. FLOOR ELECTRICAL PLAN

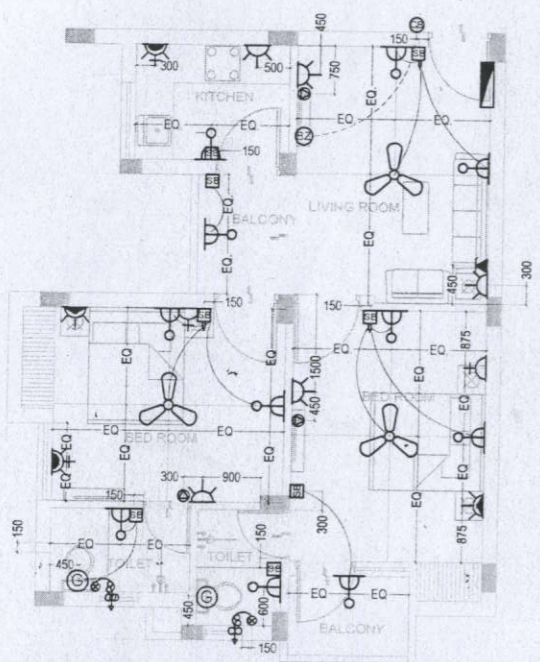

TYPICAL UNIT
(LIG)

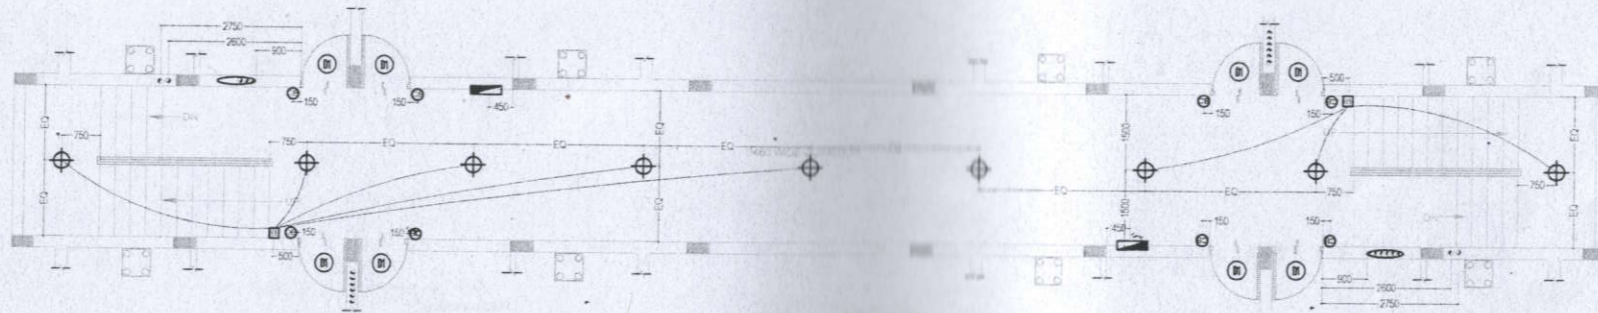


1st. TO 3rd. FLOOR STAIRCASE
LOBBY ELECTRICAL PLAN (LIG)

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LEGEND - (electrical)

Sl. No.	SYMBOL	DESCRIPTION	POSITION
1	(Symbol)	LIGHT POINT	2200
2	(Symbol)	20 AMP LIGHT SWITCH (15 AMP LIGHT SWITCH)	2200
3	(Symbol)	15 AMP MULTIPIN SOCKET OUTLET	2200
4	(Symbol)	20 AMP MULTIPIN SOCKET OUTLET	150
5	(Symbol)	15 AMP MULTIPIN SOCKET OUTLET	2200
6	(Symbol)	15 AMP MULTIPIN SOCKET OUTLET	150
7	(Symbol)	FAN POINT	2000
8	(Symbol)	SWITCH BOARD	1100
9	(Symbol)	INDICATED LIGHT POINTS & FAN POINTS (FOR EACH FLOOR)	1100
10	(Symbol)	CALL BELL	400
11	(Symbol)	BELL	2000
12	(Symbol)	DISTRIBUTION BOARD	1100
13	(Symbol)	CONDUIT FROM GROUND FLOOR TO TOP FLOOR FOR STAIRCASE LIGHTING	
14	(Symbol)	TAG BLOCK	1100
15	(Symbol)	FAN REGULATOR	1100
16	(Symbol)	FAN REGULATOR FOR COMMON FAN (SWITCH SEPARATE)	2200
17	(Symbol)	TV SOCKET	750
18	(Symbol)	TELEPHONE POINT	750
19	(Symbol)	C/SB	2200

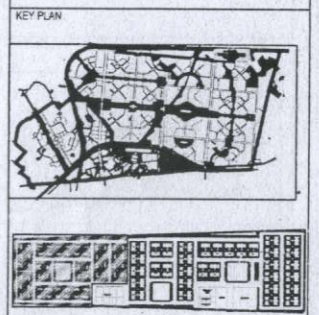

STRUCTURE CONSULTANT :
 MEP CONSULTANT :
 LANDSCAPE CONSULTANT :
 ARCHITECT :
architect's avenue
 D-2/122, Sambhav Tower, Vibhuti Khand,
 Gomti Nagar, Lucknow, U.P.



PROJECT TITLE:
 AFFORDABLE PM HOUSING, SECTOR-13,
 VRINDAVAN YOJNA, LUCKNOW

DRAWING TITLE:
 LIG TOWER
 1st TO 3rd FLOOR ELECTRICAL PLAN

CHECKED BY :
 DRAWN BY :
 SCALE : 1:100
 DATE : 12.04.2016

DRAWING NO :
 PMH/SEC-13 / LIG/EWS HOUSING / LIG E1_02

REVISION:
A3 R1