


CALCULATION OF COMMUNITY-1

S.NO	LENGTH	WIDTH	AREA (SQ.MT.)
1	1.110	1.525	1.693
2	1.260	0.925	1.166
3	2.615	4.590	12.003
4	1.895	10.510	19.916
5	4.170	9.670	40.324
6	2.540	9.440	23.978
7	1.110	1.525	1.693
8	1.260	0.925	1.166
TOTAL AREA			= 101.937

AREA = (23.050 X 25.440) = 586.646 -
101.937 (LESS AREA) = 484.709 SQ.MT.

FIRE STAIRCASE AREA DIAGRAM

S.NO	LENGTH	WIDTH	AREA (SQ.MT.)
1	3.845	3.595	13.823
TOTAL			= 13.823


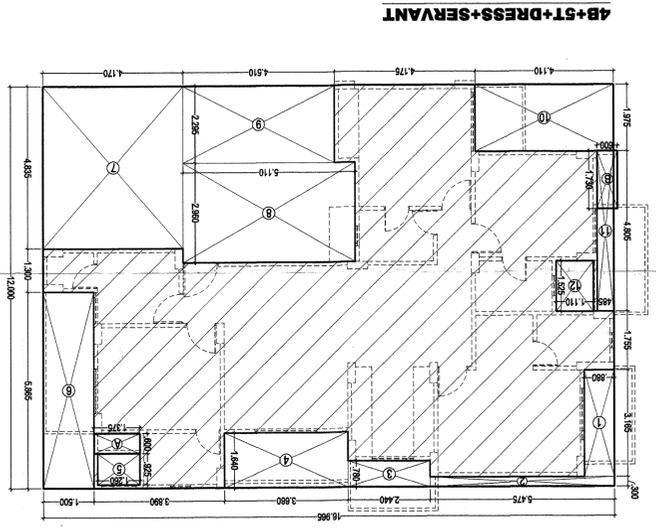


4B+5T+DRESS+SERVANT

S.NO	LENGTH	WIDTH	AREA (SQ.MT.)
1	0.880	3.165	2.785
2	5.475	0.300	1.643
3	2.440	0.780	1.903
4	3.660	1.640	6.002
5	1.260	0.925	1.166
A	1.375	0.600	0.825
6	1.500	5.865	8.798
7	4.170	4.835	20.162
8	4.510	2.295	10.350
9	4.510	1.975	8.117
10	4.110	1.975	8.117
11	0.485	4.805	2.330
12	1.110	1.525	1.693
TOTAL			= 80.900


CUP-BEARD AREA CALCULATION
(Not include in F.A.R.)

S.NO	LENGTH	WIDTH	AREA (SQ.MT.)
A	1.375	0.600	0.825
B	0.600	1.730	1.038
TOTAL			= 1.863

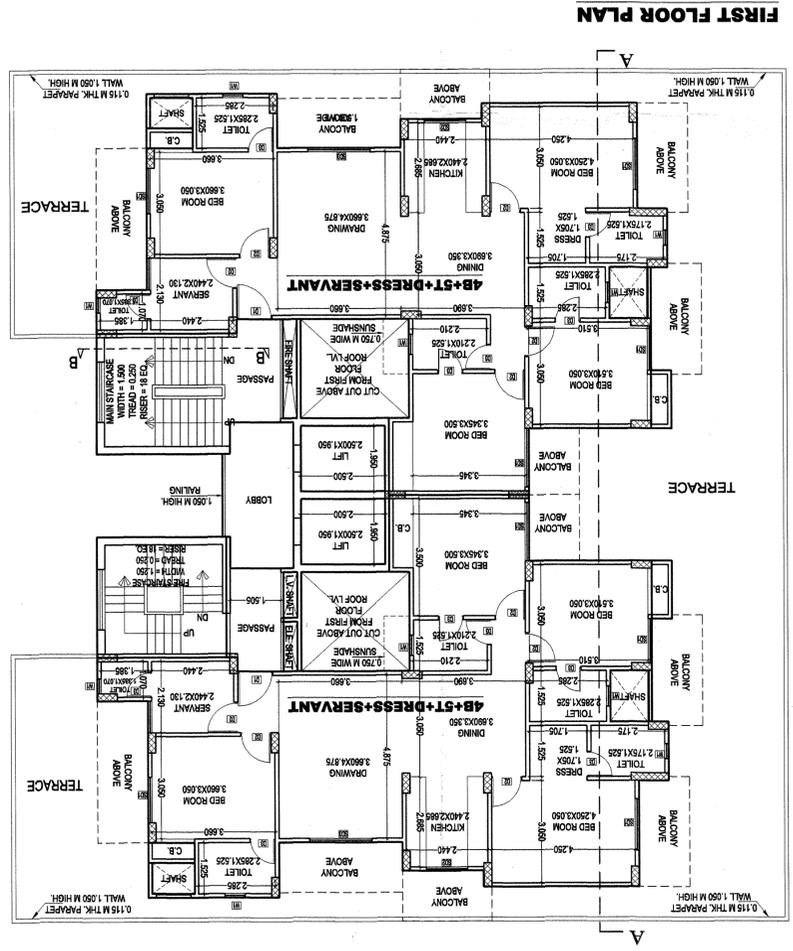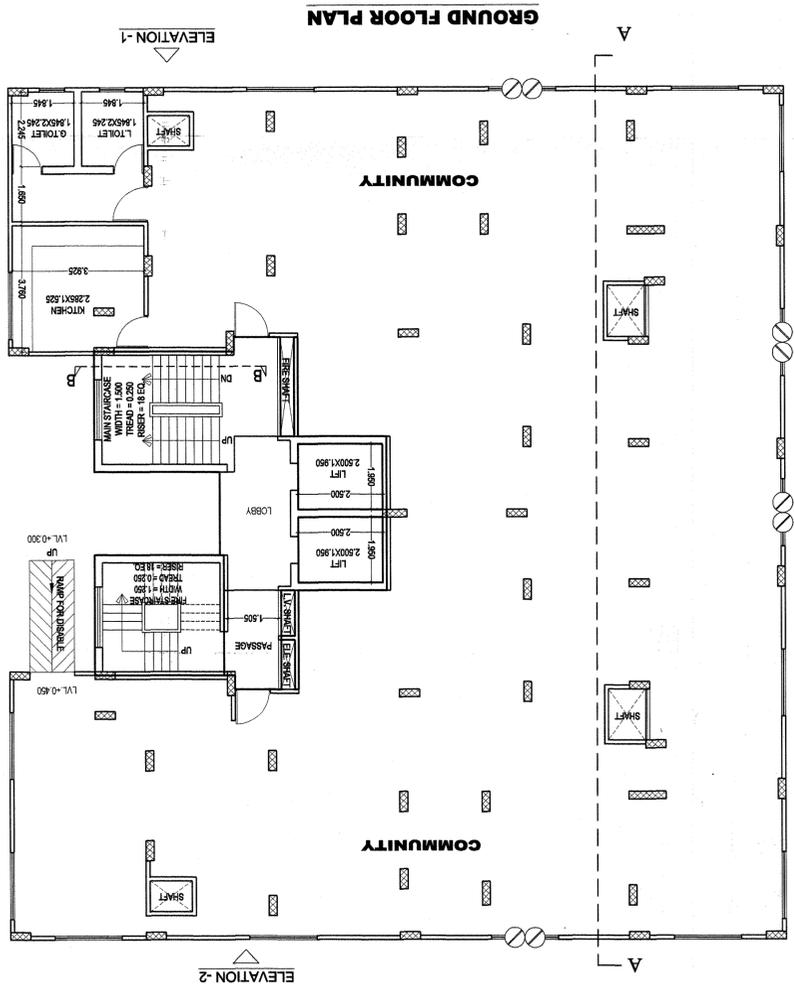

LIFT LOBBY AREA (SQ.MT.)


S.NO	LENGTH	WIDTH	AREA (SQ.MT.)
B	1.875	0.940	1.763
C	2.105	2.480	5.220
D	1.875	0.940	1.763
TOTAL			= 8.745

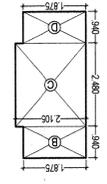

GROUND FLOOR AREA CALCULATION

S.NO	LENGTH	WIDTH	AREA (SQ.MT.)
1	1.375	0.420	0.578
2	1.700	3.595	6.112
3	0.405	0.115	0.047
4	0.115	10.510	1.209
5	2.615	4.590	12.003
6	0.405	4.590	1.859
7	1.815	2.480	4.501
8	5.545	3.595	19.934
9	1.375	0.420	0.578
TOTAL CORE AREA			= 46.819

GROUND COVERAGE AREA DETAIL =
[COMMUNITY+TOTAL CORE AREA + FIRE STAIR]
= 584.709 + 46.819 + 13.823 = 645.351 SQ.MT.

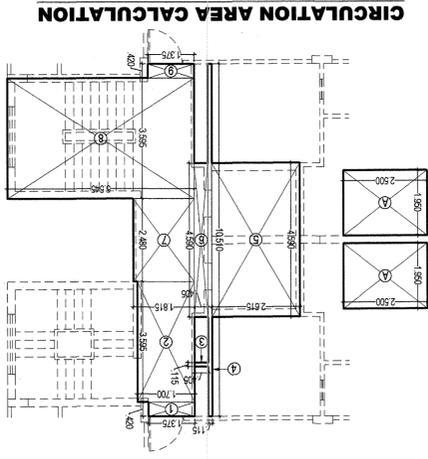

PROJECT TITLE: REVISED GROUP HOUSING AT PLT NO.GH-17, SEC-75,NOIDA. FOR. M/S MAXBILIS CONSTRUCTION PVT. LTD.

DRAWING TITLE: GR.COMMUNITY, FIRST FLOOR PLAN, TOWER-1 (G+C+18)

SCALE: 1:100

DATE: 20180904

JOB NO.: 1201222, SUBMISSION

DEPAK MEHTA & ASSOCIATES: ARCHITECTS, PLANNERS, VALUERS, LANDSCAPE ARCHITECTS, INTERIORS DESIGNERS, ENVIRONMENTALISTS, PROJECT MANAGERS, ETC.

ARCHITECTS SIGN: DEPAK MEHTA & ASSOCIATES

OWNERS SIGN: M/S MAXBILIS CONSTRUCTION PVT. LTD.

DOORS & WINDOWS SCHEDULE

S.NO.	TYPE	SIZE	QTY
1	D1	1.050x2.100	400
2	D2	0.800x2.100	400
3	D3	0.750x2.100	400
4	D4	0.650x2.100	400
5	D5	1.000x2.100	400
6	SD1	1.800x2.500	400
7	SD2	1.200x2.500	400
8	SD3	1.800x2.500	400
9	SD4	1.500x2.500	400
10	DWB	1.160x2.500	400
11	SC6	2.100x2.500	400
12	W1	0.800x1.450	1,050
13	W2	0.800x1.450	1,050
14	W3	0.815x1.800	4,900
15	W4	0.665x1.800	4,900
16	W5	0.650x1.800	4,900