




FIRST FLOOR PLAN
SCALE 1:200

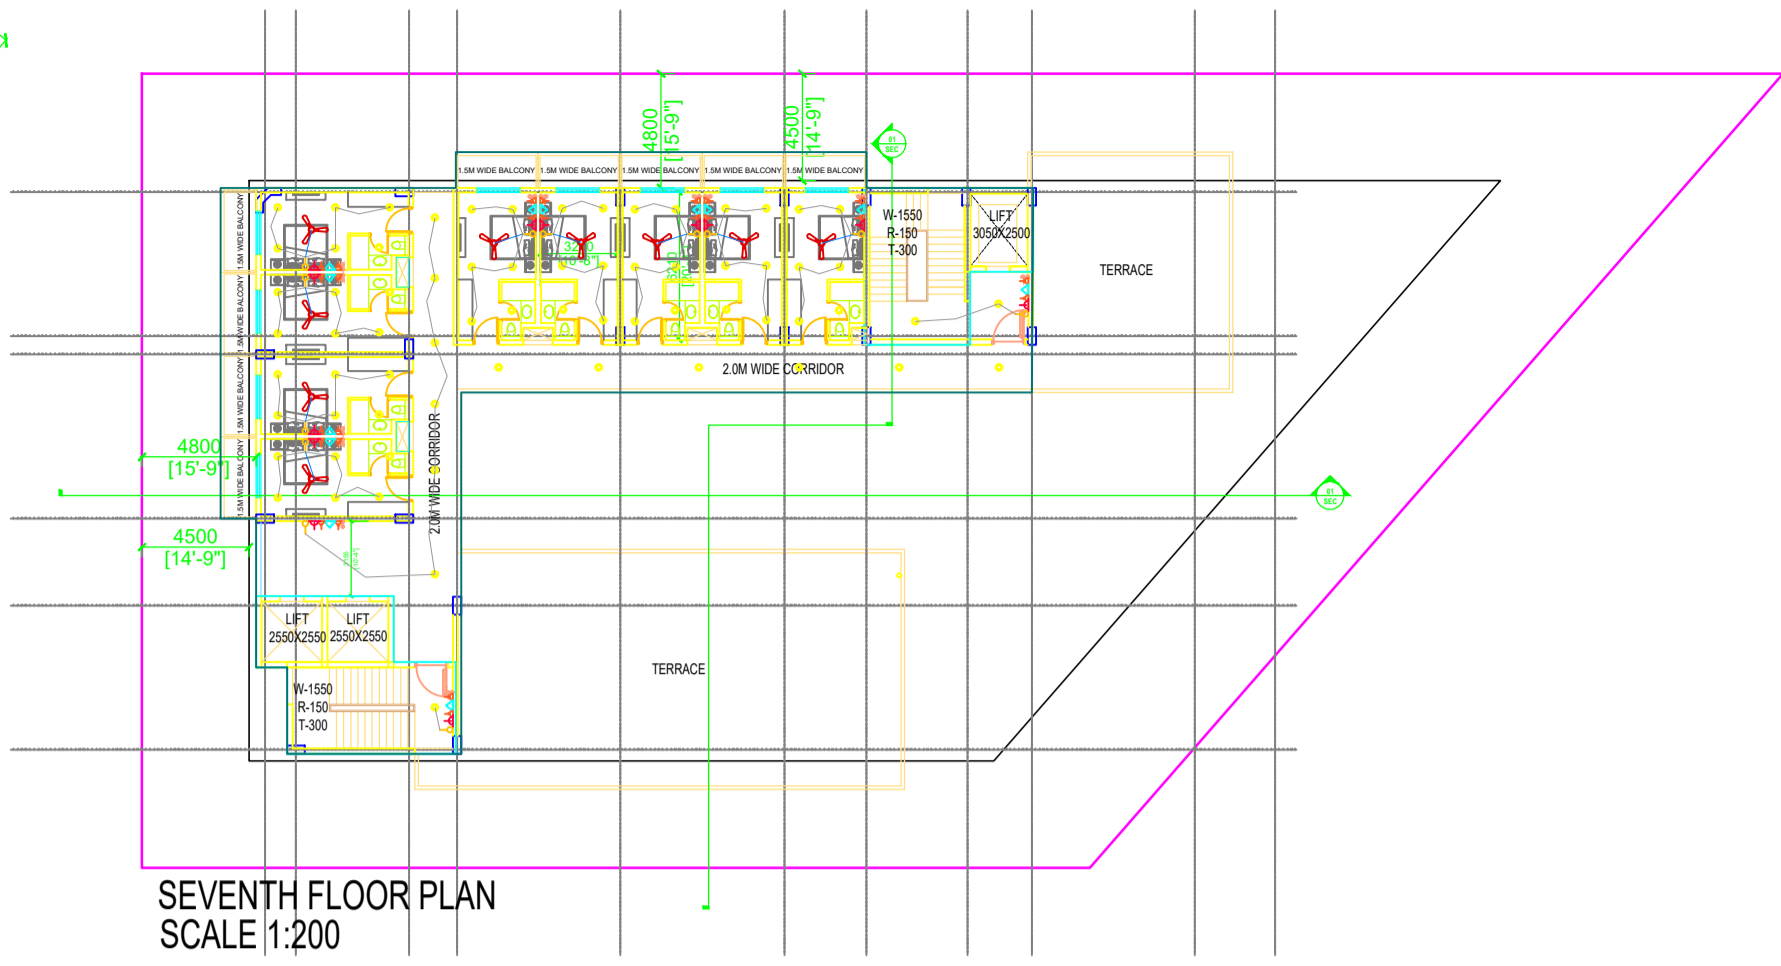


SEVENTH FLOOR PLAN
SCALE 1:200

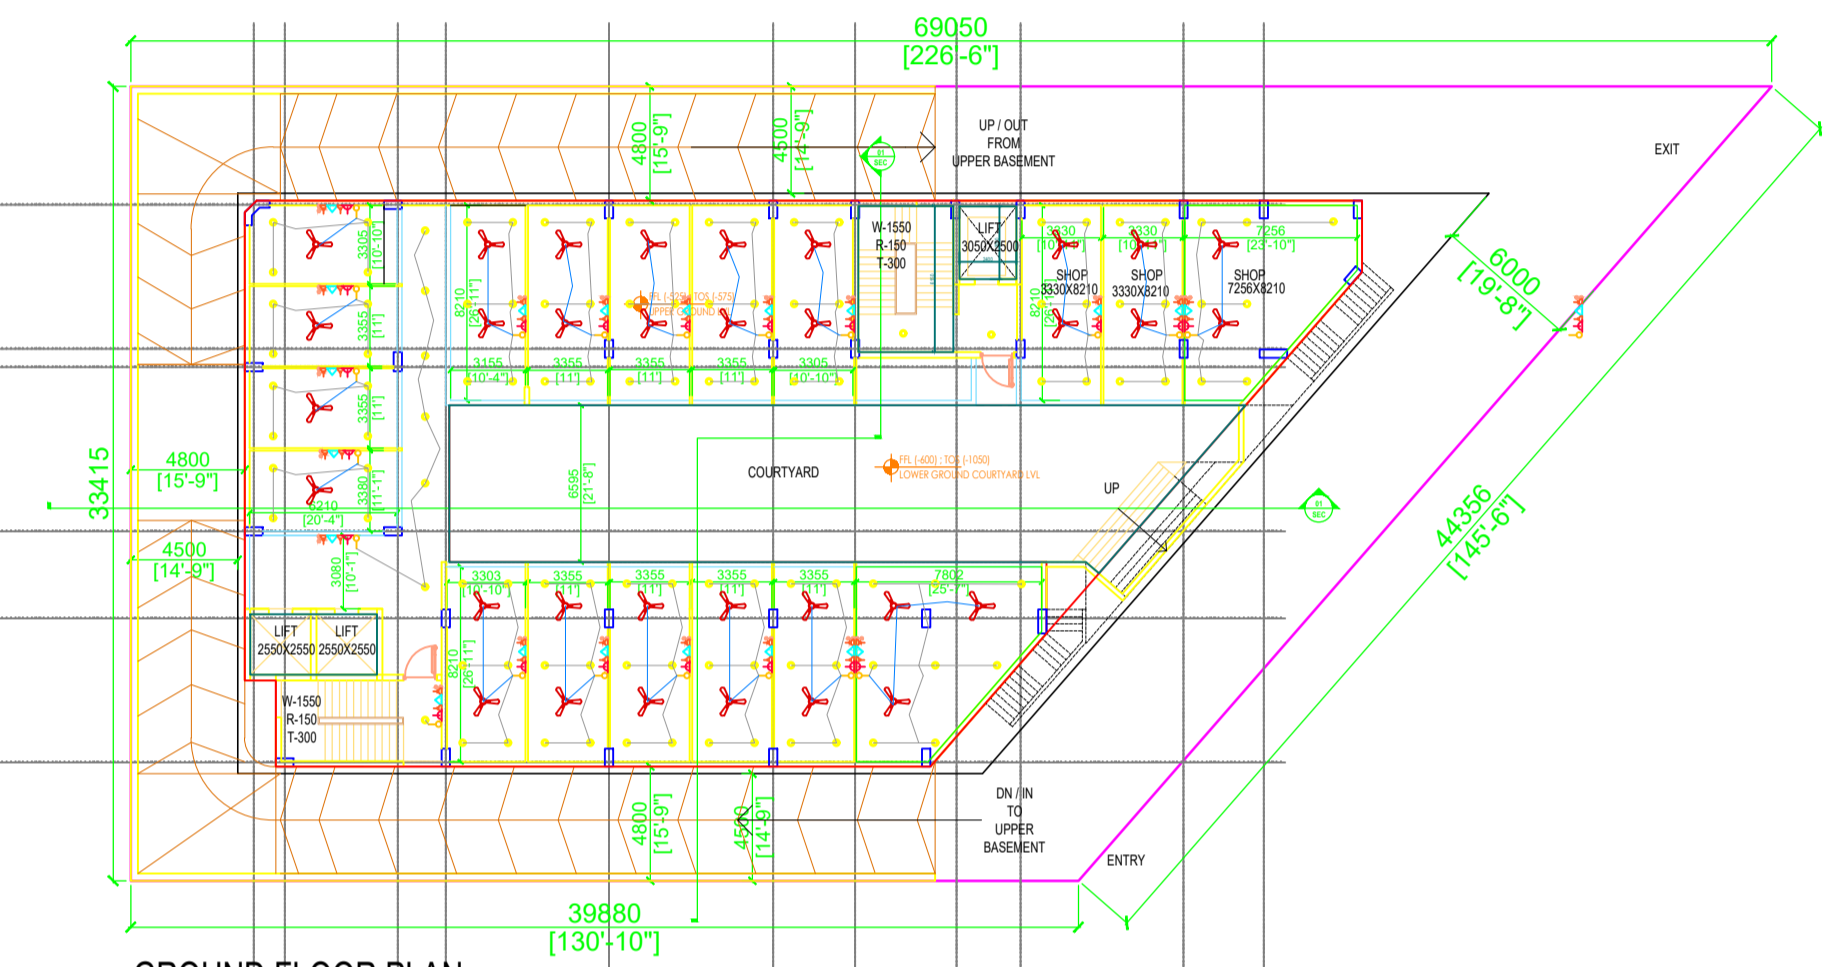


GROUND FLOOR PLAN
SCALE 1:200

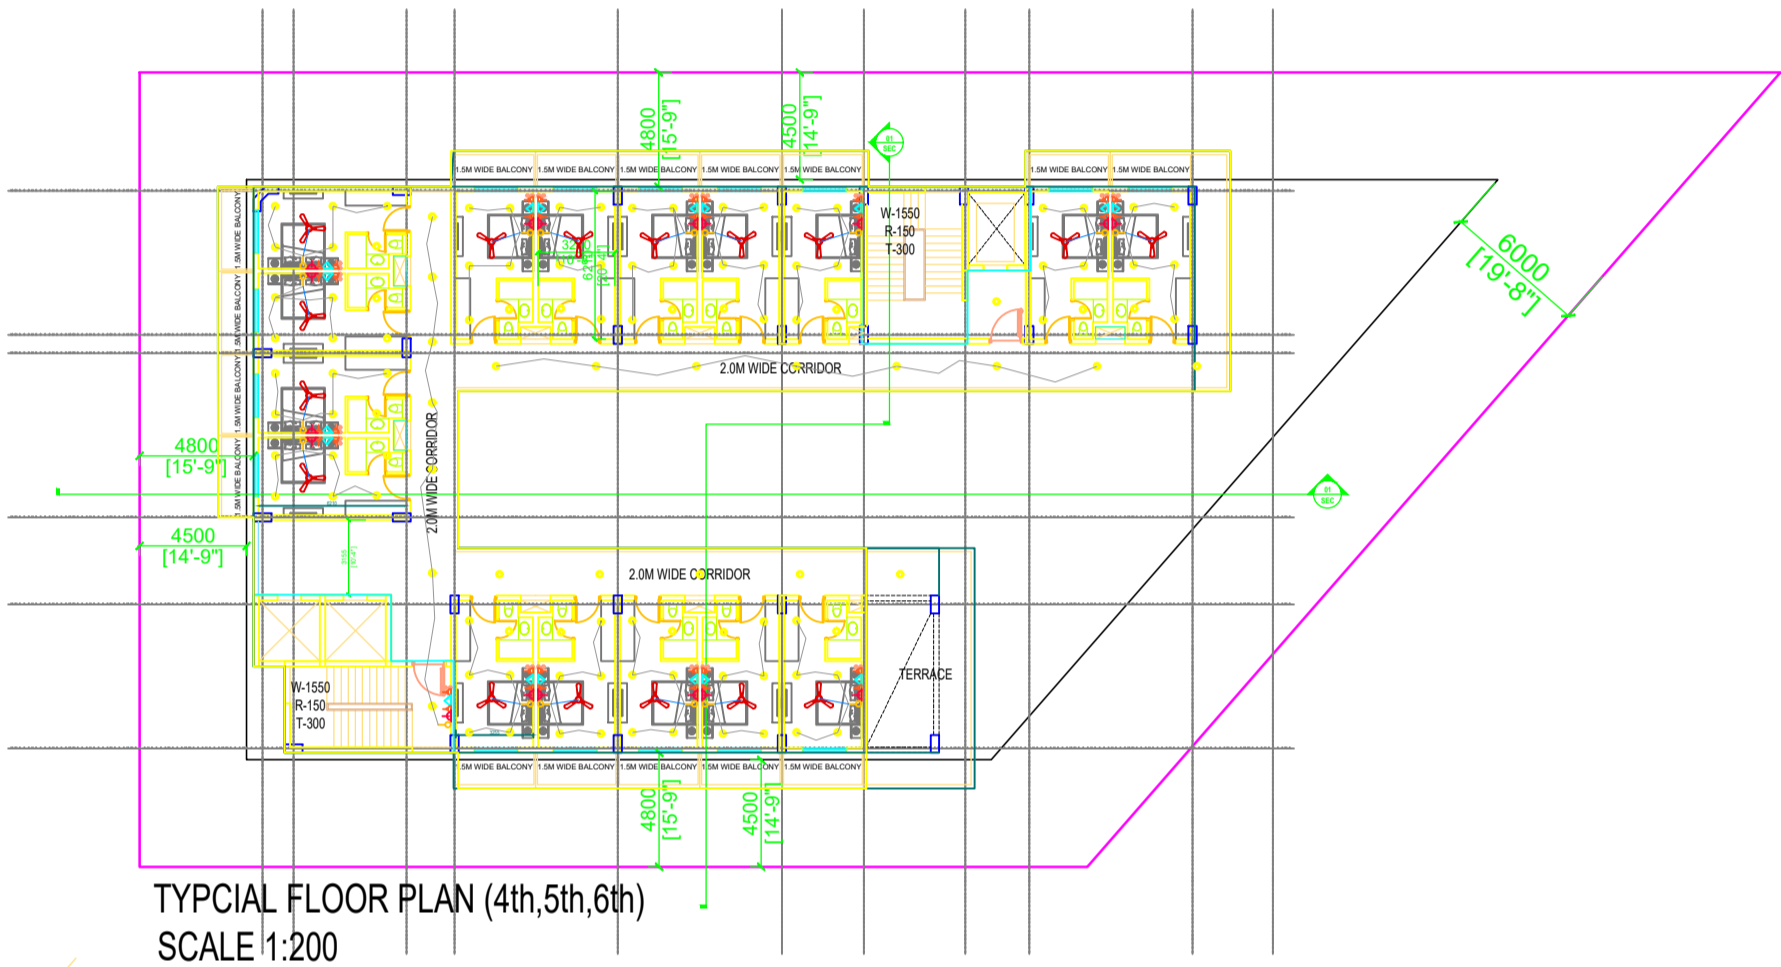


TYPICAL FLOOR PLAN (4th,5th,6th)
SCALE 1:200

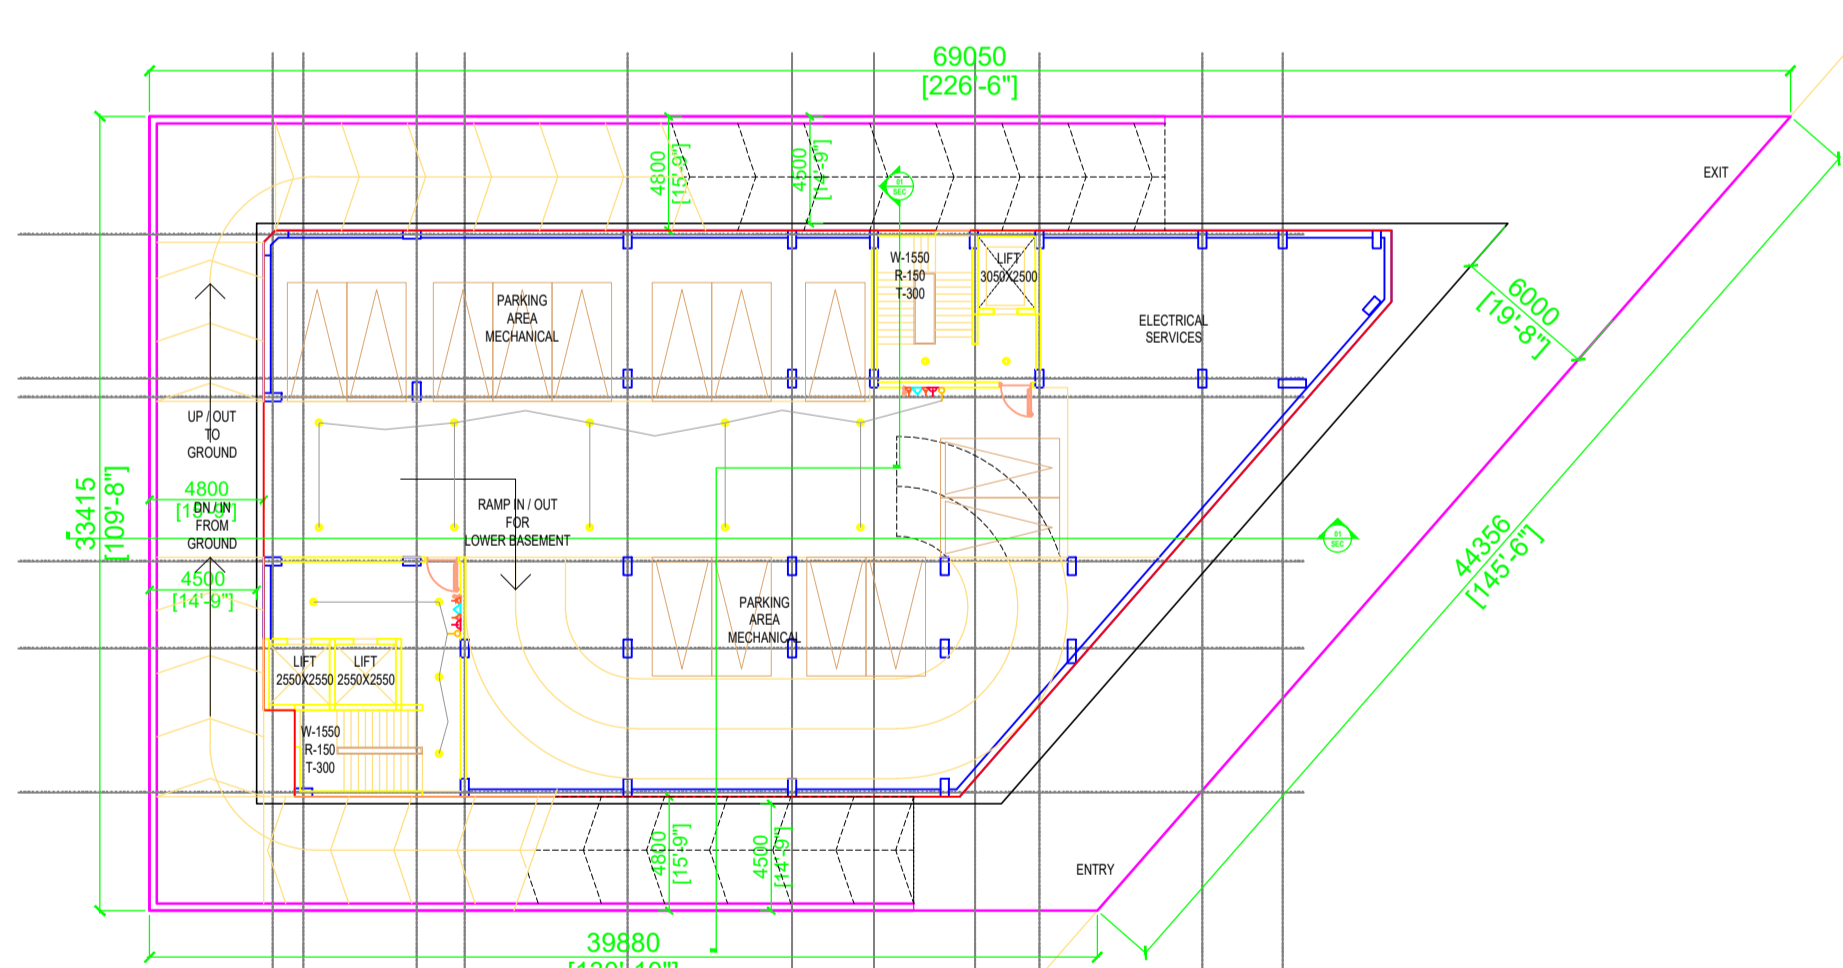


BASEMENT 01
SCALE 1:200

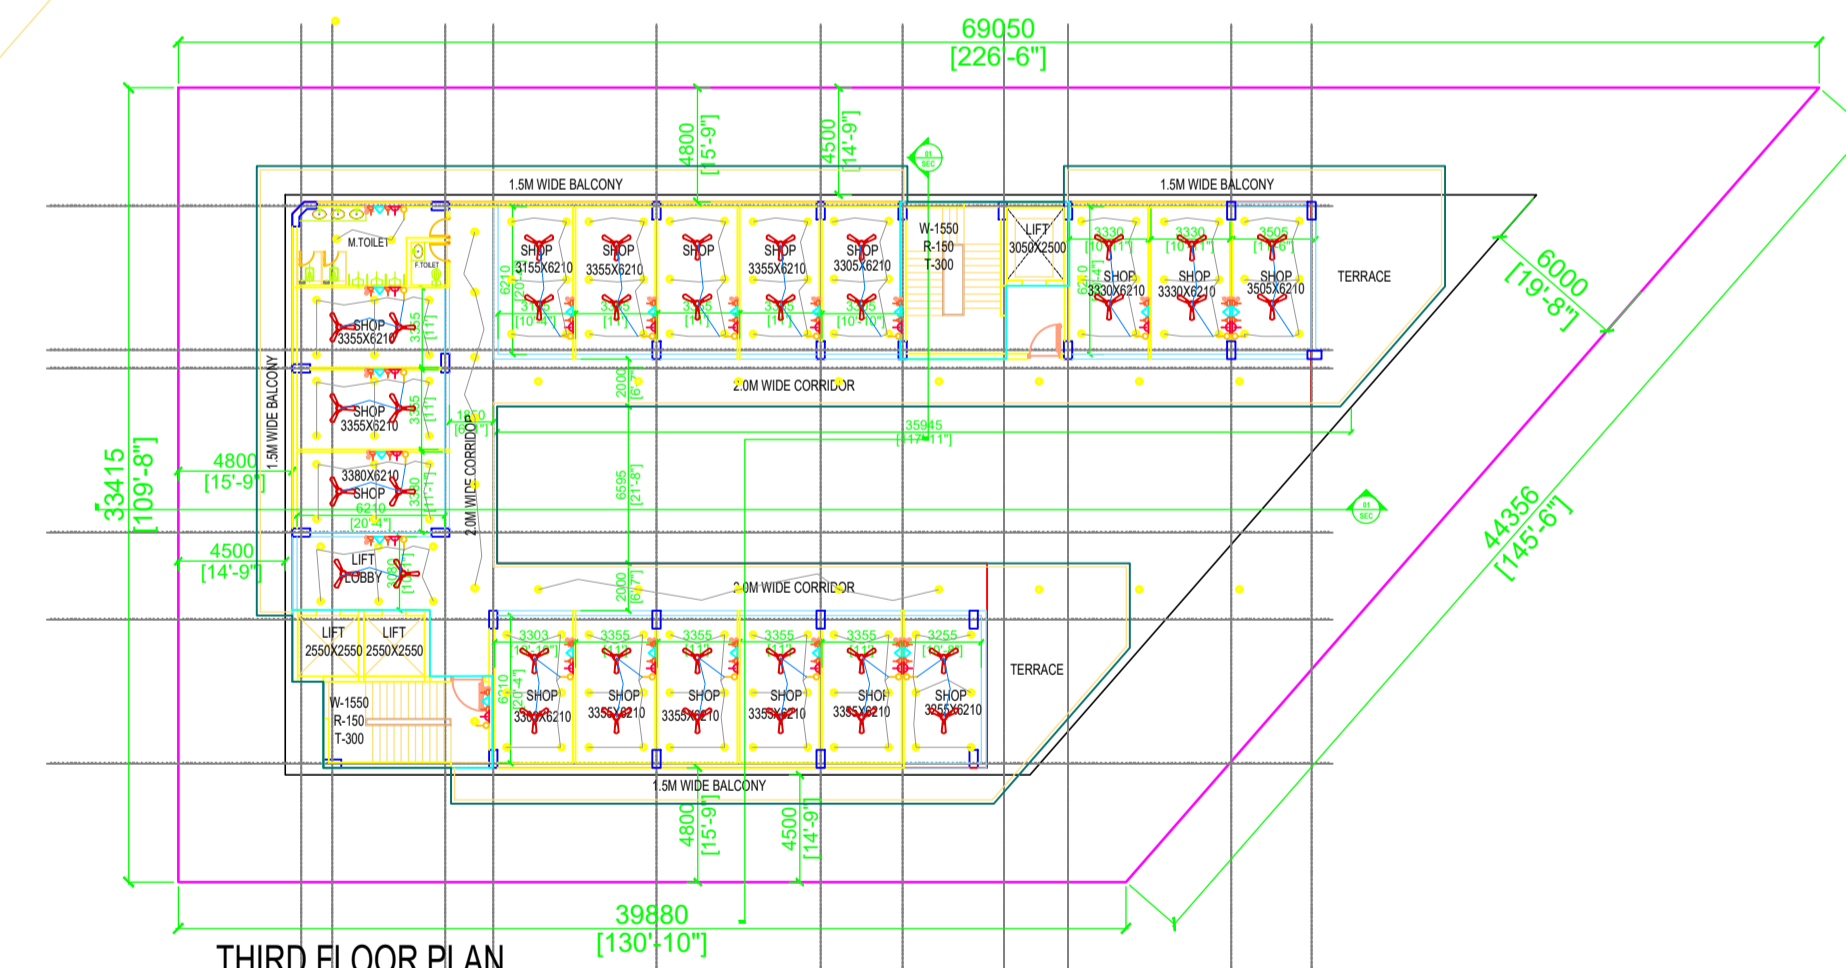


THIRD FLOOR PLAN
SCALE 1:200

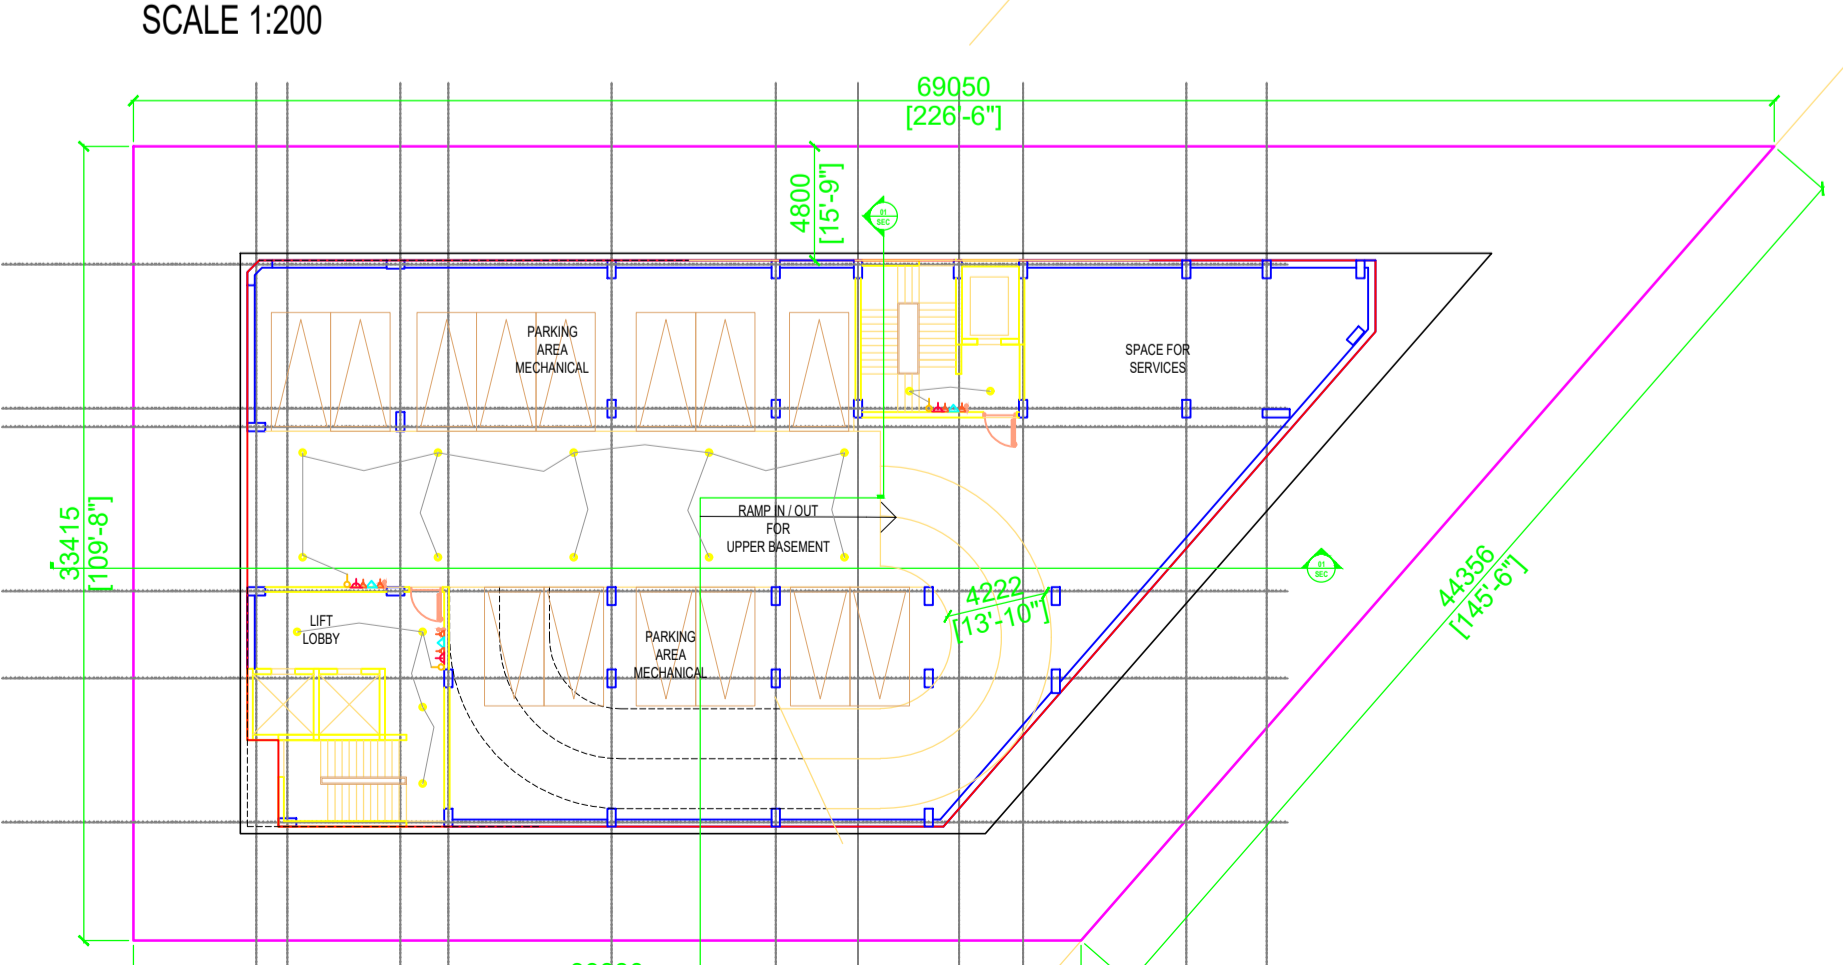

BASEMENT 2
SCALE 1:200

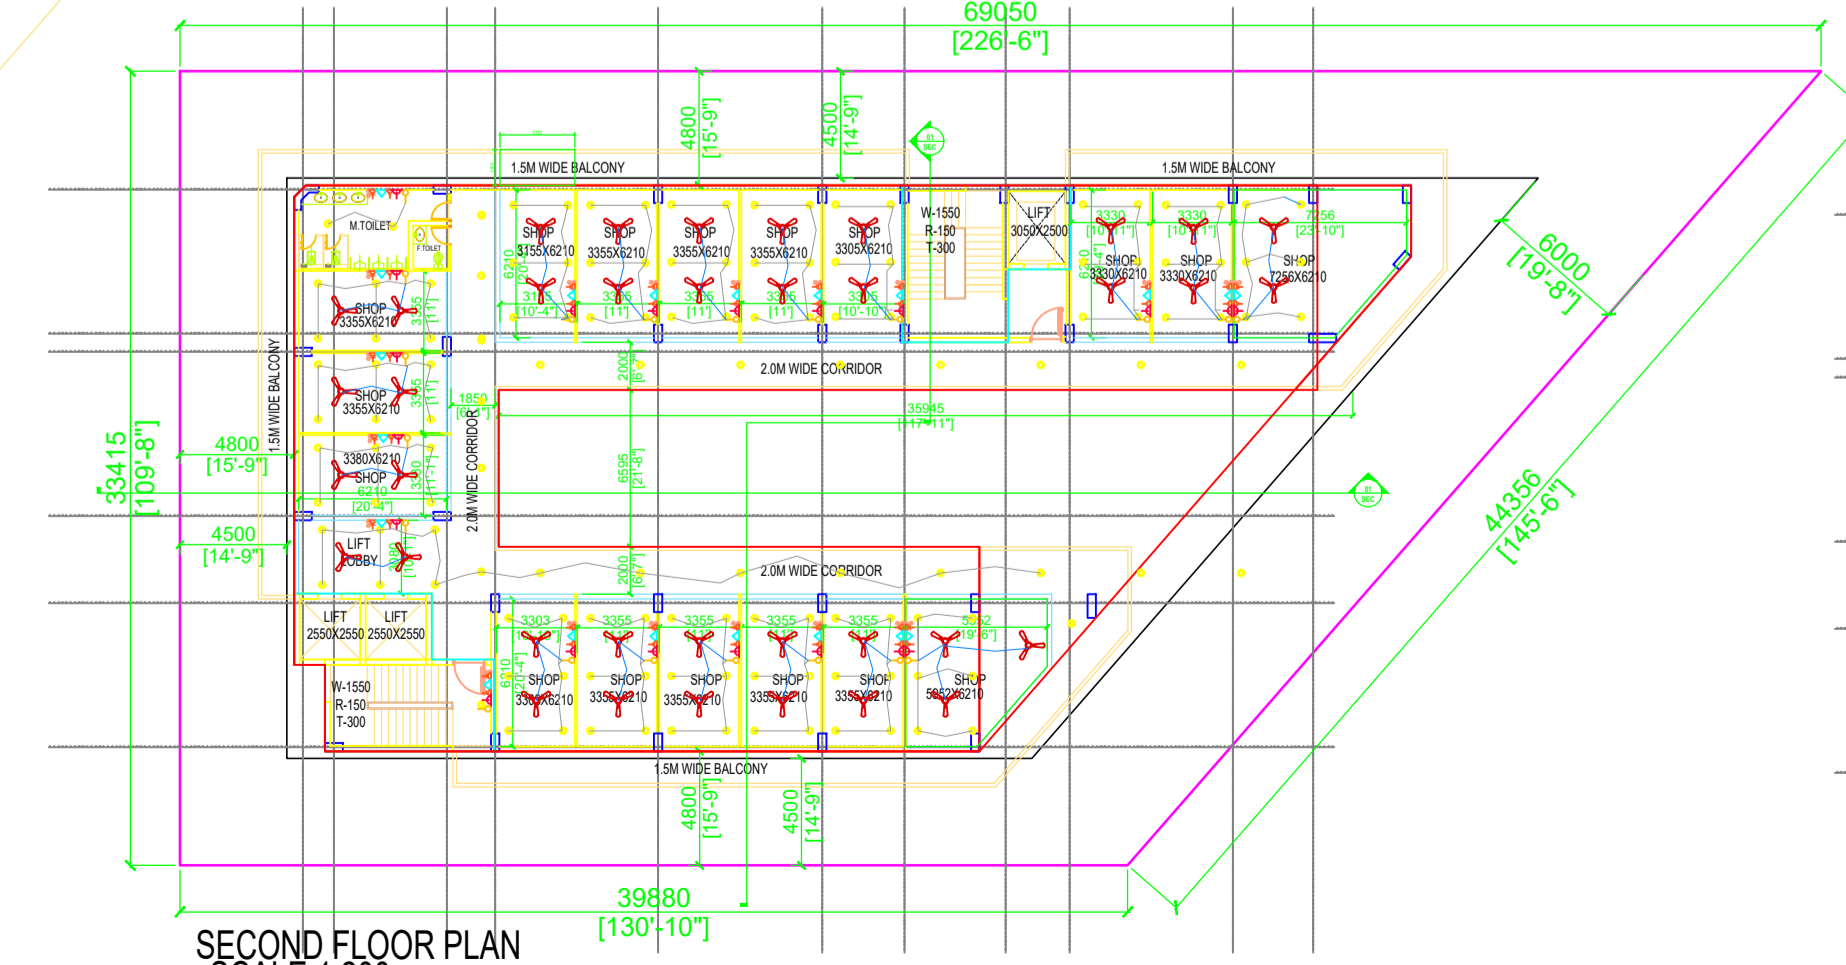

SECOND FLOOR PLAN
SCALE 1:200

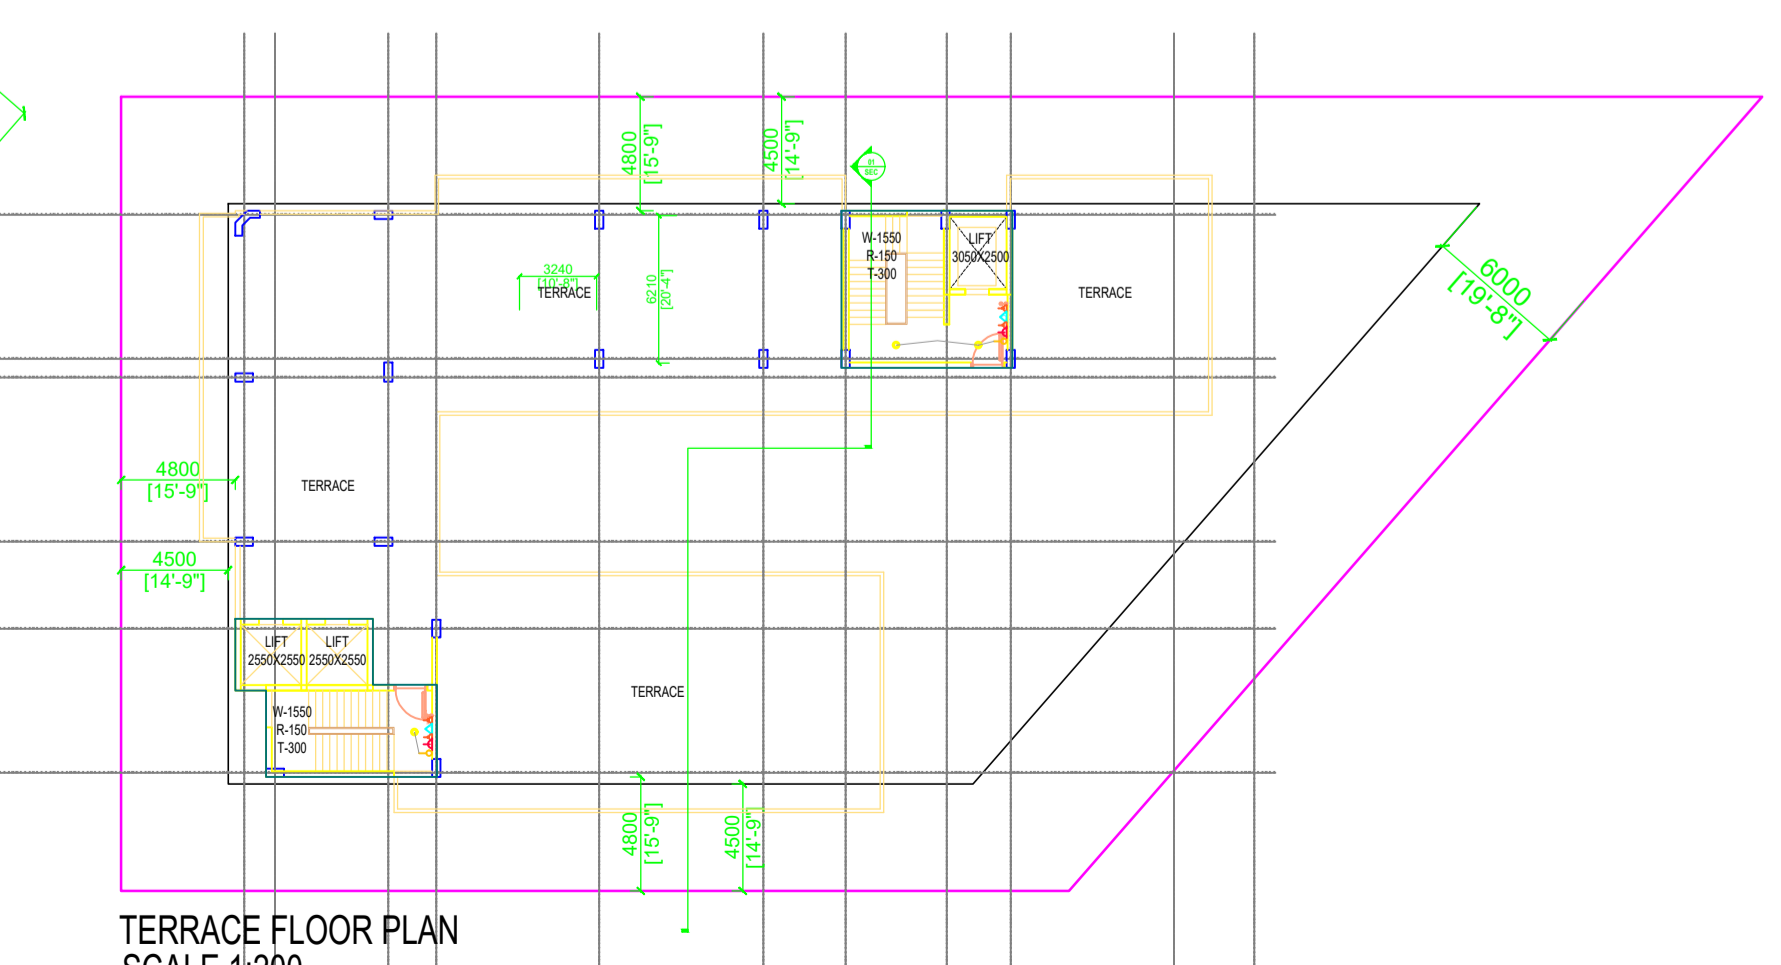

TERRACE FLOOR PLAN
SCALE 1:200

1 DIMENSIONAL LEVELS INDICATED ARE STRUCTURAL UNLESS OTHERWISE SPECIFIED.
2 THE DRAWING UNLESS OTHERWISE SPECIFIED, TO BE PLOTTED TO STANDARD PAPER SIZE.
3 ALL DIMENSIONS ARE TO BE IN METERS UNLESS OTHERWISE SPECIFIED.
4 ALL DIMENSIONS ARE TO BE IN METERS UNLESS OTHERWISE SPECIFIED.
5 ALL DIMENSIONS ARE TO BE IN METERS UNLESS OTHERWISE SPECIFIED.
6 ALL DIMENSIONS ARE TO BE IN METERS UNLESS OTHERWISE SPECIFIED.
7 ALL DIMENSIONS ARE TO BE IN METERS UNLESS OTHERWISE SPECIFIED.
8 ALL DIMENSIONS ARE TO BE IN METERS UNLESS OTHERWISE SPECIFIED.

NO	DATE	NAME	NAME	DESCRIPTION OF THE REVISIONS
NO	DATE	NAME	NAME	DESCRIPTION OF THE REVISIONS

SN	DESCRIPTIONS	SYM	HGT(M)
1.	CEILING FAN BOX	Y	CEILING
2.	CEILING LIGHT JNL. BOX	Y	CEILING
3.	CONCEALED LIGHT	Y	CEILING
4.	5A SOCKET FOR TV	Y	1050
5.	WALL BRACKET	Y	1950
6.	EXHAUST FAN	Y	VENT.
7.	SWITCH BOARD	Y	1200
8.	TWO WAY SWITCH BOARD	Y	1200
9.	5A SOCKET	Y	1200
10.	SDB	Y	1200
11.	PDB	Y	1200
12.	COMPUTER POINT	Y	300
13.	5A SOCKET WITH 15A SWITCH	Y	300
14.	TELEPHONE POINT	Y	300
15.	15A SOCKET WITH SWITCH	Y	450
16.	5A SOCKET WITH SWITCH	Y	800
17.	AC POINT	Y	2100
18.	WALL FAN POINT	Y	1950
19.	5A SOCKETS	Y	600
20.	BELL PUSH	Y	300
21.	TV POINT	Y	900
22.	25A TPK METAL CLAD SOCKET WITH MCB	Y	300
23.	5A TPK METAL CLAD SOCKET WITH MCB	Y	300
24.	NURSE/PARENT CALLING DISPLAY	Y	2400
25.	BUIZER	Y	HOME DOOR
26.	UPS DB	Y	1200
27.	5A SOCKET FOR VIEW BOX	Y	900
28.	15A SOCKET WITH SWITCH	Y	ANEX. SLAB
29.	CEILING MOUNTED PROJECTOR	Y	CEILING
30.	CCTV	Y	2400
31.	EMERGENCY LIGHT	Y	CEILING
32.	SINGLE PHASE POWER POINT	Y	CEILING
33.	THREE PHASE POWER POINT	Y	CEILING

- 300MM WIDE CABLE TRAY FOR ELE. SERVICES.
- 300MM WIDE CABLE TRAY FOR LV. SERVICES.
- 300MM Ø R.C.C. HUME PIPE
- 600MMX600MM CHAMBER
- UNDERGROUND LT CABLE

OWNER SIGN & STAMP

- 25MM Ø PVC LIGHT CONDUIT IN SLAB
- 25MM Ø PVC MAIN CONDUIT IN SLAB
- 25MM Ø PVC POWER CONDUIT IN SLAB
- 32MM Ø PVC CONDUIT IN SLAB FOR AHU
- 300MM WIDE CABLE TRAY (2 TIER)
- 25MM Ø PVC CONDUIT IN SLAB

ARCHITECT SIGN & STAMP



PROJECT:

UNIWEST AERO HUB
KH - 112, MIRZAPUR PARGANA
DANKAUR
TH - G.B NAGAR, DISTT - G.B. NAGAR

CLIENT:

UNIWEST INFRA TECH PVT LTD

PROJECT ARCHITECTS:

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TAIMOOR NAGAR NEW FRIENDS COLONY
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DELHI-LUCKNOW-MEERUT

PURPOSE OF RELEASE:

ELECTRICAL SUPPLY PLAN

STAGE:	SUBMISSION
DIRECTION:	Drawing No: _____ Current Revision: R0
Start Date:	Issue Date: _____ Last saved Date: _____
Project Code:	MRL
Bidding/Block:	MASTER PLAN
Floor:	
Drawing title:	SUBMISSION DRAWING
File path:	C:\Users\ASUS\Downloads\Suboib\J New Block 3 (1).dwg

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