

Greater Noida Industrial Development Authority

Plot No. -01, Knowledge Park-4, Greater Noida

PLG/(BP).3385/1.1/4241

Dated. 27/06/2019

To,

M/s A.L. SOFTWEB Pvt. Ltd.

**PLOT NO.-3&4, II nd FLOOR, A-BLOCK MARKET,
PREET VIHAR, NEW DELHI- 110092**

Sir,

CONDITIONAL with respect point no 17 vis-à-vis notification 60(A) dated 27-1-1994 and its amendment from time to time and notification dated 14-09-2006 issued by Ministry of Environment & Forest and point no. 18 vis-à-vis guidelines dt.15.11.2012 of C.G.W.A.

With reference to your application no- 43965, dated- 19.06.2019 for grant of **Sanction of Building Plan of I.T. Building on Plot No -07, SECTOR -TECHZONE-4, Greater Noida**. This is to inform you that the sanction is being granted by the Authority with the following conditions:

1. This sanction is being granted under the provision of 'The Greater Noida Industrial Development Area Building Regulation 2010.
2. The validity of sanction is **up to-5 Years**
3. In case allotment is cancelled/lease in determine for whatsoever reason by functional department, aforesaid sanction shall automatically be deemed to have been withdrawn.
4. During this period, after the completion of construction it is necessary to apply for occupancy certificate. **Time extension charge shall be payable as applicable.**
5. If demanded by the Authority. You shall be liable to pay charges for the provision of any further facilities/development/improvement.
6. A copy of the sanction drawing shall always be kept at site and shall be made available to any officer of the Authority on demand.
7. No addition/alteration is permitted in the sanctioned drawings. For any changes prior permission form the Authority required.
8. You shall be responsible for carrying out the work in accordance with the requirements of Greater Noida Industrial Development Building Regulation 2010. And direction made form time to time.
9. Prior permission is required before digging an under ground bore well.
10. No activity other than as specified in lease deed shall be permitted in the premises.
11. Prior permission is from the Authority is required for temporary structure also like labour huts & site office
12. Gate shall open on to the service road only. Direct access to the main carriageway shall not be provided.
13. Services, rain water harvesting shall be laid as per approval of Authority.
14. No parking of any kind shall be permitted on r/w of road.
15. Pejometer shall have to be installed as per direction issued by Authority.
16. Complying with all the requirement for obtaining NOC from various departments prior to submission of application for occupancy shall be the responsibility of allottee irrespective of the proposal sanctioned by GNIDA.
17. **Before starting construction, the NOC is required from Ministry of Environment & Forest under notification no-60(A) dated 27-1-1994 and its amendment from time to time or under notification dated 14-09-2006 which ever is applicable. The copy of shall be submitted to the Authority. If construction is started before obtaining the NOC, the sanction shall be treated as cancelled.**
18. **Before starting construction, the NOC is required from Central Ground Water Authority under notification dated 15.11.2012. The copy of N.O.C. from C.G.W.A. shall be submitted to the Authority. If construction is started before obtaining the NOC, the sanction shall be treated as cancelled.**
19. Mechanical ventilation to be provided in the basement as per I.S Code
20. The promoters shall follow provisions of UP Apartment Act, 2010 and its applicability to the project as per defined rules and amendments made in future. As per the provision of UP Apartment Rules 2011.
21. The construction on the plot shall have to be done in accordance with the provision of MOEF Guidelines 2010 and Hon'ble NGT orders form time to time in this regard.
22. The promoters shall inform the office of Planning Department for site visit when construction upto plinth level and Gr. Floor Slab level is reached. After clearance from planning department the promoter can go ahead with Construction beyond plinth level & Ground Floor Slab.

Yours faithfully

TOWN PLANNER

TOWN PLANNER

Encl: Copy of sanctioned drawings ()

Copy to: G.M. (Engg.) for information and n.a./ Manager (I.T) for information and n.a



उत्तर प्रदेश UTTAR PRADESH Affidavit Cum Undertaking

EZ 274158

Uttar Pradesh Real Estate Regulatory Authority
Naveen Bhavan, Rajya Niyojan Sansthan
Kala Kankar House, Old Hyderabad,
Lucknow - 226007

Subject : Central Ground Water NOC for the purpose of Project Construction - Grandthum (Phase I, II, III, IV, V), Greater Noida West.

Dear Sir,

We hereby confirm that as per the norms we shall not be using the Central Ground Water for construction of the project. We have a provision of STP treated water which shall be used for the project construction.

At the time of completion of project NOC shall be applied from Central Ground Water Authority for domestic use only.

A.L. Software PVT. LTD.

Authorized Signatory/Director
Director

A. L. SOFTWARE PVT. LTD.


Authorized Signatory/Director



ATTESTED

YOGENDRA SINGH
NOTARY NOIDA
G.B. Nagar (U.P.) INDIA

20 JUL 2019

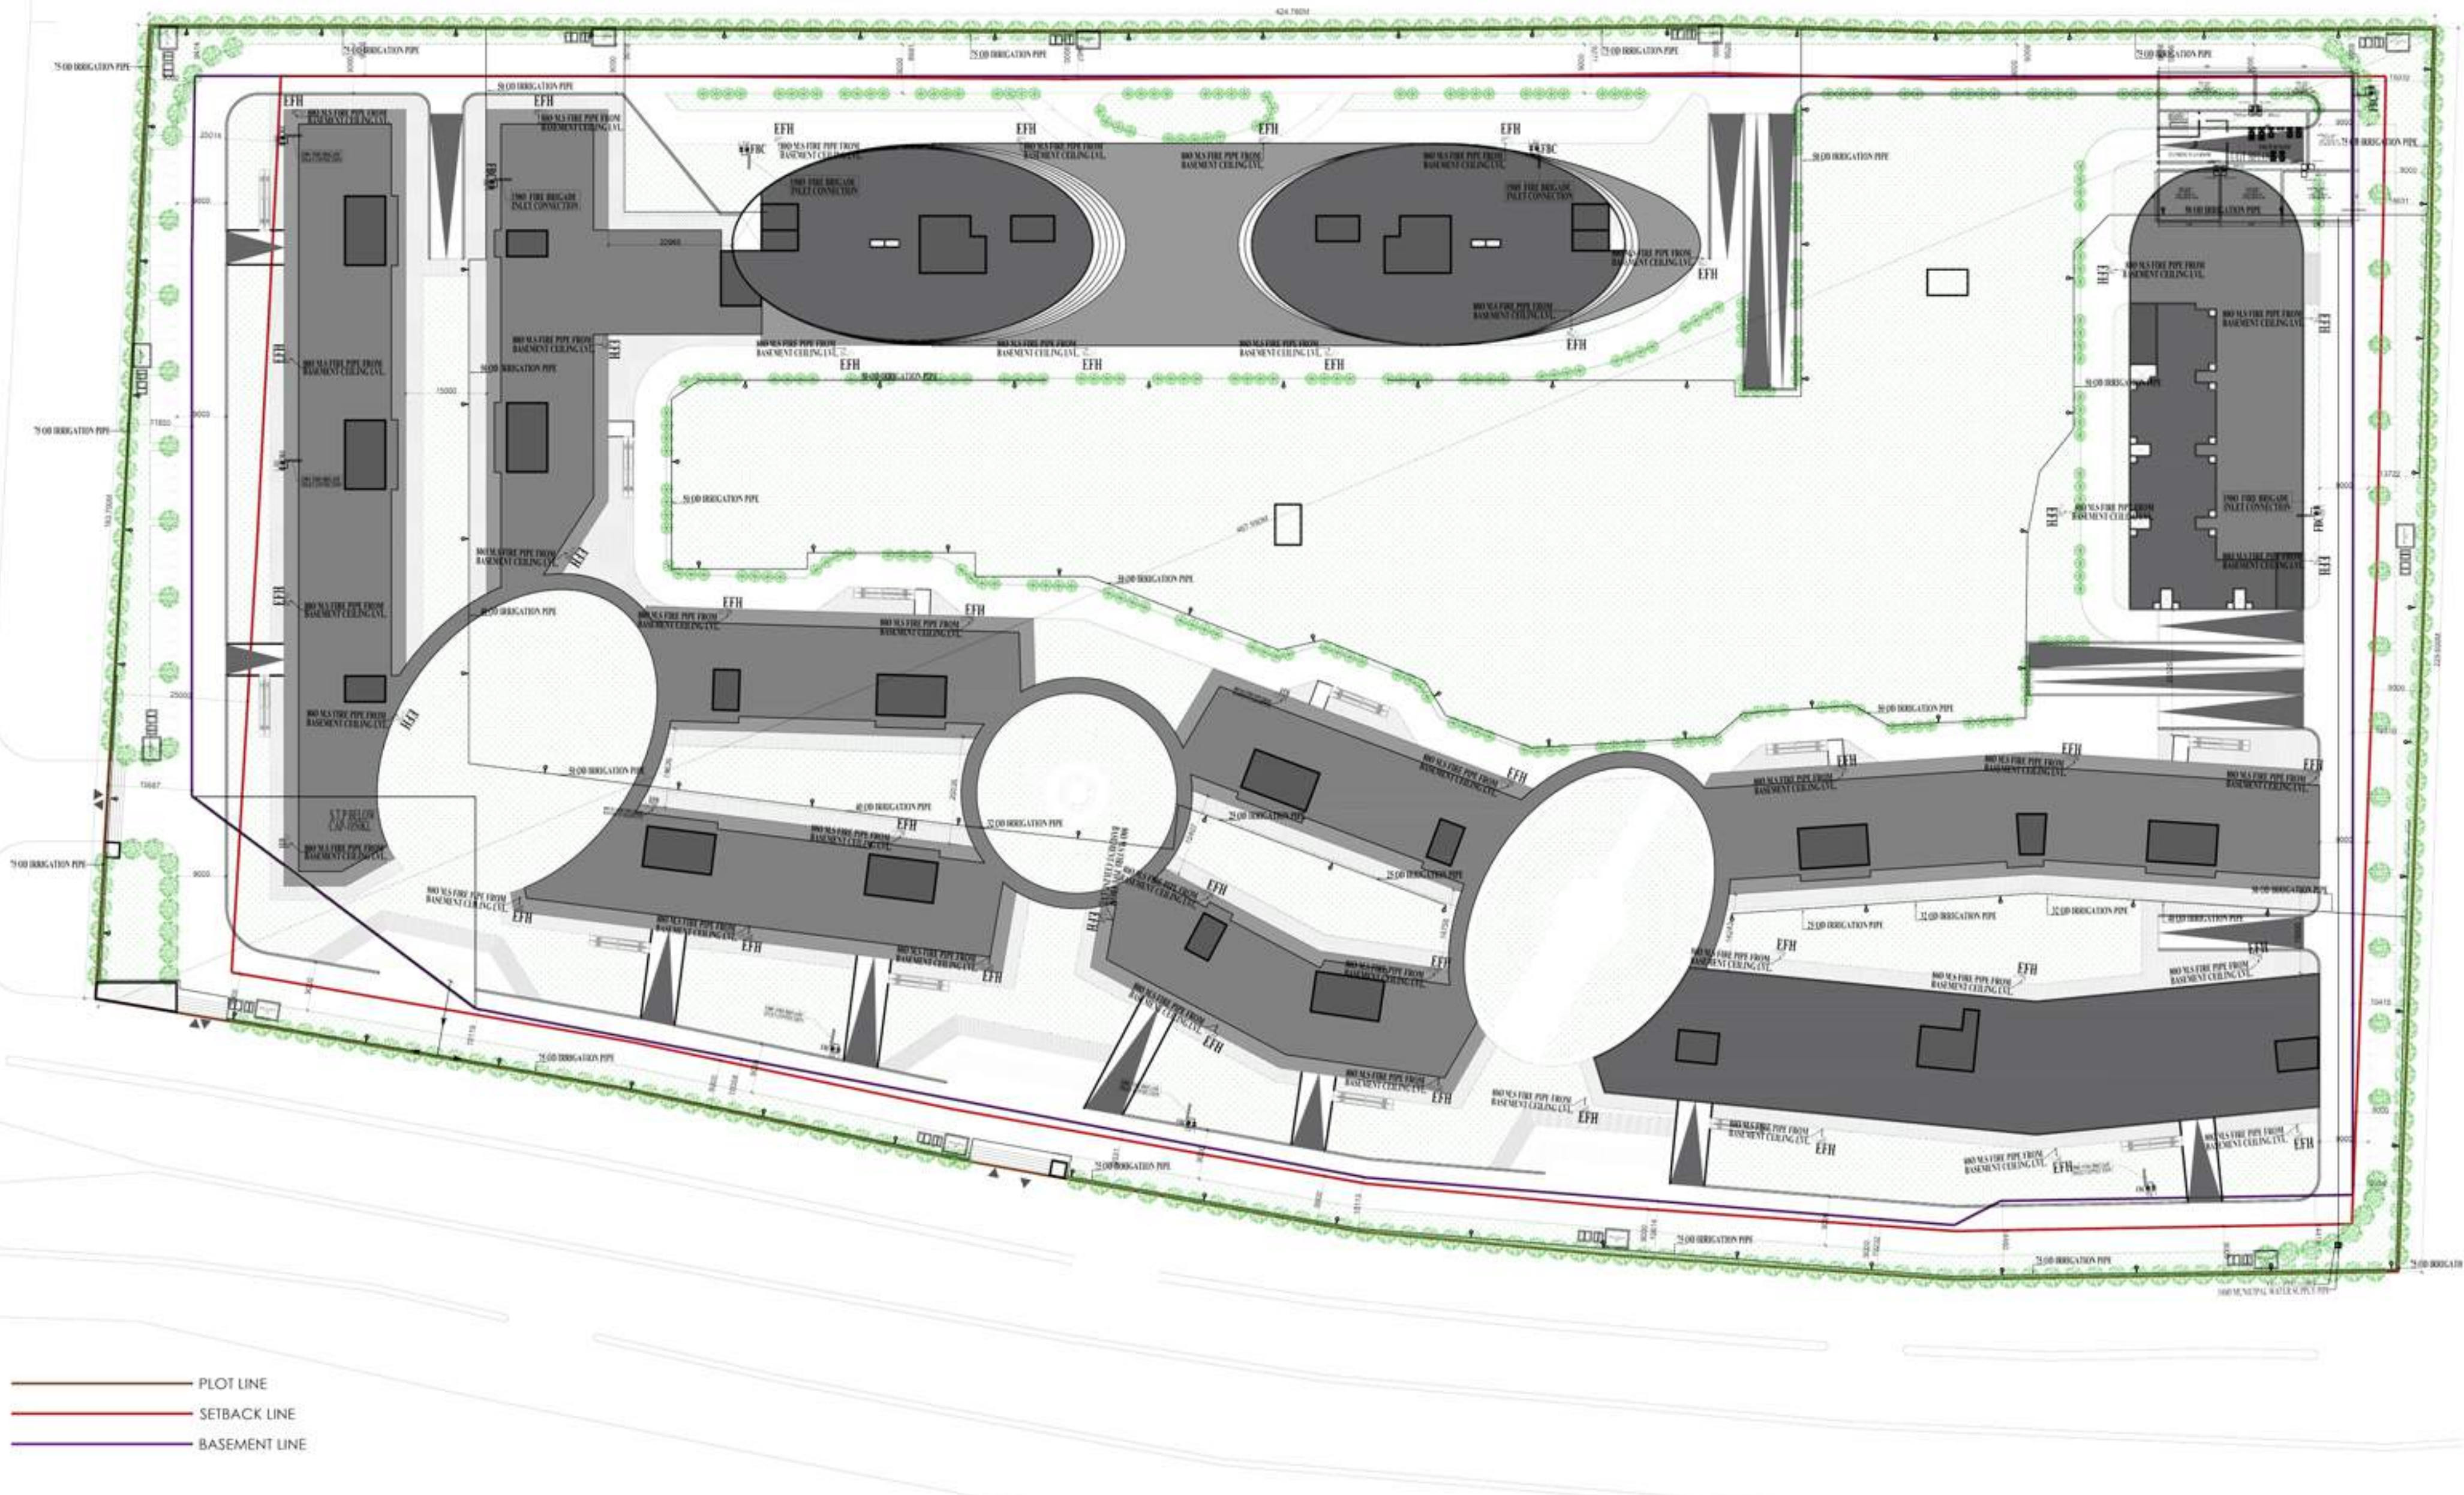

— PLOT LINE
 — SETBACK LINE
 — BASEMENT LINE

PLUMBING LEGEND:-

	SEWER LINE
	STORM WATER LINE
	MUNICIPAL WATER SUPPLY PIPE
	TANKER WATER SUPPLY PIPE
GL	GROUND LEVEL
IL	INVERT LEVEL
CL	CONNECTION LEVEL
R.W.H	RAIN WATER HARVESTING PIT
	DRAINAGE MANHOLE
CB	CATCH BASIN (450X450)
	SEWER MANHOLE
	EXTERNAL FIRE HYDRANT
	FIRE BRIGADE CONNECTION
	EXTERNAL GARDEN HYDRANT
	VALVE

PROPOSED INSTITUTIONAL BUILDING AT SECTOR TECH ZONE-4, PLOT-7, GREATER NOIDA

Sl. No.	Description	Unit	Quantity	Rate	Amount
1	Site Development	Sq. Mtr.	10000	100	1000000
2	Foundation	Sq. Mtr.	10000	200	2000000
3	Structure	Sq. Mtr.	10000	300	3000000
4	Roofing	Sq. Mtr.	10000	150	1500000
5	Plumbing	Sq. Mtr.	10000	100	1000000
6	Electrical	Sq. Mtr.	10000	100	1000000
7	Painting	Sq. Mtr.	10000	50	500000
8	Landscaping	Sq. Mtr.	10000	50	500000
9	Other	Sq. Mtr.	10000	50	500000
10	Contingency	Sq. Mtr.	10000	50	500000
11	Professional Fees	Sq. Mtr.	10000	50	500000
12	Other	Sq. Mtr.	10000	50	500000
13	Contingency	Sq. Mtr.	10000	50	500000
14	Other	Sq. Mtr.	10000	50	500000
15	Contingency	Sq. Mtr.	10000	50	500000
16	Other	Sq. Mtr.	10000	50	500000
17	Contingency	Sq. Mtr.	10000	50	500000
18	Other	Sq. Mtr.	10000	50	500000
19	Contingency	Sq. Mtr.	10000	50	500000
20	Other	Sq. Mtr.	10000	50	500000

PROPOSED INSTITUTIONAL BUILDING AT SECTOR TECH ZONE-4, PLOT-7, GREATER NOIDA


Sl. No.	Description	Unit	Quantity	Rate	Amount
1	Site Development	Sq. Mtr.	10000	100	1000000
2	Foundation	Sq. Mtr.	10000	200	2000000
3	Structure	Sq. Mtr.	10000	300	3000000
4	Roofing	Sq. Mtr.	10000	150	1500000
5	Plumbing	Sq. Mtr.	10000	100	1000000
6	Electrical	Sq. Mtr.	10000	100	1000000
7	Painting	Sq. Mtr.	10000	50	500000
8	Landscaping	Sq. Mtr.	10000	50	500000
9	Other	Sq. Mtr.	10000	50	500000
10	Contingency	Sq. Mtr.	10000	50	500000
11	Professional Fees	Sq. Mtr.	10000	50	500000
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14	Other	Sq. Mtr.	10000	50	500000
15	Contingency	Sq. Mtr.	10000	50	500000
16	Other	Sq. Mtr.	10000	50	500000
17	Contingency	Sq. Mtr.	10000	50	500000
18	Other	Sq. Mtr.	10000	50	500000
19	Contingency	Sq. Mtr.	10000	50	500000
20	Other	Sq. Mtr.	10000	50	500000

PROPOSED INSTITUTIONAL BUILDING AT SECTOR TECH ZONE-4, PLOT-7, GREATER NOIDA

Sl. No.	Description	Unit	Quantity	Rate	Amount
1	Site Development	Sq. Mtr.	10000	100	1000000
2	Foundation	Sq. Mtr.	10000	200	2000000
3	Structure	Sq. Mtr.	10000	300	3000000
4	Roofing	Sq. Mtr.	10000	150	1500000
5	Plumbing	Sq. Mtr.	10000	100	1000000
6	Electrical	Sq. Mtr.	10000	100	1000000
7	Painting	Sq. Mtr.	10000	50	500000
8	Landscaping	Sq. Mtr.	10000	50	500000
9	Other	Sq. Mtr.	10000	50	500000
10	Contingency	Sq. Mtr.	10000	50	500000
11	Professional Fees	Sq. Mtr.	10000	50	500000
12	Other	Sq. Mtr.	10000	50	500000
13	Contingency	Sq. Mtr.	10000	50	500000
14	Other	Sq. Mtr.	10000	50	500000
15	Contingency	Sq. Mtr.	10000	50	500000
16	Other	Sq. Mtr.	10000	50	500000
17	Contingency	Sq. Mtr.	10000	50	500000
18	Other	Sq. Mtr.	10000	50	500000
19	Contingency	Sq. Mtr.	10000	50	500000
20	Other	Sq. Mtr.	10000	50	500000

PROPOSED INSTITUTIONAL BUILDING AT SECTOR TECH ZONE-4, PLOT-7, GREATER NOIDA

Sl. No.	Description	Unit	Quantity	Rate	Amount
1	Site Development	Sq. Mtr.	10000	100	1000000
2	Foundation	Sq. Mtr.	10000	200	2000000
3	Structure	Sq. Mtr.	10000	300	3000000
4	Roofing	Sq. Mtr.	10000	150	1500000
5	Plumbing	Sq. Mtr.	10000	100	1000000
6	Electrical	Sq. Mtr.	10000	100	1000000
7	Painting	Sq. Mtr.	10000	50	500000
8	Landscaping	Sq. Mtr.	10000	50	500000
9	Other	Sq. Mtr.	10000	50	500000
10	Contingency	Sq. Mtr.	10000	50	500000
11	Professional Fees	Sq. Mtr.	10000	50	500000
12	Other	Sq. Mtr.	10000	50	500000
13	Contingency	Sq. Mtr.	10000	50	500000
14	Other	Sq. Mtr.	10000	50	500000
15	Contingency	Sq. Mtr.	10000	50	500000
16	Other	Sq. Mtr.	10000	50	500000
17	Contingency	Sq. Mtr.	10000	50	500000
18	Other	Sq. Mtr.	10000	50	500000
19	Contingency	Sq. Mtr.	10000	50	500000
20	Other	Sq. Mtr.	10000	50	500000

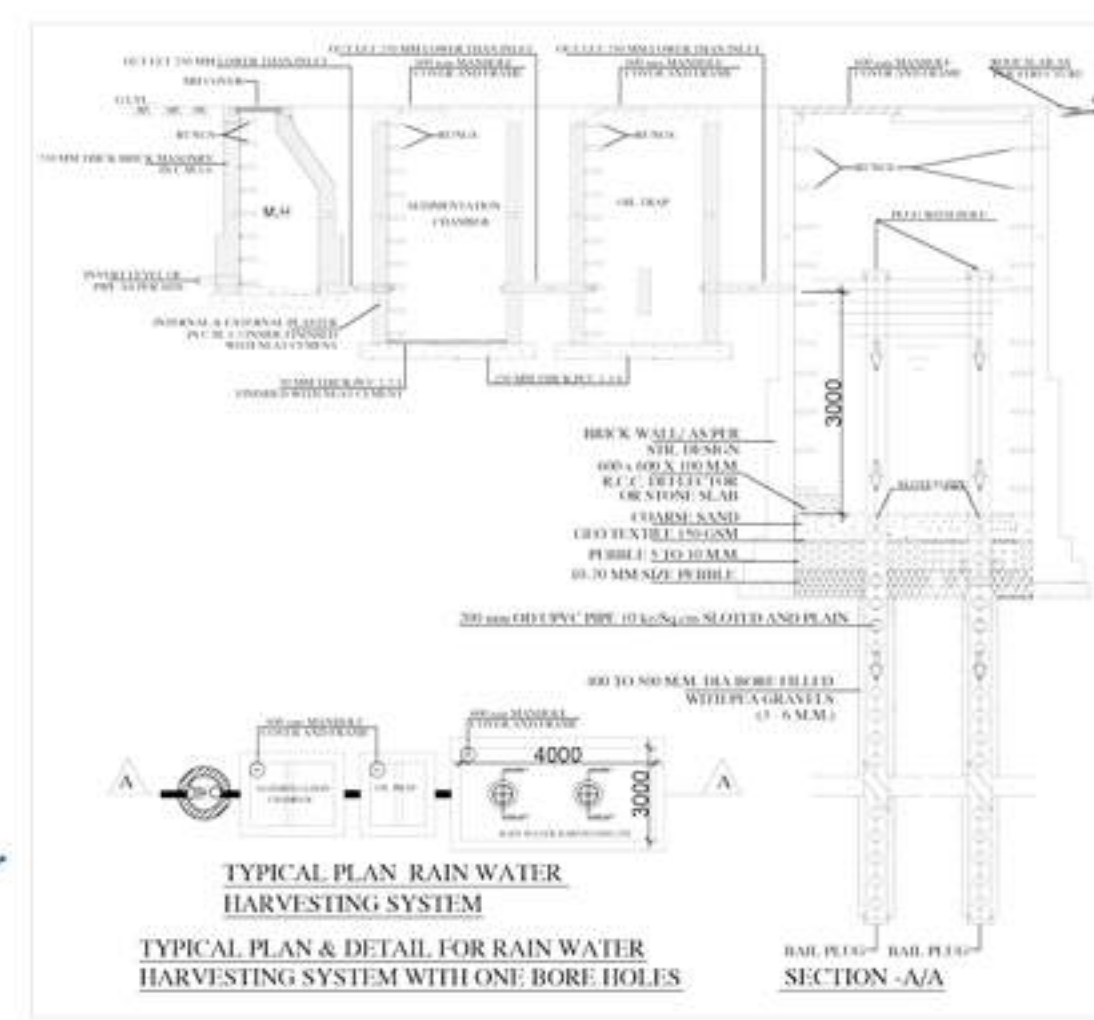

SUBMISSION

PROJECT: PROPOSED INSTITUTIONAL BUILDING AT SECTOR TECH ZONE-4, PLOT-7, GREATER NOIDA
 M/S A.L. SOFTWEB PVT.LTD.

DRAWING TITLE: SITE PLAN (WATER SUPPLY)

OWNER'S SIGN:

ARCHITECT'S SIGN:

ARCHITECT: **ACPL**
 ACPL Design Ltd.

SCALE: 1:500

DEALT BY:

DATE: 10/05/2019


DESIGN BY:

CHECKED BY:

DRG. No. PL/SIT-03

LEGEND

- ⊠ = VALVE
- ⊠M = MOTORISED VALVE
- N NRV = NON-RETURN VALVE
- H ST = STRAINER
- DWS = DOMESTIC WATER SUPPLY
- FWS = FLUSHING WATER SUPPLY
- DWR = DOMESTIC WATER RISER
- FWR = FLUSHING WATER RISER
- SWR = SOFT WATER RISER
- N/C = NORMALLY CLOSED
- N/O = NORMALLY OPEN
- SH = MINIMUM STATIC HEAD AT FLOOR LEVEL
- ⊙PRV = PRESSURE REDUCING VALVE
- ARV = AIR RELEASE VALVE
- PG = PRESSURE GAUGE
- > DOMESTIC WATER SUPPLY PIPE
- > FLUSHING WATER SUPPLY PIPE
- > SOFT WATER SUPPLY PIPE

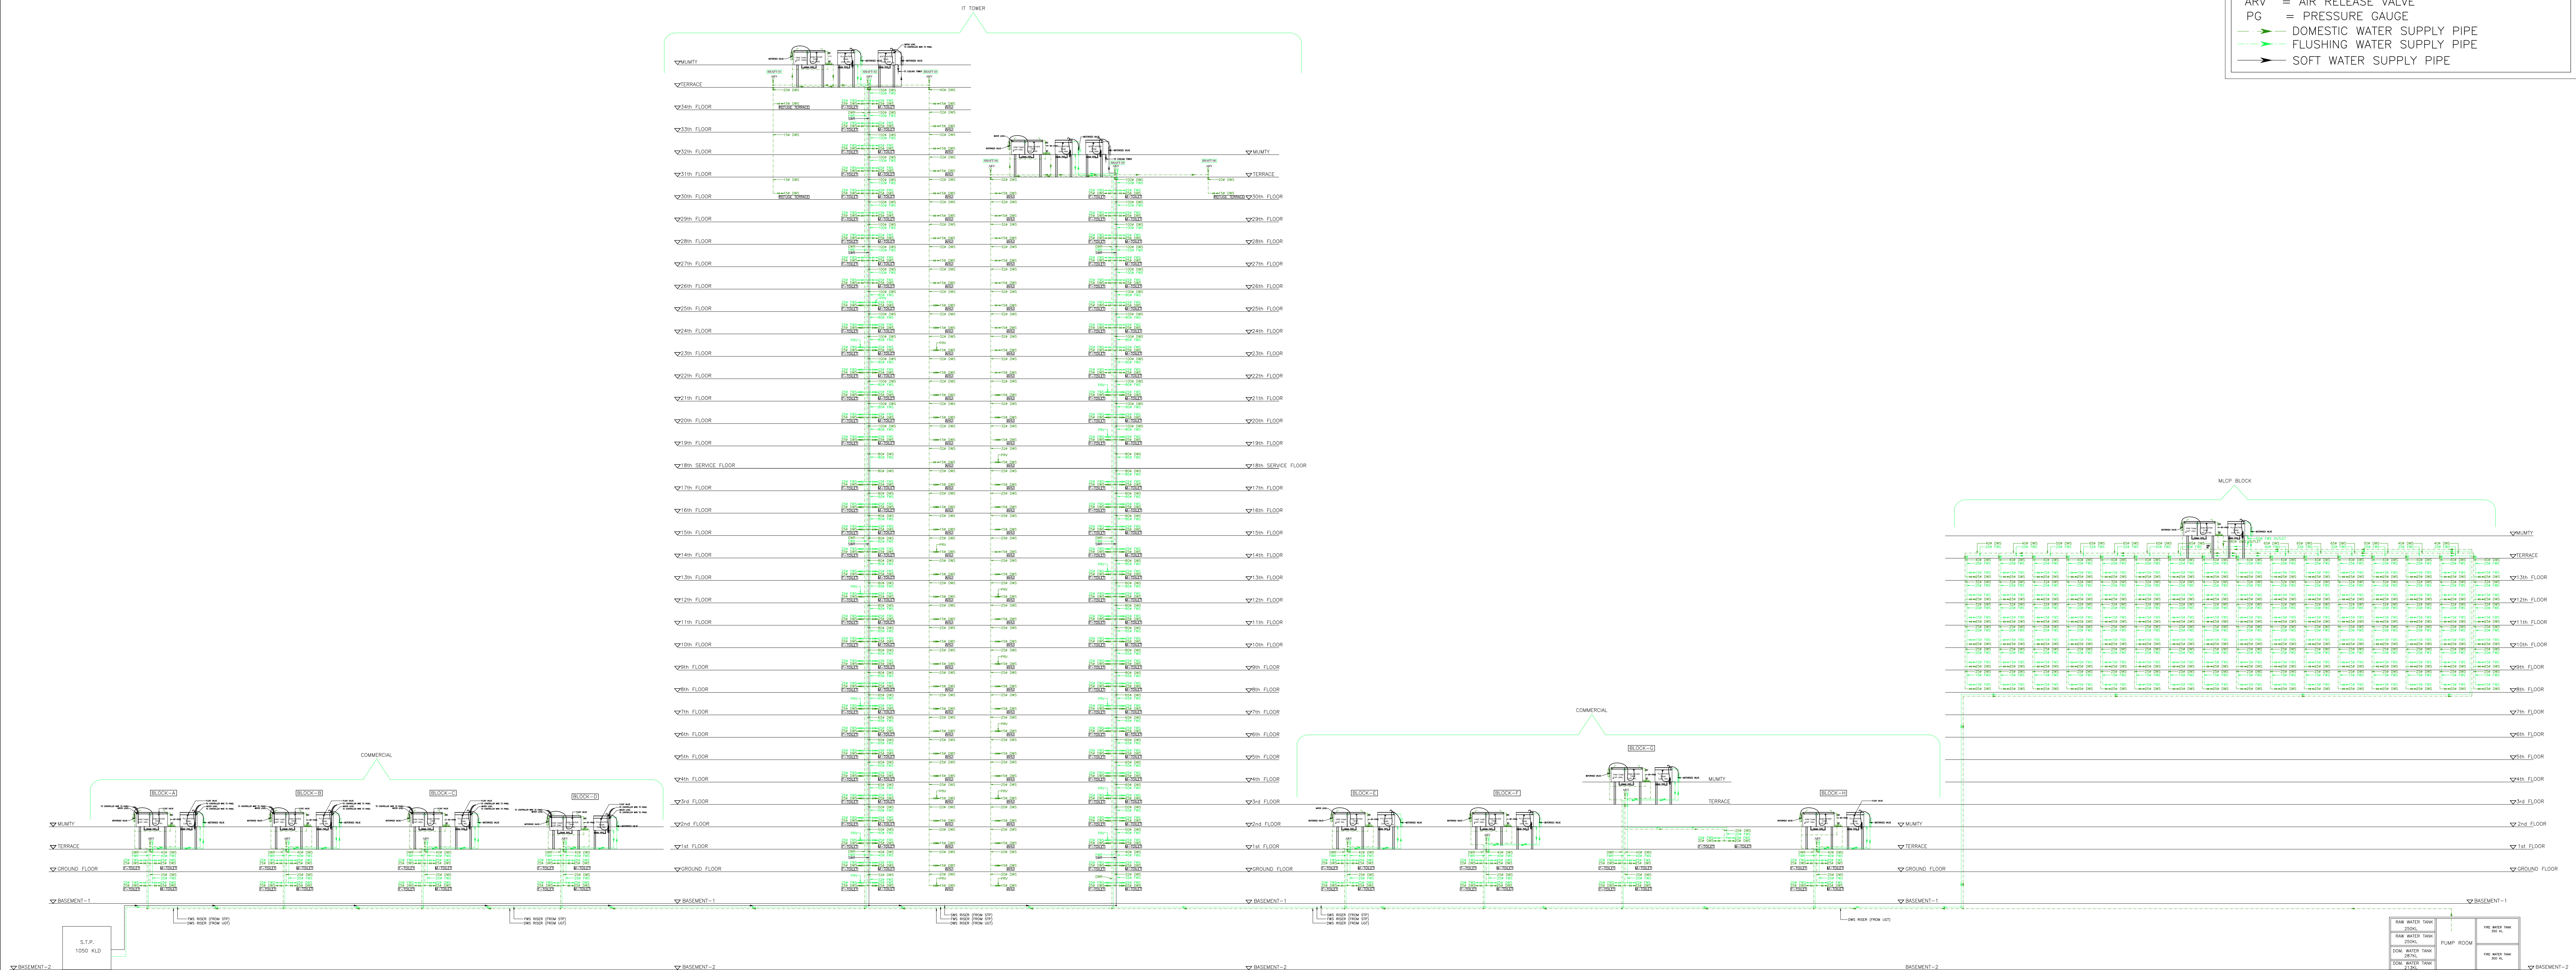

PROJECT:
**PROPOSED DEVELOPMENT FOR PLOT
 AT SECTOR TECH ZONE - 4,PLOT NO.-7
 GREATER NOIDA,BEING DEVELOPED BY-
 M/S A.L. SOFTWEB PVT.LTD.**

DRAWING TITLE :
**COMMERCIAL,MLCP & IT BLOCK
 WATER SUPPLY SCHEMATIC DIAGRAM**



A. L. SOFTWEB PVT. LTD.
 Authorized Signatory/Director

Signature of Architect

OWNER'S SIGN ARCHITECT'S SIGN.

ARCHITECT:
ACPL
 ACPL Design Ltd
 ISO 9001:2008
 Architecture
 Management
 Planning
 www.acplindia.com
 800 800 8000
 1-800-11-1111
 011-11111111
 011-11111111
 011-11111111

SCALE N.T.S. DEALT BY DATE - 30/03/2019
 DESIGN BY CHECKED BY DRG. No. PL/AL/SW/WS-01

State Level Environment Impact Assessment Authority, Uttar Pradesh

Directorate of Environment, U.P.

Vineet Khand-1, Gomti Nagar, Lucknow - 226 010

Phone : 91-522-2300 541, Fax : 91-522-2300 543

E-mail : doeuplko@yahoo.com

Website : www.seiaaup.in

To,

Shri S.K. Mittal,
S/o Shri Hukum Chand,
M/s A.L. Softweb Pvt.Ltd,
R/o 601, Geetanjali Aptment,
Delhi- 110092

Ref. No.....18...../Parya/SEAC/4506/2018

Date: 03 May, 2019

Sub: Terms of Reference for Proposed IT/ITES Project at Plot No.- 7, Sector- Techzone 4, Greater Noida, District-Gautam Buddha Nagar, U.P., M/s A.L. Softweb Pvt. Ltd.

Dear Sir,

Please refer to your application/letter dated 01-10-2018 & 20/02/2018 addressed to the Secretary, SEAC, Directorate of Environment, U.P., Lucknow on the subject as above. The matter was considered by the State Level Expert Appraisal Committee in its meeting held on dated 21/02/2019 and SEIAA in its meeting dated 02/04/2019.

A presentation was made by the project proponent along with their consultant M/s GREEN CIRCLE INC. The proponent, through the documents submitted and the presentation made, informed the committee that:-

1. The environmental clearance is sought for Proposed IT/ITES Project at Plot No.- 7, Sector- Techzone 4, Greater Noida, District-Gautam Buddha Nagar, U.P., M/s A.L. Softweb Pvt. Ltd.
2. Area details of the project:

PLOT AREA	91380 m ²
GROUND COVERAGE	27372.171 m ²
PROPOSED F.A.R. @ 1.87	170745.960 m ²
F.A.R. AREA (IT/ITES)	128018.907 m ²
F.A.R. AREA (COMMERCIAL)	17045.789 m ²
F.A.R. AREA (RESIDENTIAL)	17053.250 m ²
F.A.R. AREA (FACILITY)	8523.879 m ²
TOTAL F.A.R.	170641.825 m ²
SERVICE AREA (IT/ITES)	19164.318 m ²
SERVICE AREA (COMMERCIAL)	2184.085 m ²
SERVICE AREA (RESIDENTIAL)	2083.430 m ²
SERVICE AREA (FACILITY)	522.284 m ²
SERVICE AREA (BASEMENT)	1546.198 m ²
TOTAL PROPOSED SERVICE AREA	25500.315 m ²
BASEMENT 1	61475.171 m ²
BASEMENT 2	53867.871 m ²
TOTAL BASEMENT AREA	115343.042 m ²
NON FAR AREA	6675.765 m ²
TOTAL BUILT UP AREA	318160.947 m ²

3. Salient features of the project:

S. No.	Description	Details (Proposed)
1.	Location	Plot no -07, Techzone -IV, Greater Noida, Uttar Pradesh
2.	Geographical coordinates of the Project Site	Latitude: 28°35'6.16"N Longitude: 77°26'34.35"E
4.	Net Plot Area	91,380.000 sq m (22.58acres)
5.	Estimated Population	17,643
6.	Built-up Area	3,18,160.947 m ²
7.	Solid Waste Generated	3917 kg/day

8.	Electricity load	6250 KVA provided by State Electricity Board
9.	No. of RWH pits	6 Pits
10.	Water Requirement	Total water Demand – 838KLD
11.	Source of water	STP Treated Water + Municipal Water supply

4. Water requirement details:

S. No.	Particulars	Dwelling Units	Expected Population	Base of Calculation (lpcd)	Treated Water		Fresh Water	Total Water Consumption (KLD)
					Flushing (KLD)	Other (KLD)	Domestic (KLD)	
1.	Visitors	—	4929	15 (9 lpcd for fresh water and 6 lpcd for flushing)	29.574		44.361	73.935
2.	Staff/Residents	-	12,714	45 (30 lpcd for fresh water and 15 lpcd for flushing)	190.71		381.42	572.13
3.	Green area 31,991.291	—		@6 lit/sq.m.		191.94		191.94
Total					220.284	191.94	425.781	838.005
					412.224		425.781	
I	TOTAL WATER REQUIREMENT							838.005
(a)	Domestic water							425.781
(b)	Recycled treated water for use in flushing, green area development and DG cooling.							412.224
II	Total waste water generated							560.909
(a)	80 % of fresh water							340.625
(b)	100% of flush water							220.284
III	TOTAL TREATED WATER GENERATED & its use (80 % of total waste water)							448.727
(a)	Flushing							220.284
(b)	Green Area Development							191.94
(c)	To be supplied to nearby construction site on demand							36.503

5. Parking details:

2. Parking Details:

BASEMENT PARKING					
FLOORS	PARKING AREA	SERVICE AREA	DEDUCTION	TOTAL AREA	E.C.S. @ 30
BASEMENT-2	53867.871	1546.198	6061.102	61475.171	1796
BASEMENT-1	53867.871	0.000	0.000	53867.871	1796
TOTAL	107735.742	1546.198	6061.102	115343.042	3591
SURFACE PARKING DETAIL					
WIDTH	LENGTH	NO.		AREA	
12.500	8.000	68		6800.000	
PROPOSED PARKING @ 20 E.C.S.				340	

6. The project proposal falls under category-8(b) of EIA Notification, 2006 (as amended).

The committee discussed the matter and recommended to issue the terms of reference (TOR) for the preparation of EIA regarding the project as follows:

1. All pages of technical documents/EIA/EMP etc. should be signed by the consultant and project proponent both.
2. Copy of all the analysis reports signed by analyst approved by NABL or MoEF&CC shall be annexed with the EIA report and original analysis reports should be presented at the time of presentation.
3. MOU signed between the project proponent and the consultant should be submitted.
4. Total no. of dwelling units proposed.
5. No. of ECS for car parking.

6. Second opinion about the structural stability should be submitted.
7. Master plan of the area showing proposed project. Permissible uses of the proposed site as per zoning regulation.
8. Allotment letter from concerned development authority.
9. All approved drawings/maps alongwith approved services plans.
10. Structural design certificate signed by the architect and vetting authority should be submitted. All structural design drawings should be signed by architect and counter signed by vetting authority.
11. Area details showing proposed uses as residential, commercial, parks, parking, roads, other services, facilities of the project also in percentage.
12. Physical features within 30 m of the project sites with their ownership.
13. Complete Details of facilities to be developed by the project proponent i.e. for which environment clearance is sought.
14. Use of reflecting paints on roof top and side walls.
15. Details of rain water harvesting are to be given.
16. Provision of 100% solar lighting along the road site, stair cases, common places.
17. Plan for EWS / LIG housing provision as per Development Authority bye-laws.
18. Examine in detail the proposed site with reference to impact on infrastructure covering water supply, storm water drainage, sewerage, power, etc., and the disposal of treated/raw wastes from the complex on land/water body and into sewerage system. Consider soil characteristics and permeability for rainwater harvesting proposals, should be made to prevent ground water contamination. Maximize use of treated water by recycling and utilization of rainwater.
19. Water requirement and its management plan along with necessary permissions for discharge.
20. An underground Pucca tank with kaccha base for collection/reuse of rain water may be constructed.
21. Hydro-geological investigations to be carried out and obtain permission from Central Ground Water Authority for withdrawal of ground water.
22. Make provision for safety against failure in the operation of wastewater treatment facilities. Identify acceptable outfall for treated effluent.
23. Details of green belt as a measure for mitigation of dust and noise and buffer between habitation and proposed project.
24. Landscape plan, green belts and open spaces may be described separately.
25. Study the existing flora and fauna of the area and the impact of the project on them. There should be no basement below 15 m setback. Accordingly, the Plan should be revised and submitted.
26. Section of all internal roads should be provided. Right of way and carriage way width should be clearly marked on the map. Avoid entry/exit at point of junction of roads. Traffic movement-plan in and out should be shown.
27. Examine existing crèche, education, health facilities, police, post Office, Banks and other services and make adequate provisions in the proposal.
28. Assess soil erosion in view of the soil characteristics, topography and rainfall pattern.
29. Application of renewable energy/alternate energy, such as solar and wind energy may be described including solar water heating in the guidelines for entrepreneurs.
30. Consider solid wastes, including e-waste in addition to other solid wastes and their disposal.
31. Identification of recyclable wastes and waste utilization arrangements may be made.
32. Explore possibility of generating biogas from biodegradable wastes.
33. Arrangements for hazardous waste management may be described as also the common facilities for waste collection, treatment, recycling and disposal of all effluent, emission and refuse including MSW, biomedical and hazardous wastes. Special attention should be made with respect to bird menace.
34. Provisions made for safety in storage of materials, products and wastes may be described.
35. Disaster management plan should be prepared.
36. Traffic management plan including parking and loading/unloading areas may be described. Traffic survey should be carried out both on weekdays and weekend.
37. Parking provision is to be made for higher ECS worked out either as per state bye-laws or construction manual of the MoEF. Additional parking (more than required nos. as per norms) will not be permitted.
38. Exclusive Parking area in the basement (excluding other facilities) and surface is to be clearly mentioned.
39. Provide service road for entry and exit to project site.
40. Use of local building materials should be described.

41. Consider provision of DG Flue Gas emissions to be treated in a scrubber. Stack details with provisions of sampling port for monitoring to be described. Power backup should be restricted to 50-60 % of power requirement. Plan should be revised and submitted.
42. Work out MGLC for the combined capacity of DG sets.
43. Provide for conservation of resources, energy efficiency and use of renewable sources of energy in the light of ECBC code.
44. Application of resettlement and rehabilitation policy may be described. Project affected persons should be identified and rehabilitation and resettlement plan should be prepared.
45. Examine separately the details for construction and operation phases both for Environmental Monitoring Plan and Environmental Management Plan.
46. Corporate Environmental Responsibility (CER) shall be prepared by the project proponent and the details of the various heads of expenditure to be submitted as per the guidelines provided in the recent CER notification No. 22-65/2017-IA.III dated 01/05/2018. A copy of resolution as above shall be submitted to the authority along with list of beneficiaries with their mobile nos./address.
47. Required no of trees should be proposed @ 01 tree/80 m², submit plan.
48. Project falling within 10 Km. area of Wild Life Sanctuary is to obtain a clearance from National Board Wild Life (NBWL) even if the eco- sensitive zone is not earmarked.
49. Declare/submit the running cost of STP and other environmental management services (e.g., Municipal Solid Waste Disposal, Green belt Maintenance, Water Management etc.) in the proposals which are to be including in the allotment letters. Vendors should be identified for Municipal Solid Waste Management and submitted.
50. The proponent will submit the schedule of monitoring/data collection programme to the Office of Directorate, Member Secretary, UP Pollution Control Board and District Magistrate of related District.

General Guidelines:

- a. A legal affidavit by the Project proponent on Rs. 100/- non-judicial Stamp Paper, duly attested by Public Notary, stating that:
 - I. "There is no litigation pending against the project and/or land in which the project is proposed to be set up (please give name & ownership etc. of the project) and that for any such litigation what so ever, the sole responsibility will be borne by the Project proponent."
 - II. "No activity relating to this project (i.e. name of the project) including civil construction has been undertaken at site except fencing of the site to protect it from getting encroached and construction of temporary shed(s) for the guard(s). (if fencing has not been done, then the same may be deleted).
 - III. "I/We hereby give undertaking that the data and information given in the application, enclosures and other documents are true to the best of my knowledge and belief and I/We am/are aware that if any part of the data and information submitted is found to be false or misleading at any stage, the project will be rejected and clearance given, if any to the Project will be revoked at our risk and cost."
 - IV. Project does not fall under any buffer zone of no-development as declared /identified under any law.
- b. Another legal affidavit by the consultant stating "(a) that the prescribed TORs have been complied with (to be deleted if not applicable) & (b) that details and the data presented are factually correct", as per MoEF circular dated 04.08.2009 is also to be submitted along with EIA.
- c. Current site photographs viewing towards the project area from four directions indicating date of photograph taken, direction from which taken, name of the project, and signature of Project proponent along with consultant with seal should be submitted, so as to ensure that no construction has been started before the grant of EC.
- d. EIA should strictly follow the guidelines prescribed in annexure-III to the EIA notification of 2006 and the Methods of Monitoring and analysis (Annexure-IV): Guidance for assessment of representativeness and reliability of baseline environmental attributes detailed under EIA manual January, 2001 and other guidelines in the matter.
- e. The status of accreditation of the EIA consultant with NABET/QCI shall be specifically mentioned. The consultant shall certify that his accreditation is for the sector for which this EIA is prepared.
- f. On the front page of EIA/EMP reports, the name of the consultant/consultancy firm along with their complete details including their accreditation, if any shall be indicated.

- g. While submitting the EIA/EMP reports, the name of the experts associated with/involved in the preparation of these reports and the Name of laboratory through which the samples have been got analysed should be stated in the report. It shall clearly be indicated whether said laboratory is accredited by NABL or approved under the Environment (Protection) Act, 1986 (Please refer MoEF office memorandum dated 4th August, 2009). The name project leader of the EIA study shall also be mentioned.
- h. The EIA document shall be printed on both sides, as far as possible.

The Information's no (a I , II, III & c) asked under the general guidelines is to be submitted within 15 days from the date of receipt of the letter and remaining of the information's is to be submitted along with the EIA.


This is to request you to take further necessary action in matter as per provisions of Gazette Notification No. S.O. 1533(E) dated 14/09/2006, as amended. You are advised to submit the EIA/EMP for further consideration of the matter as per procedure laid down in the Gazette Notification SO 1533(E) dated 14/09/2006 as amended. The matter will not be considered pending till your reply as above is received.



(Shruti Shukla)
Nodal, SEIAA/
Deputy Director

No...../Parya/SEAC/4506/2018 Dated: As above

Copy with enclosure for Information and necessary action to:

1. The Principal Secretary, Department of Environment, Govt. of Uttar Pradesh, Lucknow.
2. Advisor, IA Division, Ministry of Environment, Forests & Climate Change, Govt. of India, Indira Paryavaran Bhawan, Jor Bagh Road, Aliganj, New Delhi.
3. Additional Director, Regional Office, Ministry of Environment & Forests, (Central Region), Kendriya Bhawan, 5th Floor, Sector-H, Aliganj, Lucknow.
4. District Magistrate, G.B. Nagar.
5. The Member Secretary, U.P. Pollution Control Board, TC-12V, Paryavaran Bhawan, Vibhuti Khand, Gomti Nagar, Lucknow.
6. Copy to Web Master/ guard file.


(Shruti Shukla)
Nodal, SEIAA/
Deputy Director

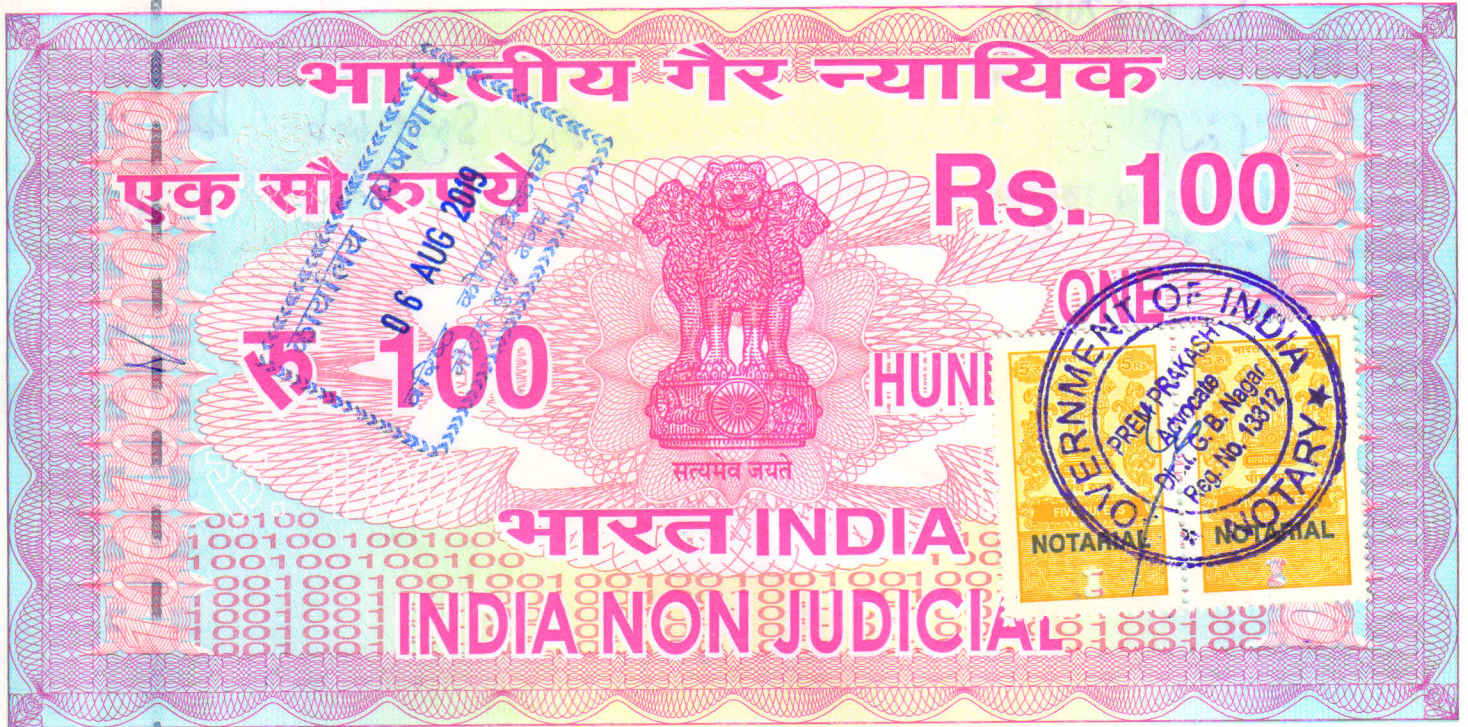

उत्तर प्रदेश UTTAR PRADESH

EZ 317949

Affidavit Cum Undertaking

Uttar Pradesh Real Estate Regulatory Authority
Naveen Bhavan, Rajya Niyojan Sansthan
Kala Kankar House, Old Hyderabad,
Lucknow – 226007

Subject : NOC against TOR for sanction of environmental clearance against construction of the project
in A.L. Softweb Pvt. Ltd, Grandthum (Phase I,II,III,IV,V), Greater Noida West.

Dear Sir,

We hereby confirm that as per the norms we shall start the construction of the project on receipt of
environment clearance from the authority at our site of A.L. Softweb Pvt. Ltd in Greater Noida West.

A.L. Softweb Pvt. Ltd

For A.L. Softweb Pvt. Ltd.

Director

[Signature]
Auth. Sign./Director



Attested

PREM PRAKASH

Notary Public
(G. B. Nagar)

1 4 AUG 2019

